Preliminary Landscape Development Plans



10.16.2020 - Per City Review #1

11.18.2020 - Per City Review #2

NAPER COMMONS

NAPERVILLE, ILLINOIS



DEVELOPER:

1900 E. Golf Road - Suite 300 Schaumburg, Illinois 60173 (847) 230.5383 voice Project Manager: Matt Brolley, P.E.

ENGINEER:

CEMCON, Ltd. 2280 White Oak Circle Aurora, Illinois 60502 (630) 862.2100 voice


Project Manager: Chris Morgart, P.E.

LANDSCAPE ARCHITECT:

Signature Design Group, Inc.

132 N. Washington Street Naperville, Illinois 60540 (630) 305.3980 voice


Project Manager: Greg G. Sagen, RLA

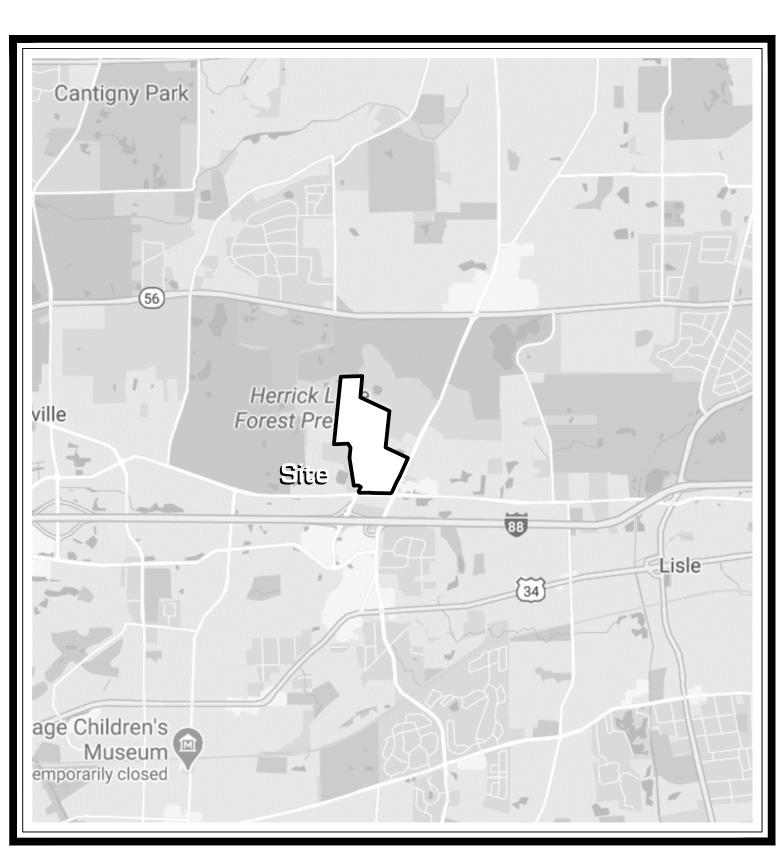

LOCATION MAP

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Notes :

Sheet Key:

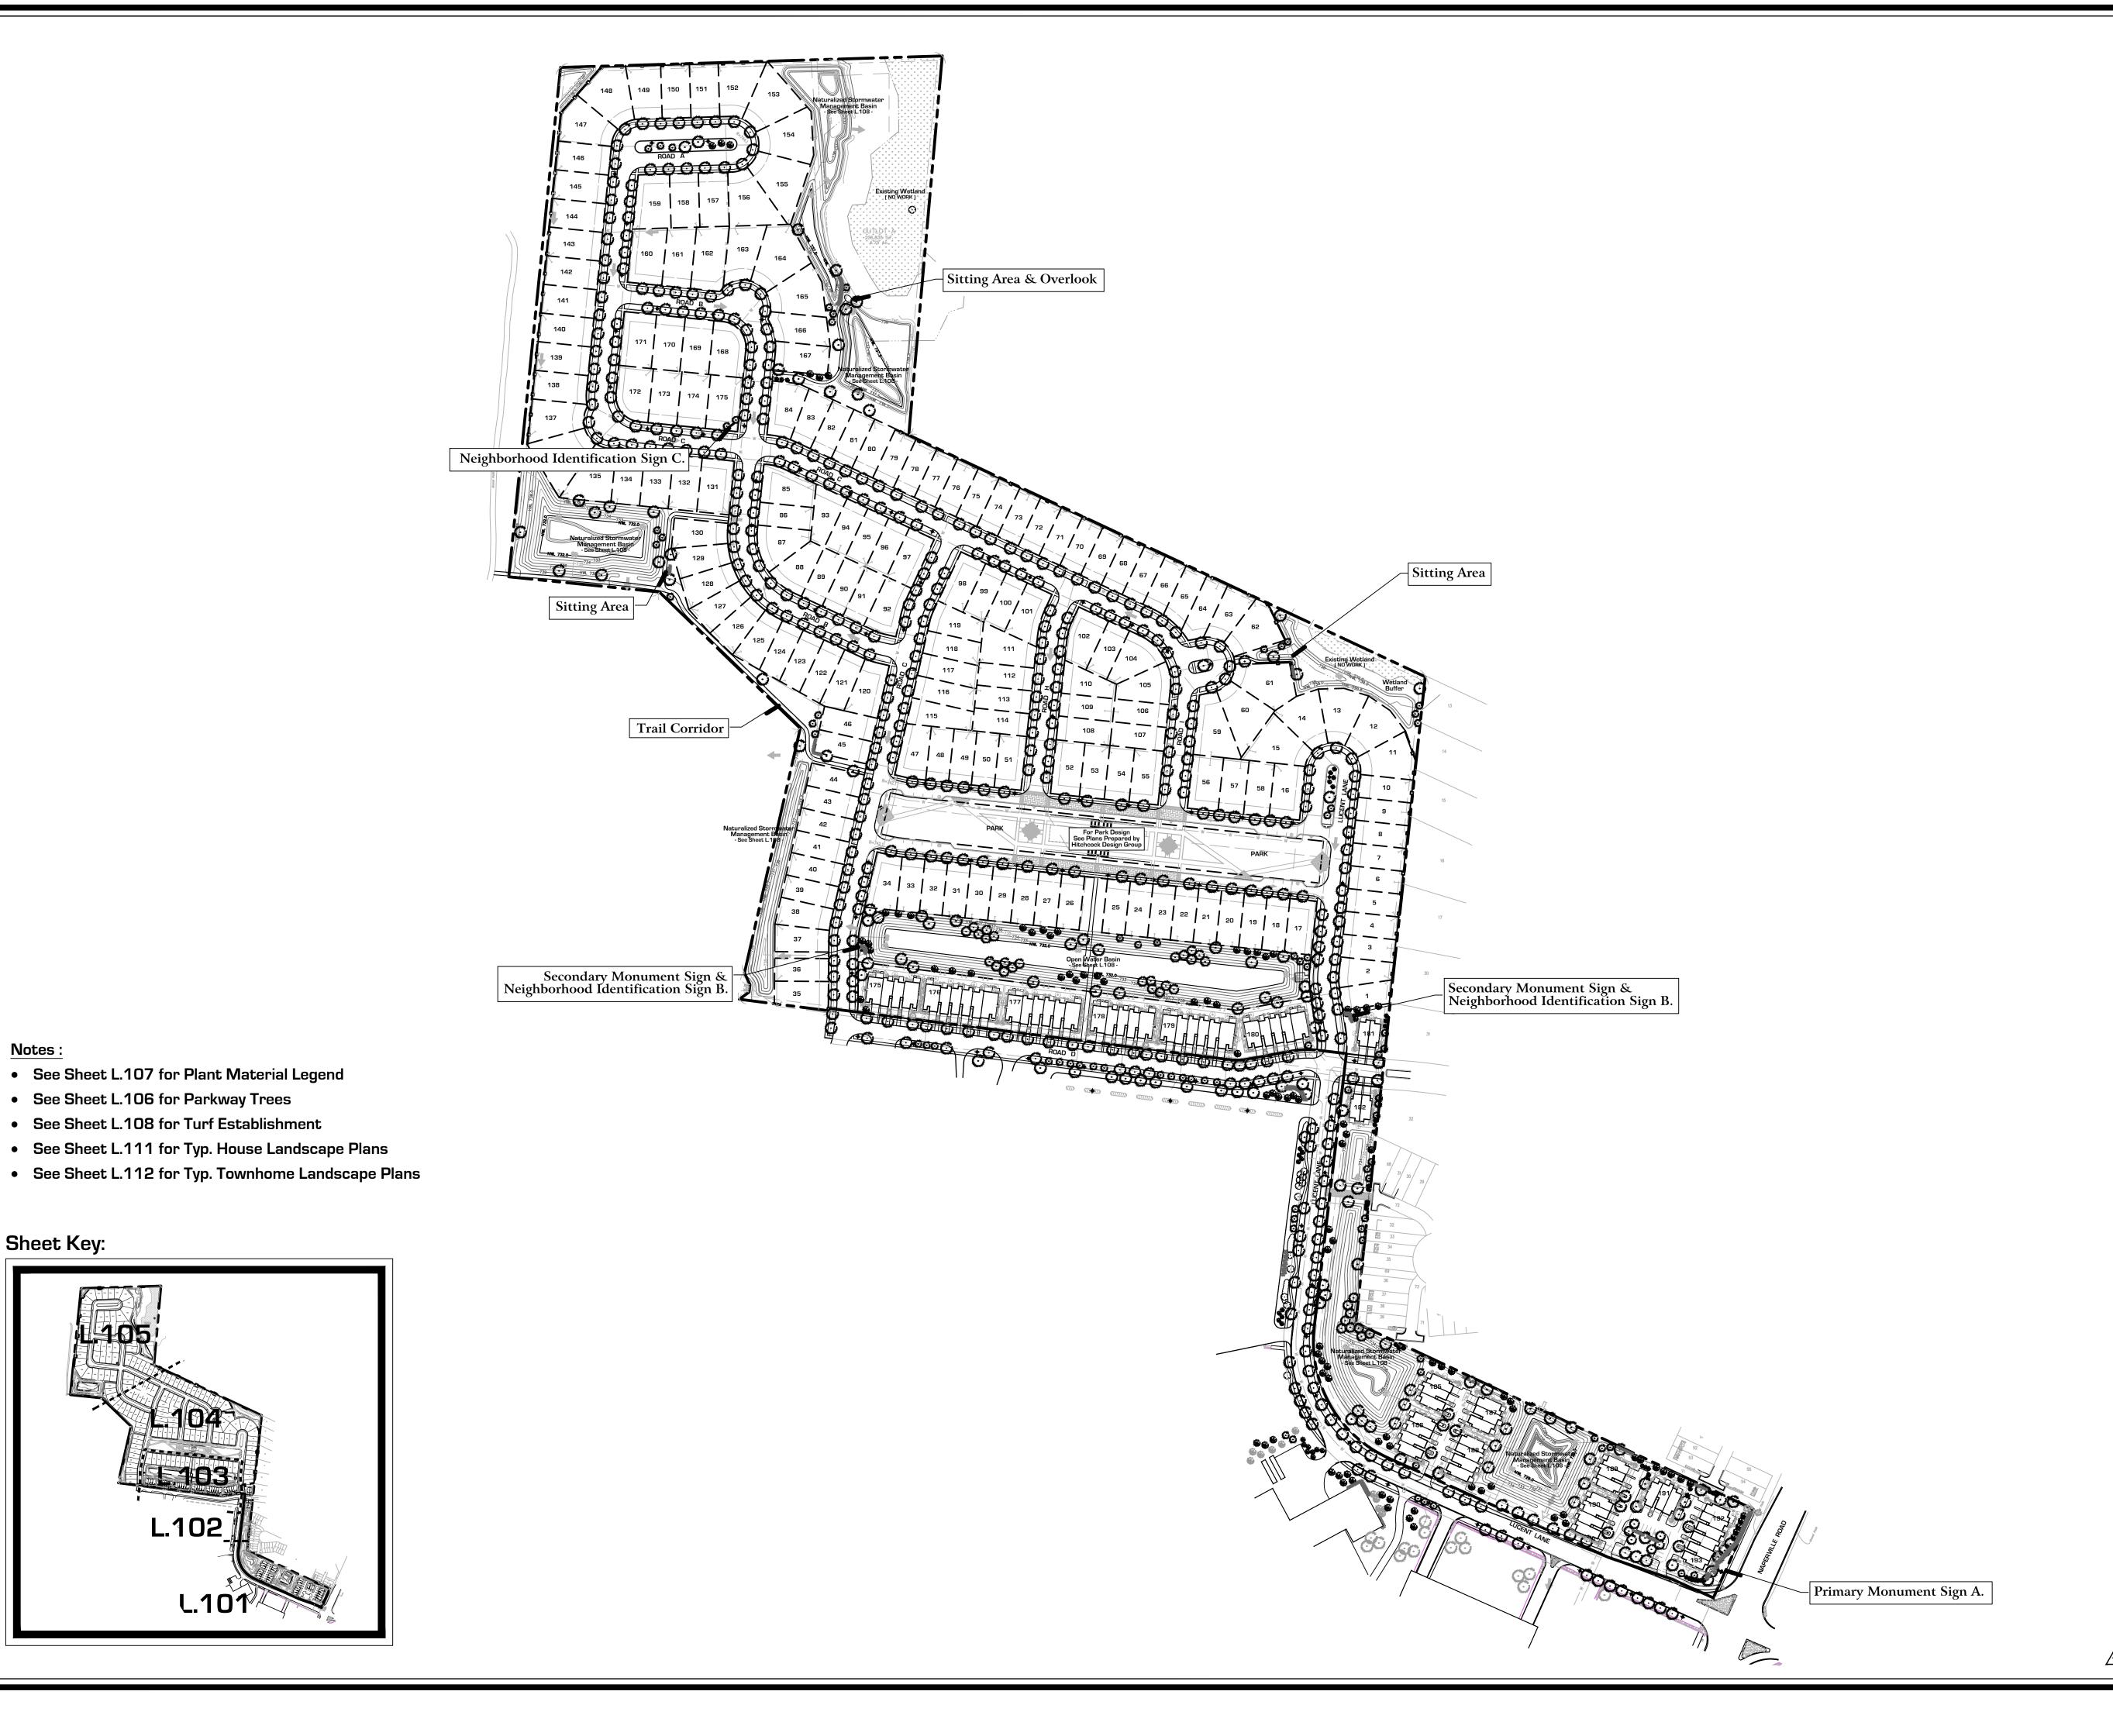• See Sheet L.107 for Plant Material Legend

L.102]

L.101

See Sheet L.108 for Turf Establishment

See Sheet L.106 for Parkway Trees



Land Planning Landscape Architecture Environmental Site Design

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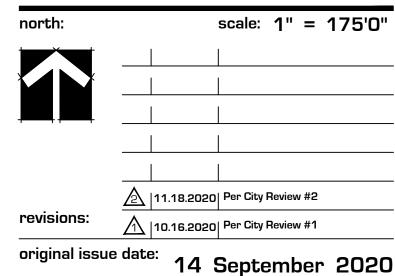
Naper Commons

Naperville, Illinois

sheet description:

Overall Landscape Plan **Preliminary**






original issue date: 14 September 2020

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sheet no.:

City of Naperville Project No. 20-10000086

L.100

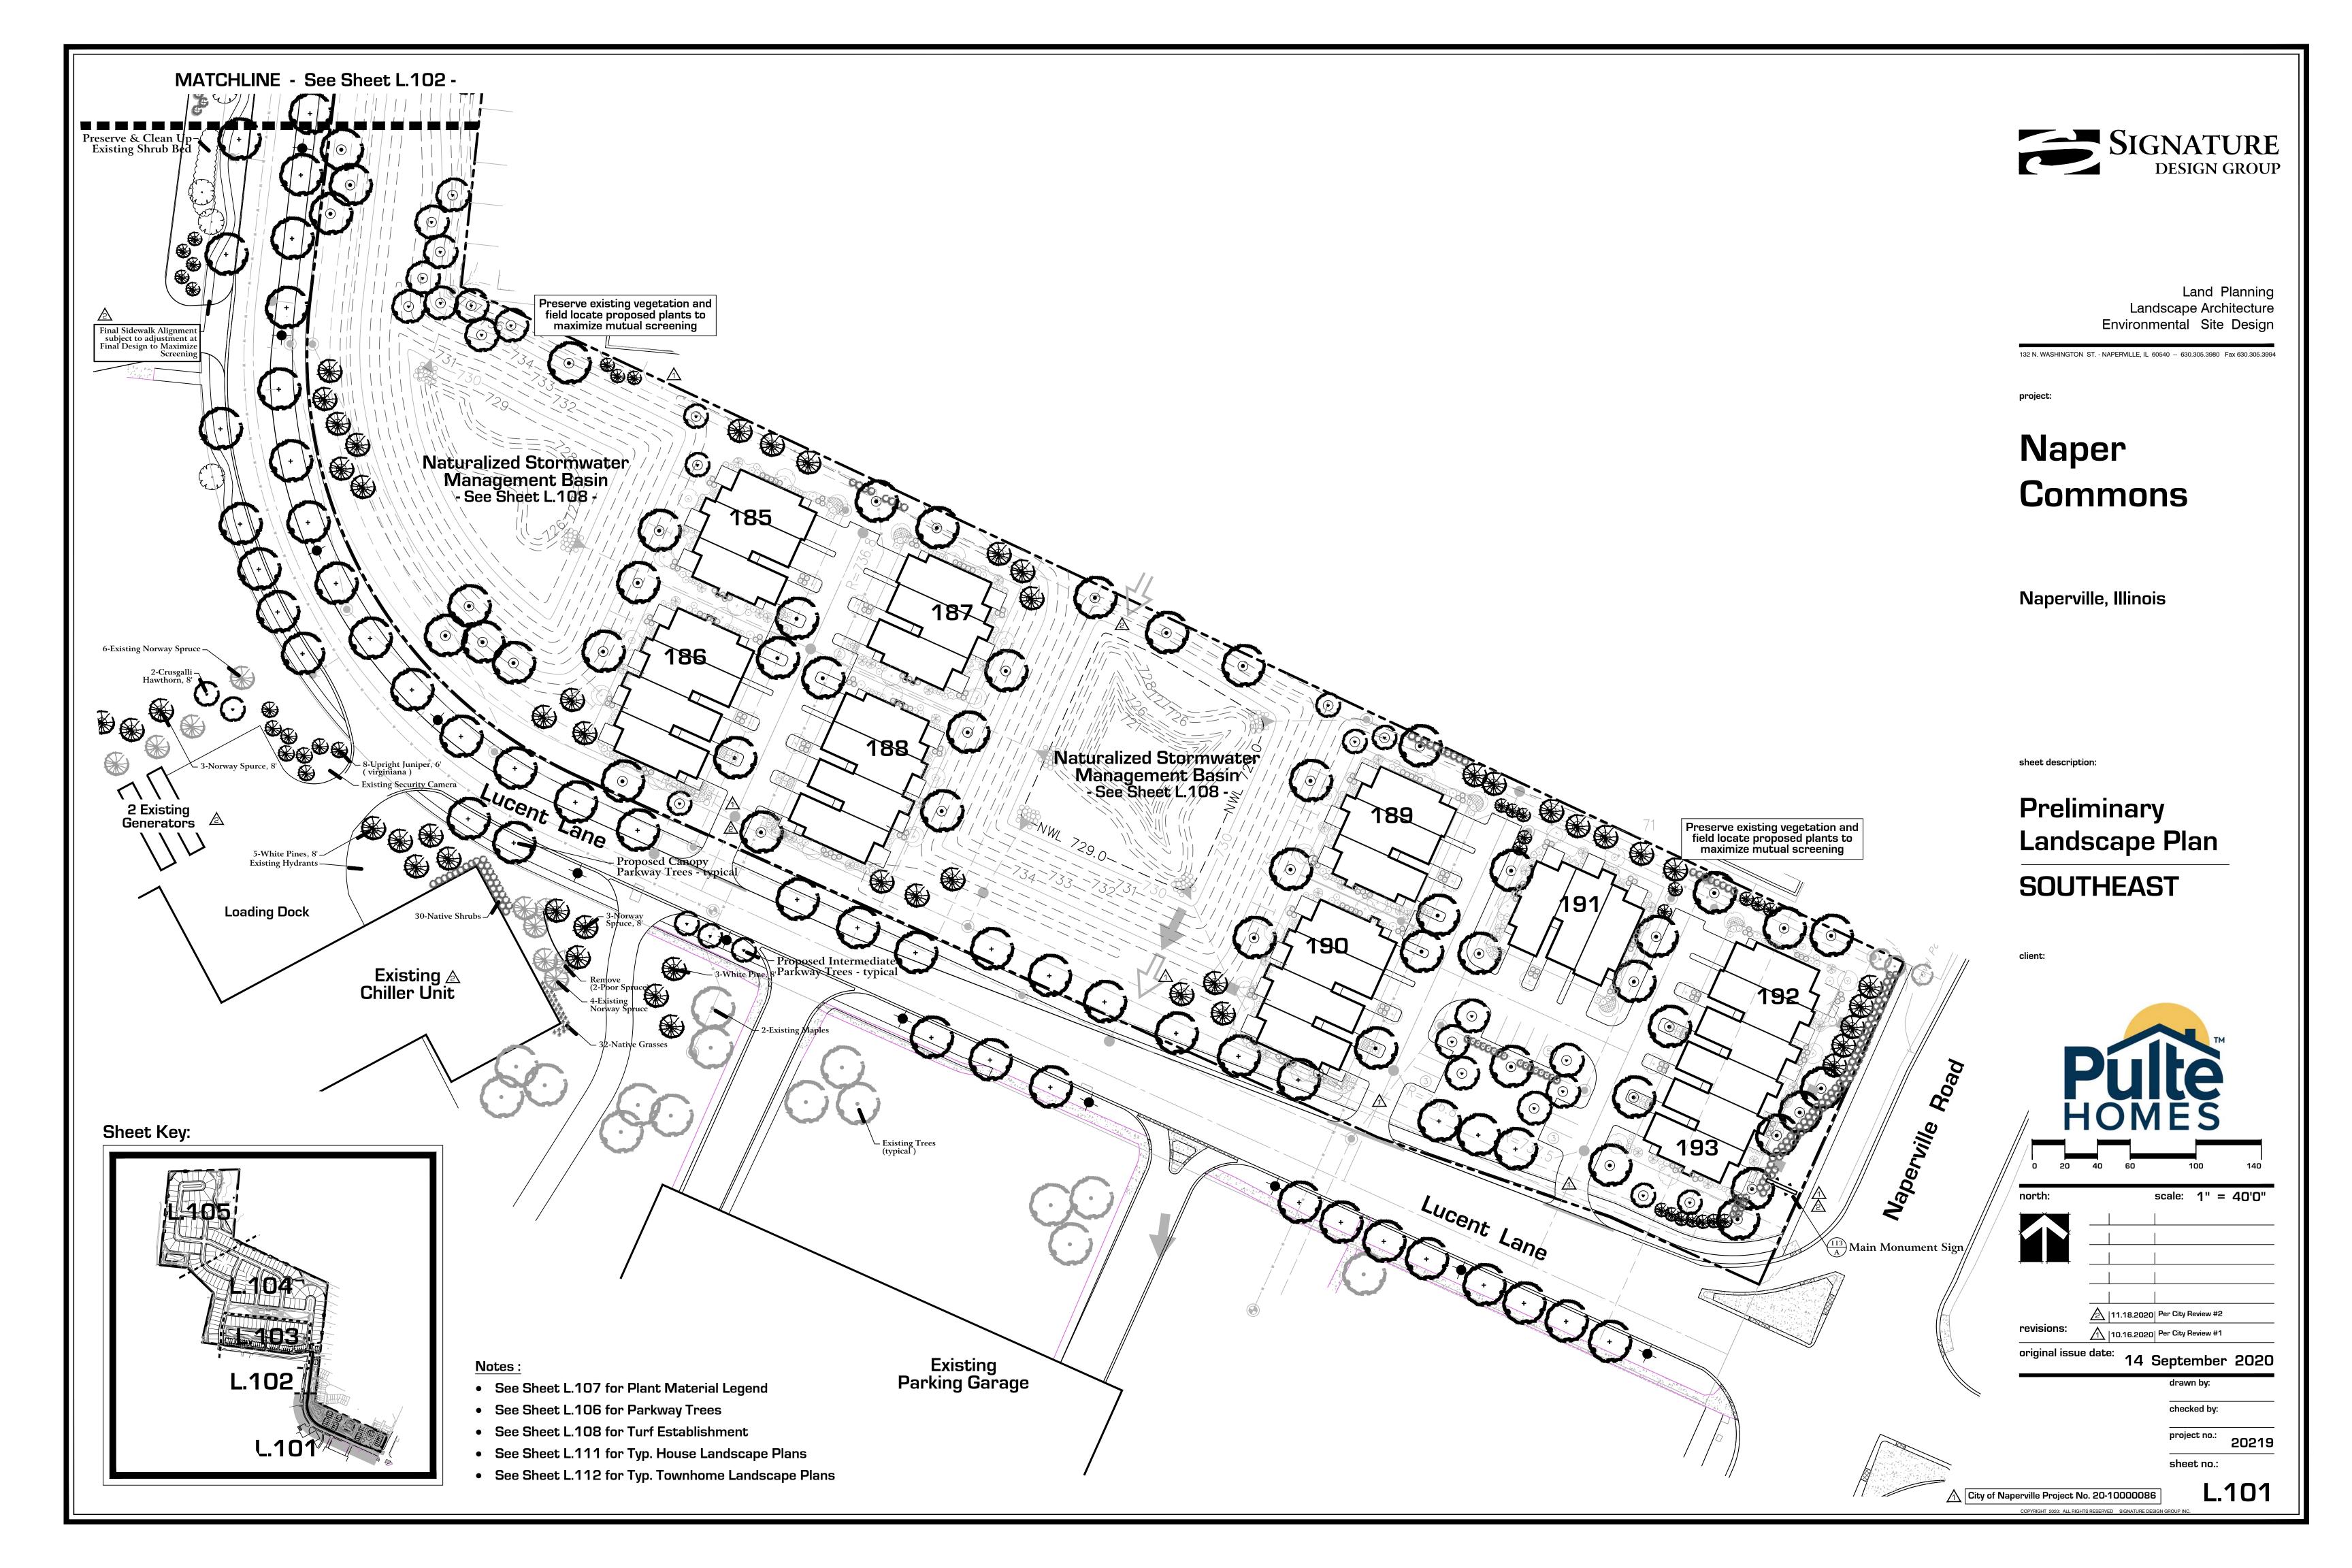

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sheet description:

Preliminary Landscape Plan


11.18.2020 Per City Review #2

checked by:

project no.: 20219

L.102


EAST

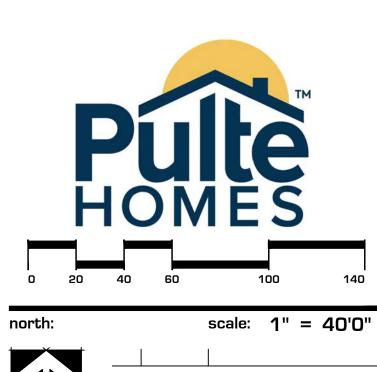

10.16.2020 Per City Review #1 original issue date: 14 September 2020

sheet no.:

City of Naperville Project No. 20-10000086

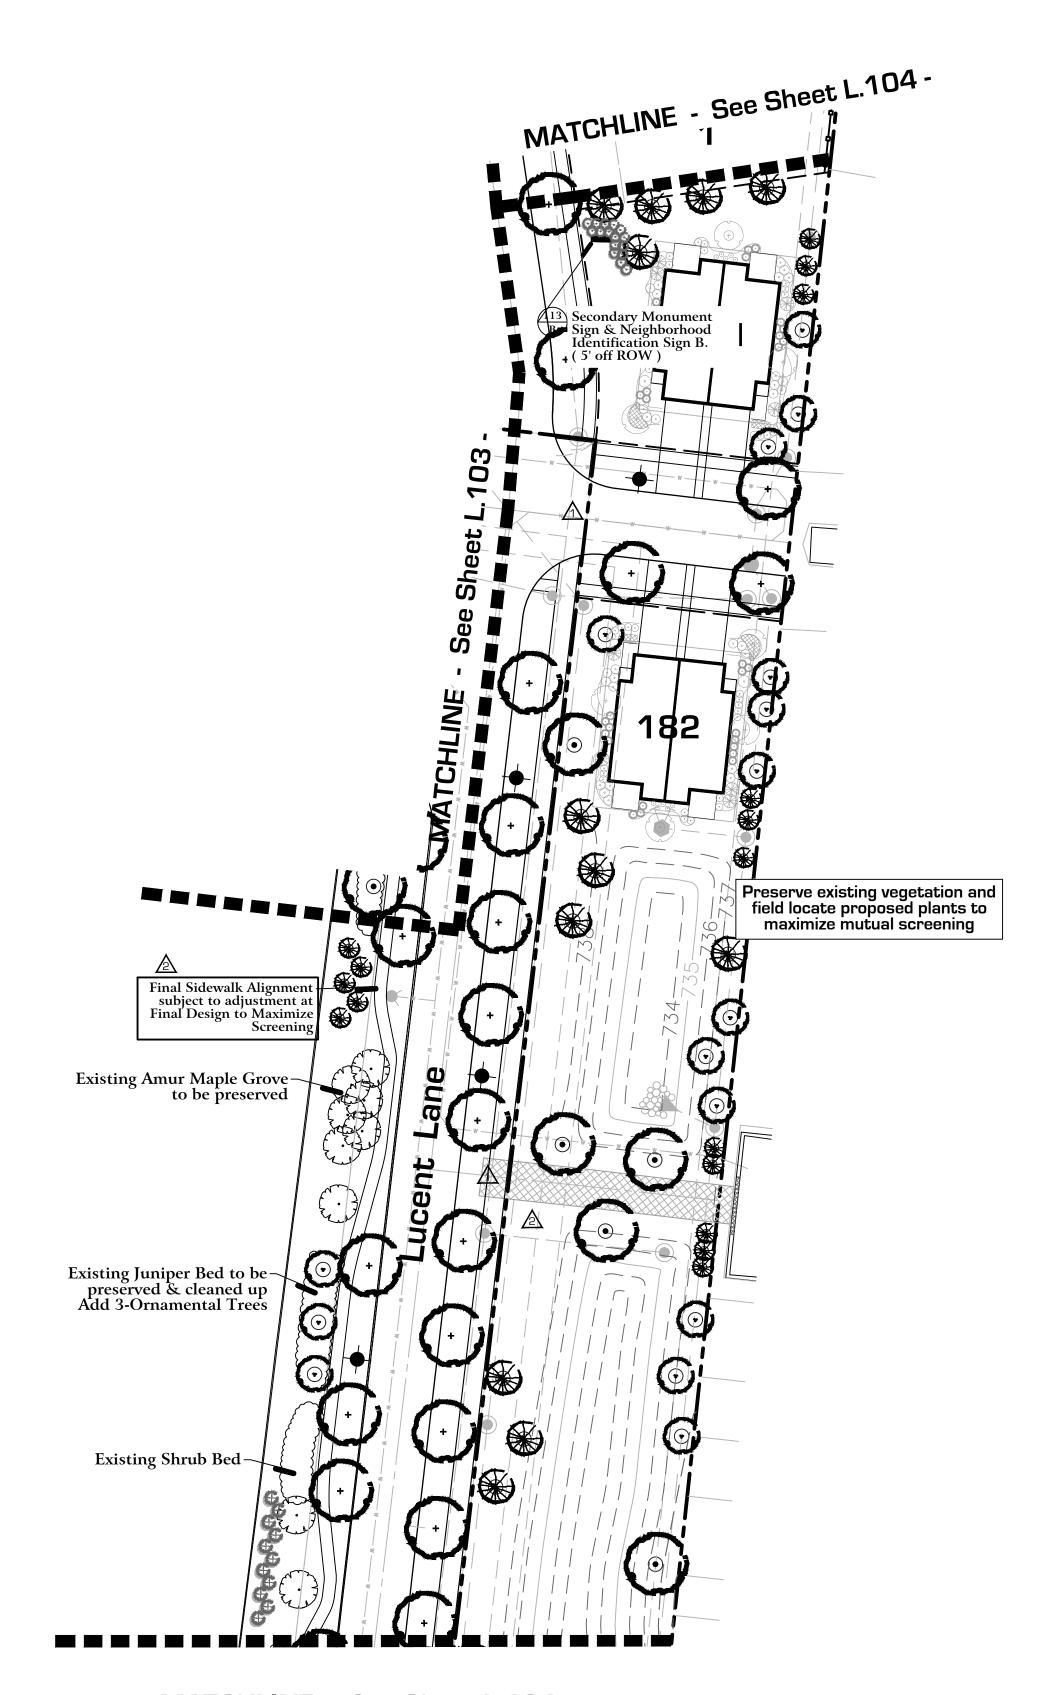


MATCHLINE - See Sheet L.101 -

Notes:

- See Sheet L.107 for Plant Material Legend
- See Sheet L.106 for Parkway Trees
- See Sheet L.108 for Turf Establishment
- See Sheet L.111 for Typ. House Landscape Plans
- See Sheet L.112 for Typ. Townhome Landscape Plans

Sheet Key:

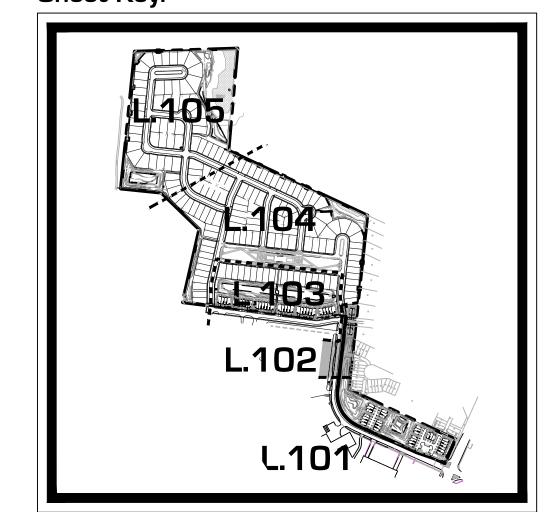



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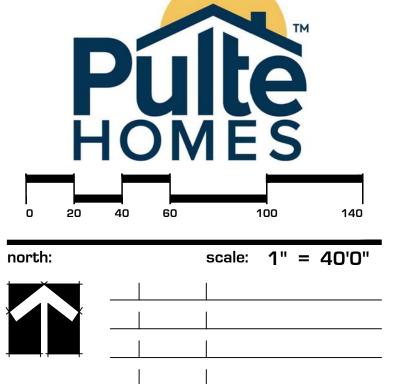
Naper Commons

Naperville, Illinois

sheet description:

Preliminary Landscape Plan

CENTRAL



11.18.2020 Per City Review #2

10.16.2020 Per City Review #1

original issue date: 14 September 2020

checked by:


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City of Naperville Project No. 20-10000086

L.103




Sheet Key:

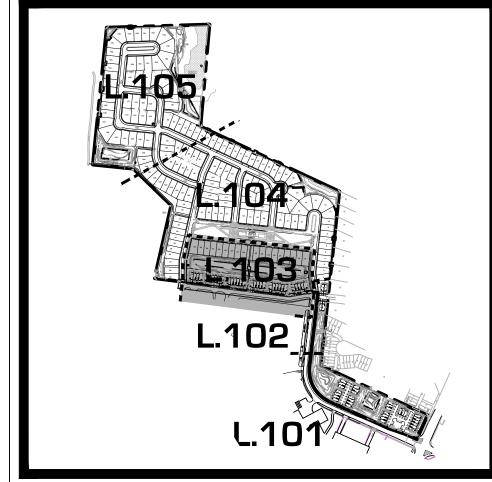

Notes:

- See Sheet L.107 for Plant Material Legend
- See Sheet L.106 for Parkway Trees
- See Sheet L.108 for Turf Establishment
- See Sheet L.111 for Typ. House Landscape Plans • See Sheet L.112 for Typ. Townhome Landscape Plans

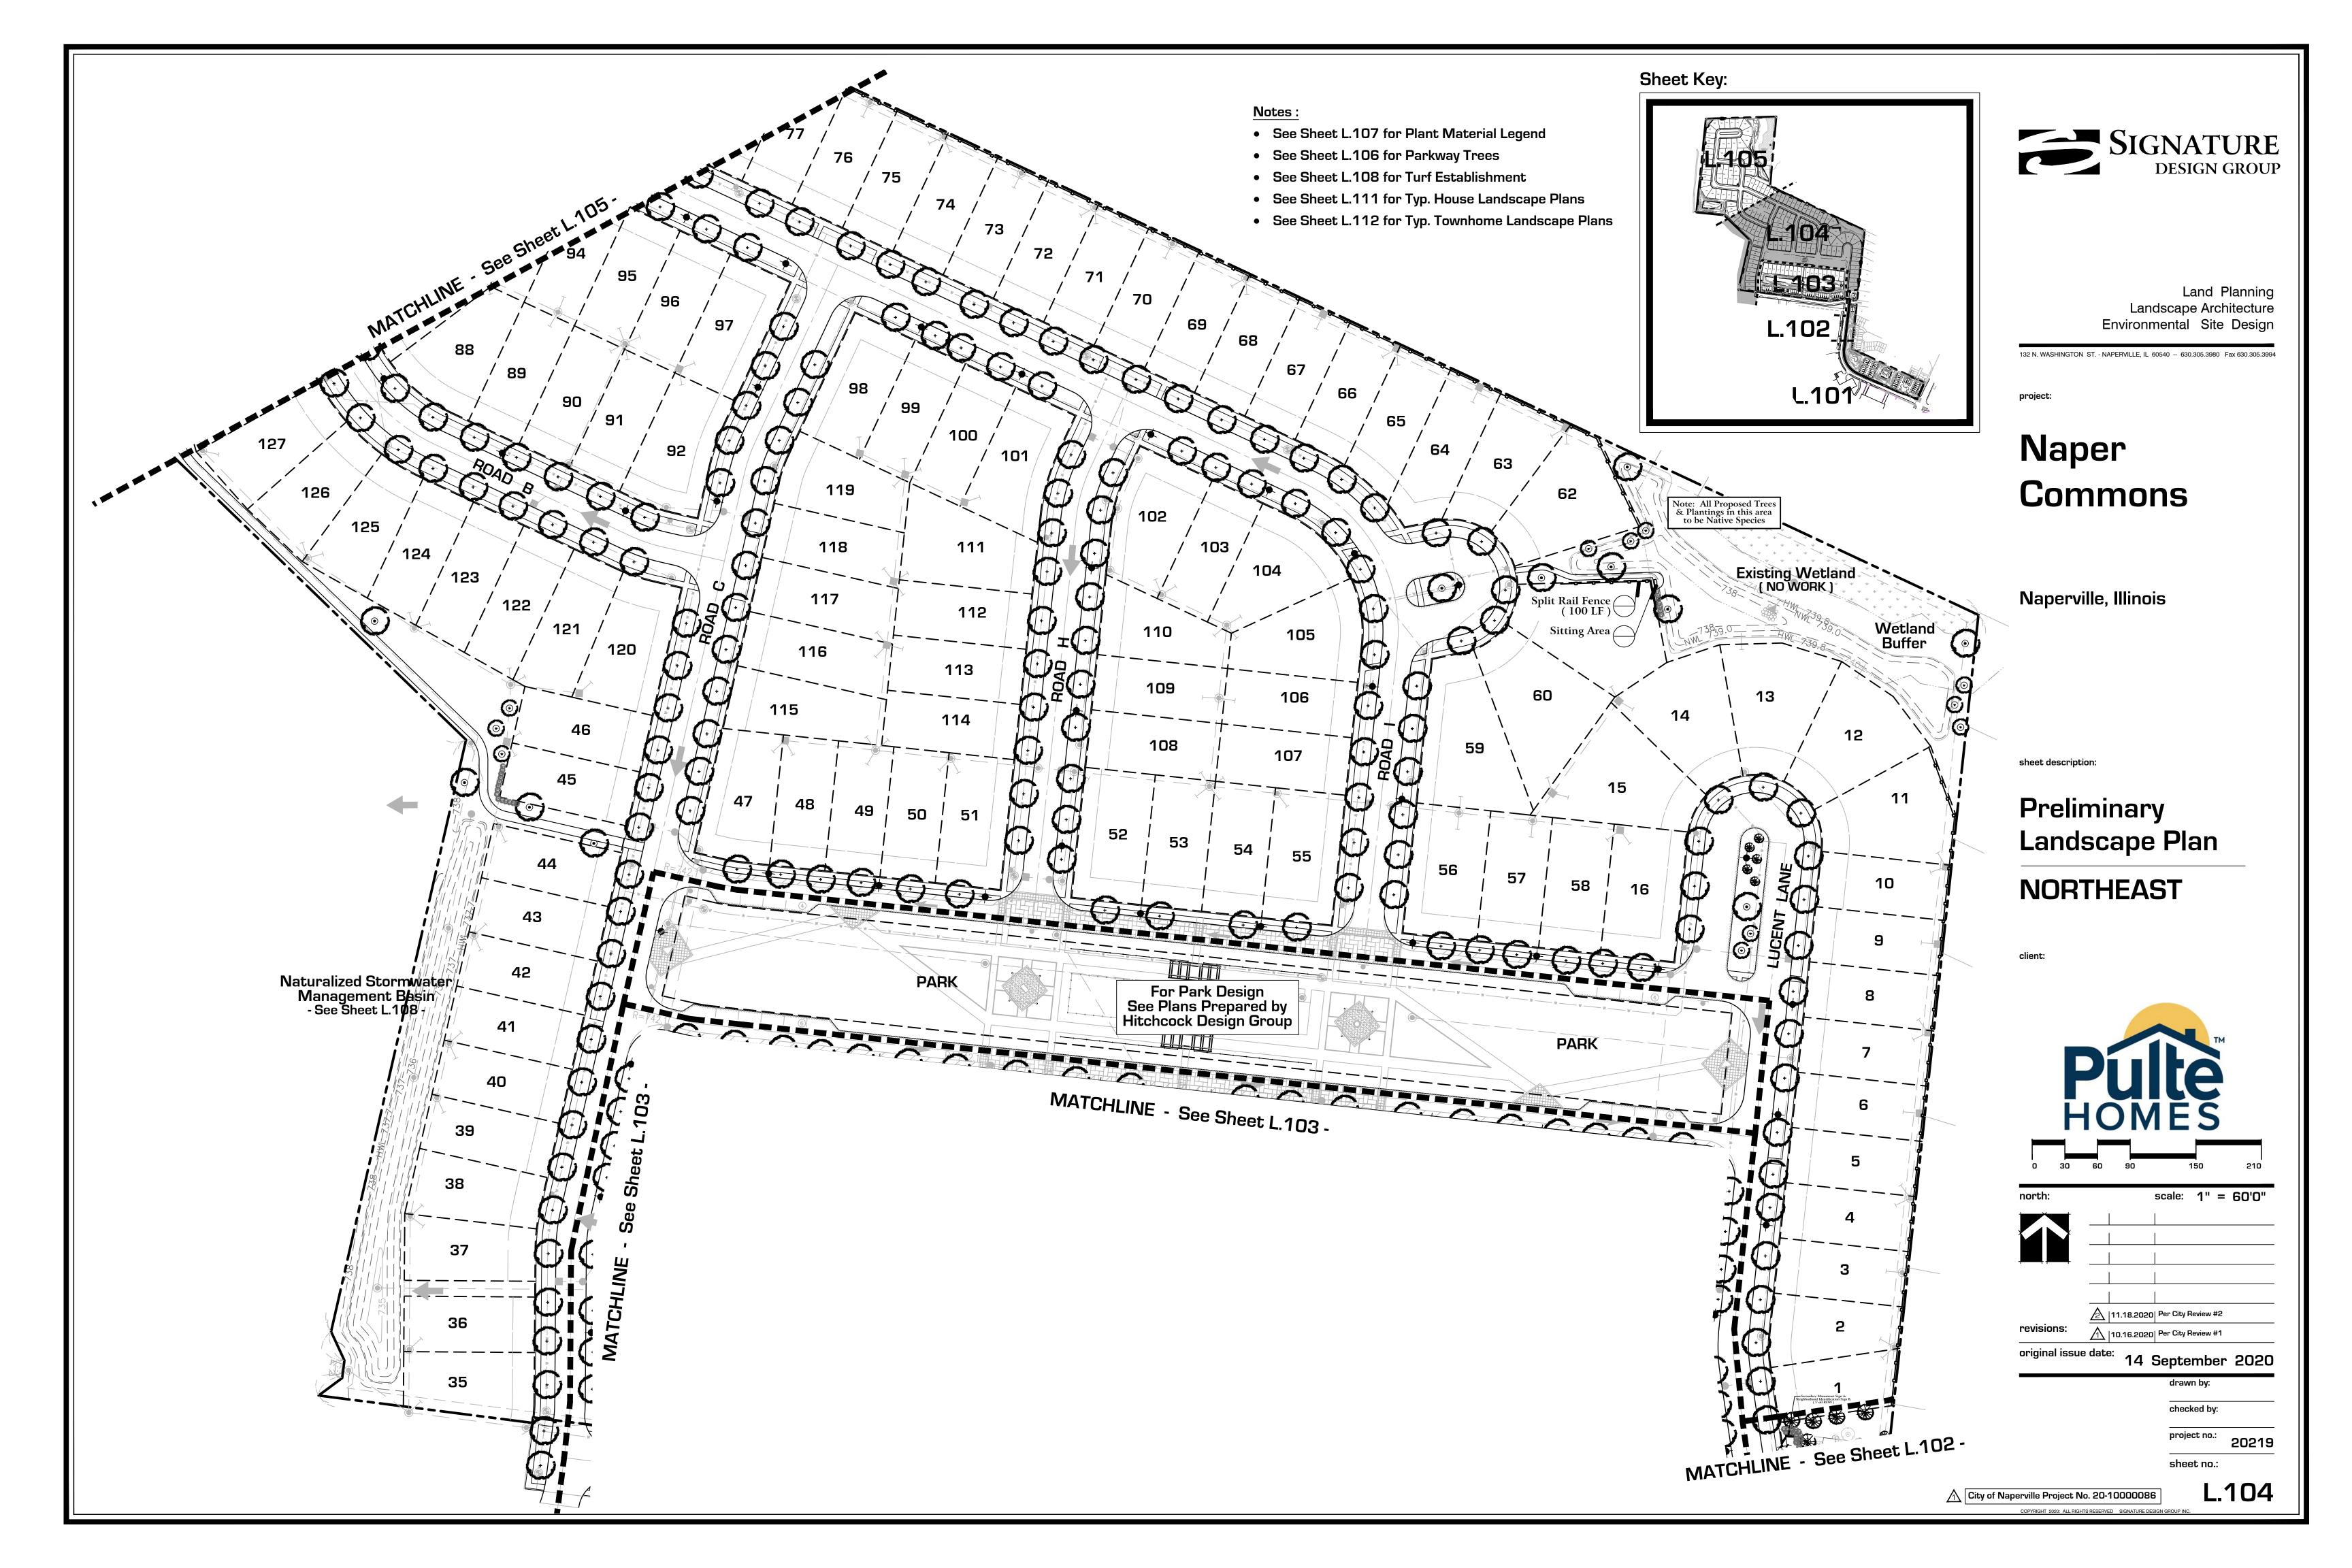

152 Naturalized Stormwater Management Basin - See Sheet L.108 -147 154 155 145 Existing Wetland 143 163 161 164 142 Sitting Area & Overlook 165 141 140 166 Note: All Proposed Trees & Plantings in this area to be Native Species 170 167 139 Maturalized Stormwater Management Basin - See Sheet L.108 -138 173 i ₁₇₄ . | 175 84 137 83 82 81 80 136 79 135 134 133 132 131 130 Naturalized Stormwater Management Basin - See Sheet L.108 -Sitting Area Proposed Trail Corridor - See Engineering -



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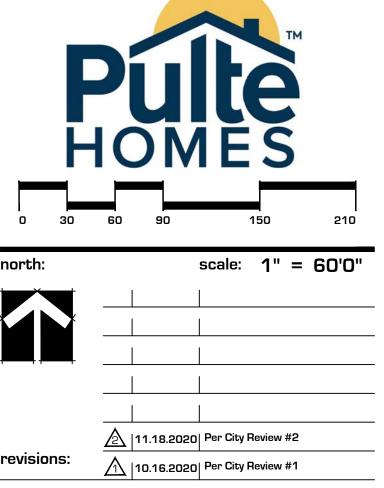
Naperville, Illinois

sheet description:

Preliminary Landscape Plan

NORTHWEST

client:



original issue date: 14 September 2020


drawn by:

checked by:

project no.: 20219
sheet no.:

City of Naperville Project No. 20-10000086

L.105

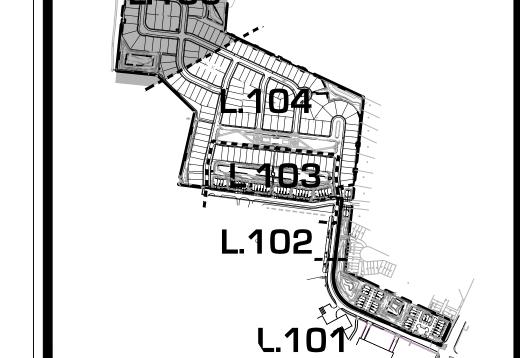

• See Sheet L.107 for Plant Material Legend

• See Sheet L.111 for Typ. House Landscape Plans

• See Sheet L.112 for Typ. Townhome Landscape Plans

• See Sheet L.106 for Parkway Trees

• See Sheet L.108 for Turf Establishment

Notes:

Sheet Key:

PARKWAY TREE LEGEND:

(Sheet L.106 Only)

Split-Rail Fence

Proposed Parkway Trees, 2.5" Caliper, Common Areas
Planted at approx. 40' o.c. during Site Development

Chicagoland Hackberry
Chicagoland Hackberry
Magyar Gingko
Skyline Locust
Exclamation Planetree
Triumph Elm
Autumn Blaze Maple

Proposed Individual Lot Parkway Trees, 2.5" caliper at approx. 40' o.c.

To be Planted by Pulte at the time of individual house construction

pecies:
Chicagoland Hackberry
Magyar Gingko
Skyline Locust
Exclamation Planetree
Triumph Elm
Autumn Blaze Maple
Redmond Linden
Swamp White Oak
Kentucky Coffeetree
Accolade Elm
Emerald Lustre Maple

Proposed Intermediate Parkway Trees, 2.5" or 8' m/s, Common Areas

To be Planted at approx 25' o.c. during Site Development


Thornless Hawthorne Crabapple Var
Jap. Tree Lilac Var. Serviceberry
Pekin Tree Lilac Var.

PARKWAY CONSTRUCTION NOTES:

- No more than 10% of the same species may be used in total.
- No more than 5 trees of the same species may be planted adjacently, except where noted for Boulevard continuity.
- Understory trees must be used in areas with an overhead utility conflict.
- Plant material sizing, branching and ball sizes shall conform to the "American Standards for Nursery Stock" (latest edition) by the American Association of Nurseryman, Inc.
- Plant material shall be nursery grown and be either balled and burlapped or container grown. Sizes and spreads on plant list represent minimum requirements.

 Output: Interpretent of the property of the
- Quantity lists are supplied as a convenience. Contractor shall verify all quantities, and in case of a discrepancy, the plan shall prevail.
 Trees shall be set back a minimum of ten (10) feet horizontally from utility structures, including, but not limited to,
- manholes, valve vaults, valve boxes, fire hydrants, transformers and switch cans. Trees shall be set back a minimum of five (5) feet horizontally from sanitary sewer, water services and underground electric cable. Approval of the Landscape Architect is required when field adjustments to be implemented do not conform to the intent of the plans.

 No trees, shrubs or obstacles will be allowed 10' in front, 5' on the sides, and 7' to the rear of the electrical
- transformer.
- Contractor shall report any discrepancies in the field to the Landscape Architect and/or Owner.
- The Landscape Contractor shall verify locations of all underground utilities prior to digging, is required to Contact
 J.U.L.I.E. (1.800.892.0123), and any other public or private agency necessary for utility location 48 hours prior to
 construction.
- Where underground utilities exist, all field adjustments must be approved by the landscape architect.
 The Landscape Contractor shall water plant material, seed and sod areas until the plants have become adequately
- The Landscape Contractor shall water plant material, seed and sod areas until the plants have become adequately established and until final acceptance by the owner. Owner to provide all supplemental watering and proper care and maintenance of all plant materials, seed and sod areas after acceptance of Landscape Contractors work.
- No plants are to be changed or substituted without the approval of the Landscape Architect and the City of Naperville.
- Landscape Contractor shall warrantee all material and labor for a period of two years from the date of final acceptance and shall repair any defects and replace all dead plant material as required during the warranty period.

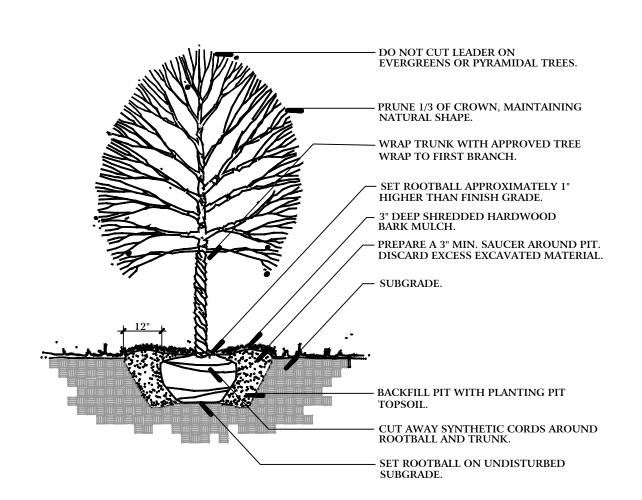

Typical Tree Planting Detail

Adjust Sidewalk to Preserve Existing Trees

Adjust Sidewalk to Preserve Existing Trees

B Split - Rail Fence Detail

Split-Rail Fence

 $\frac{\widehat{106}}{B}$ Split-Rail Fence \triangle



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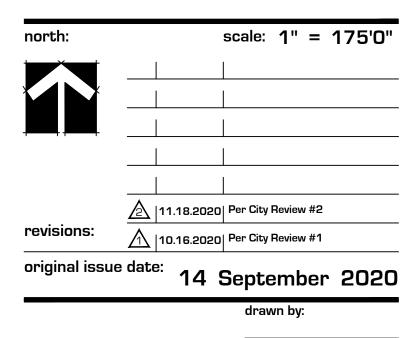
Naperville, Illinois

sheet description:

Preliminary
Parkway Tree &
Fence Exhibit

client:





checked by:

project no.:
20219
sheet no.:

City of Naperville Project No. 20-10000086

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Preliminary Plant Material Legend: (Sheet L.101 - L.105)



Parkway Trees, 2.5" Caliper



Shade Trees, 2.5" - 3" Caliper

State Street Maple **Chicagoland Hackberry** Shawnee Brave Baldcypress Kentucky Coffeetree **Exclamation London Planetree** Redmond Linden

Accolade Elm Bur Oak Skyline Locust **Triumph Elm**



Shade Trees, 8' - 12' m/s

Ornamental Trees, 6'-8' m/s Blackhaw Viburnum **Prairie Fire Crab** Apple Serviceberry Ivory Silk Tree Lilac Thornless Cockspur Hawthorne Common Witchhazel

Sargent Crab

Evergreen Trees, 6' - 8' tall

Norway Spruce Fairview Juniper Wintergreen Arborvitae Colorado Spruce White Pine Mission Arborvitae Black Hills Spruce Canaerti Juniper



Evergreen Shrubs, 18" - 24" wide Green Sargent Juniper Hughes Juniper Kallay Compact Juniper



Deciduous Shrubs, 18" - 36" tall American Filbert Miss Kim Lilac Black Chokeberry Dogwood Var. Viburnums Var. Shrub Rose Var. Panicle Hydrangea

Texas Scarlet Quince Spirea Var. Annabelle Hydrangea Elderberry



Perennials, Orn'l Grasses & Groundcovers, 1gal. Feather Reed Grass

Prairie Dropseed **Blue Wonder Catmint** Switchgrass Black Eye Susan Russian Sage Allium sp. Aut. Moor Grass Sedum sp. Amsonia sp.


Native Species:

Proposed Plantings in all wetland buffer areas shall be species native to Northern Illinois


Construction Notes:

- Sod all turf areas as noted with an approved blend of improved Kentucky Bluegrass Sod with a mineral soil back.
- Drill seed all remaining turf areas as noted and cover with an S-75 Straw Erosion Control Blanket and staple in place. (See Sheet L.108 for Seed Mixes) • Fine grading shall provide slopes which are smooth and continuous. Positive drainage shall be provided in all areas.
- Prior to turf installation all areas shall be fertilized with a 12-12-12 granular fertilizer at a rate
- of 400 lbs. per Acre.
- Prepare perennial, ornamental grass, groundcover and annual flower beds with 1 CY. mushroom compost per 100 SF. rototilled to an 8" depth.
- Mulch all trees, shrub, perennial & orn'l grass beds with a minimum of three inches shredded hardwood bark mulch.
- Mulch all groundcover and annual beds with minimum of one inch pinebark fines. • All bed lines and tree saucers require a 4" deep spaded edge between lawn and mulch areas.
- All evergreen (conifers) trees and shrubs must be grown in a natural shape and <u>not</u> sheared.
- Plant material sizing, branching and ball sizes shall conform to the "American Standards for Nursery Stock" (latest edition) by the American Association of Nurseryman, Inc.
- Plant material shall be nursery grown and be either balled and burlapped or container grown. Sizes and spreads on plant list represent minimum requirements.
- Quantity lists are supplied as a convenience. Contractor shall verify all quantities, and in case of a discrepancy, the plan shall
- The Landscape Contractor shall adjust plant locations in field to maintain appropriate spacing from fire hydrants, light poles, all utility structures, driveways and sidewalks. Approval of the Landscape Architect is required when field adjustments to be implemented do not conform to the intent of the plans.
- Contractor shall report any discrepancies in the field to the Landscape Architect and/or Owner.
- The Landscape Contractor shall verify locations of all underground utilities prior to digging, is required to Contact J.U.L.I.E. (1.800.892.0123), and any other public or private agency necessary for utility location 48 hours prior to construction.
- Where underground utilities exist, all field adjustments must be approved by the landscape architect.
- The Landscape Contractor shall water plant material, seed and sod areas until the plants have become adequately established and until final acceptance by the owner. Owner to provide all supplemental watering and proper care and maintenance of all plant materials, seed and sod areas after acceptance of Landscape Contractors work.
- No plants are to be changed or substituted without the approval of the Landscape Architect and the City of Naperville.
- Landscape Contractor shall warrantee all material and labor for a period of one year from the date of final acceptance and shall repair any defects and replace all dead plant material as required during the warranty period.
- Trees shall be set back a minimum of ten (10) feet horizontally from utility structures, including, but not limited to, manholes, valve vaults, valve boxes, fire hydrants, transformers and switch cans. Trees shall be set back a minimum of five (5) feet horizontally from sanitary sewer, water services and underground electric cable. Approval of the Landscape Architect is
- required when field adjustments to be implemented do not conform to the intent of the plans. Parkway Trees must be offset 5 feet from all storm sewer.
- No trees, shrubs or obstacles will be allowed 10' in front, 5' on the sides, and 7' to the rear of the electrical transformer.




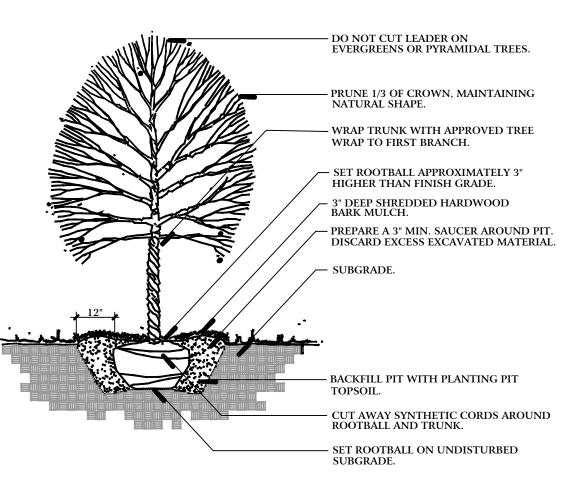


Typical Tree Planting Detail

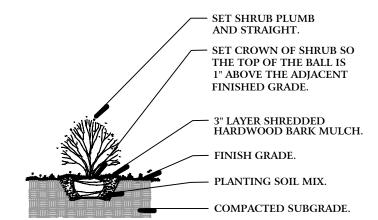

Typical Shrub Planting Detail

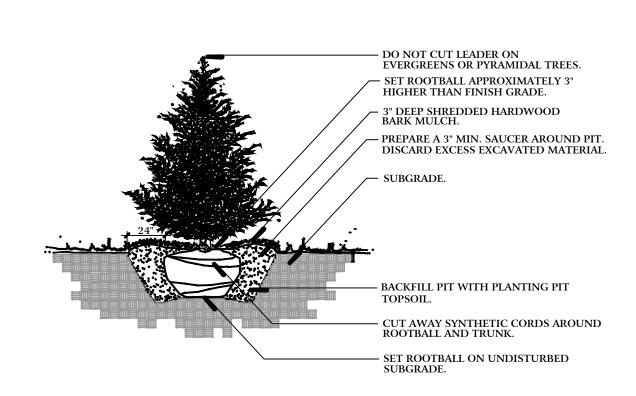

Typical Evergreen Planting Detail

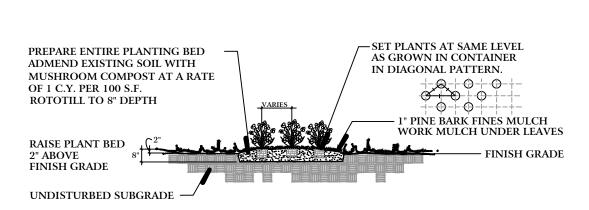

Typical Perennial Planting Detail

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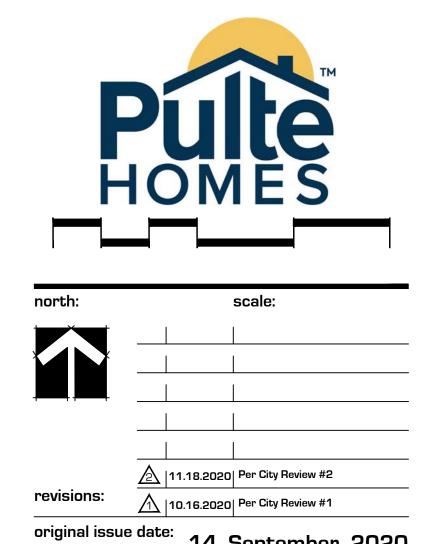
project:

Naper Commons

Naperville, Illinois

sheet description:

Plant Legend Parkway Tree Exhibit




original issue date: 14 September 2020

checked by: project no.: 20219

drawn by:

sheet no.:

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PLANT MATERIAL LEGEND:

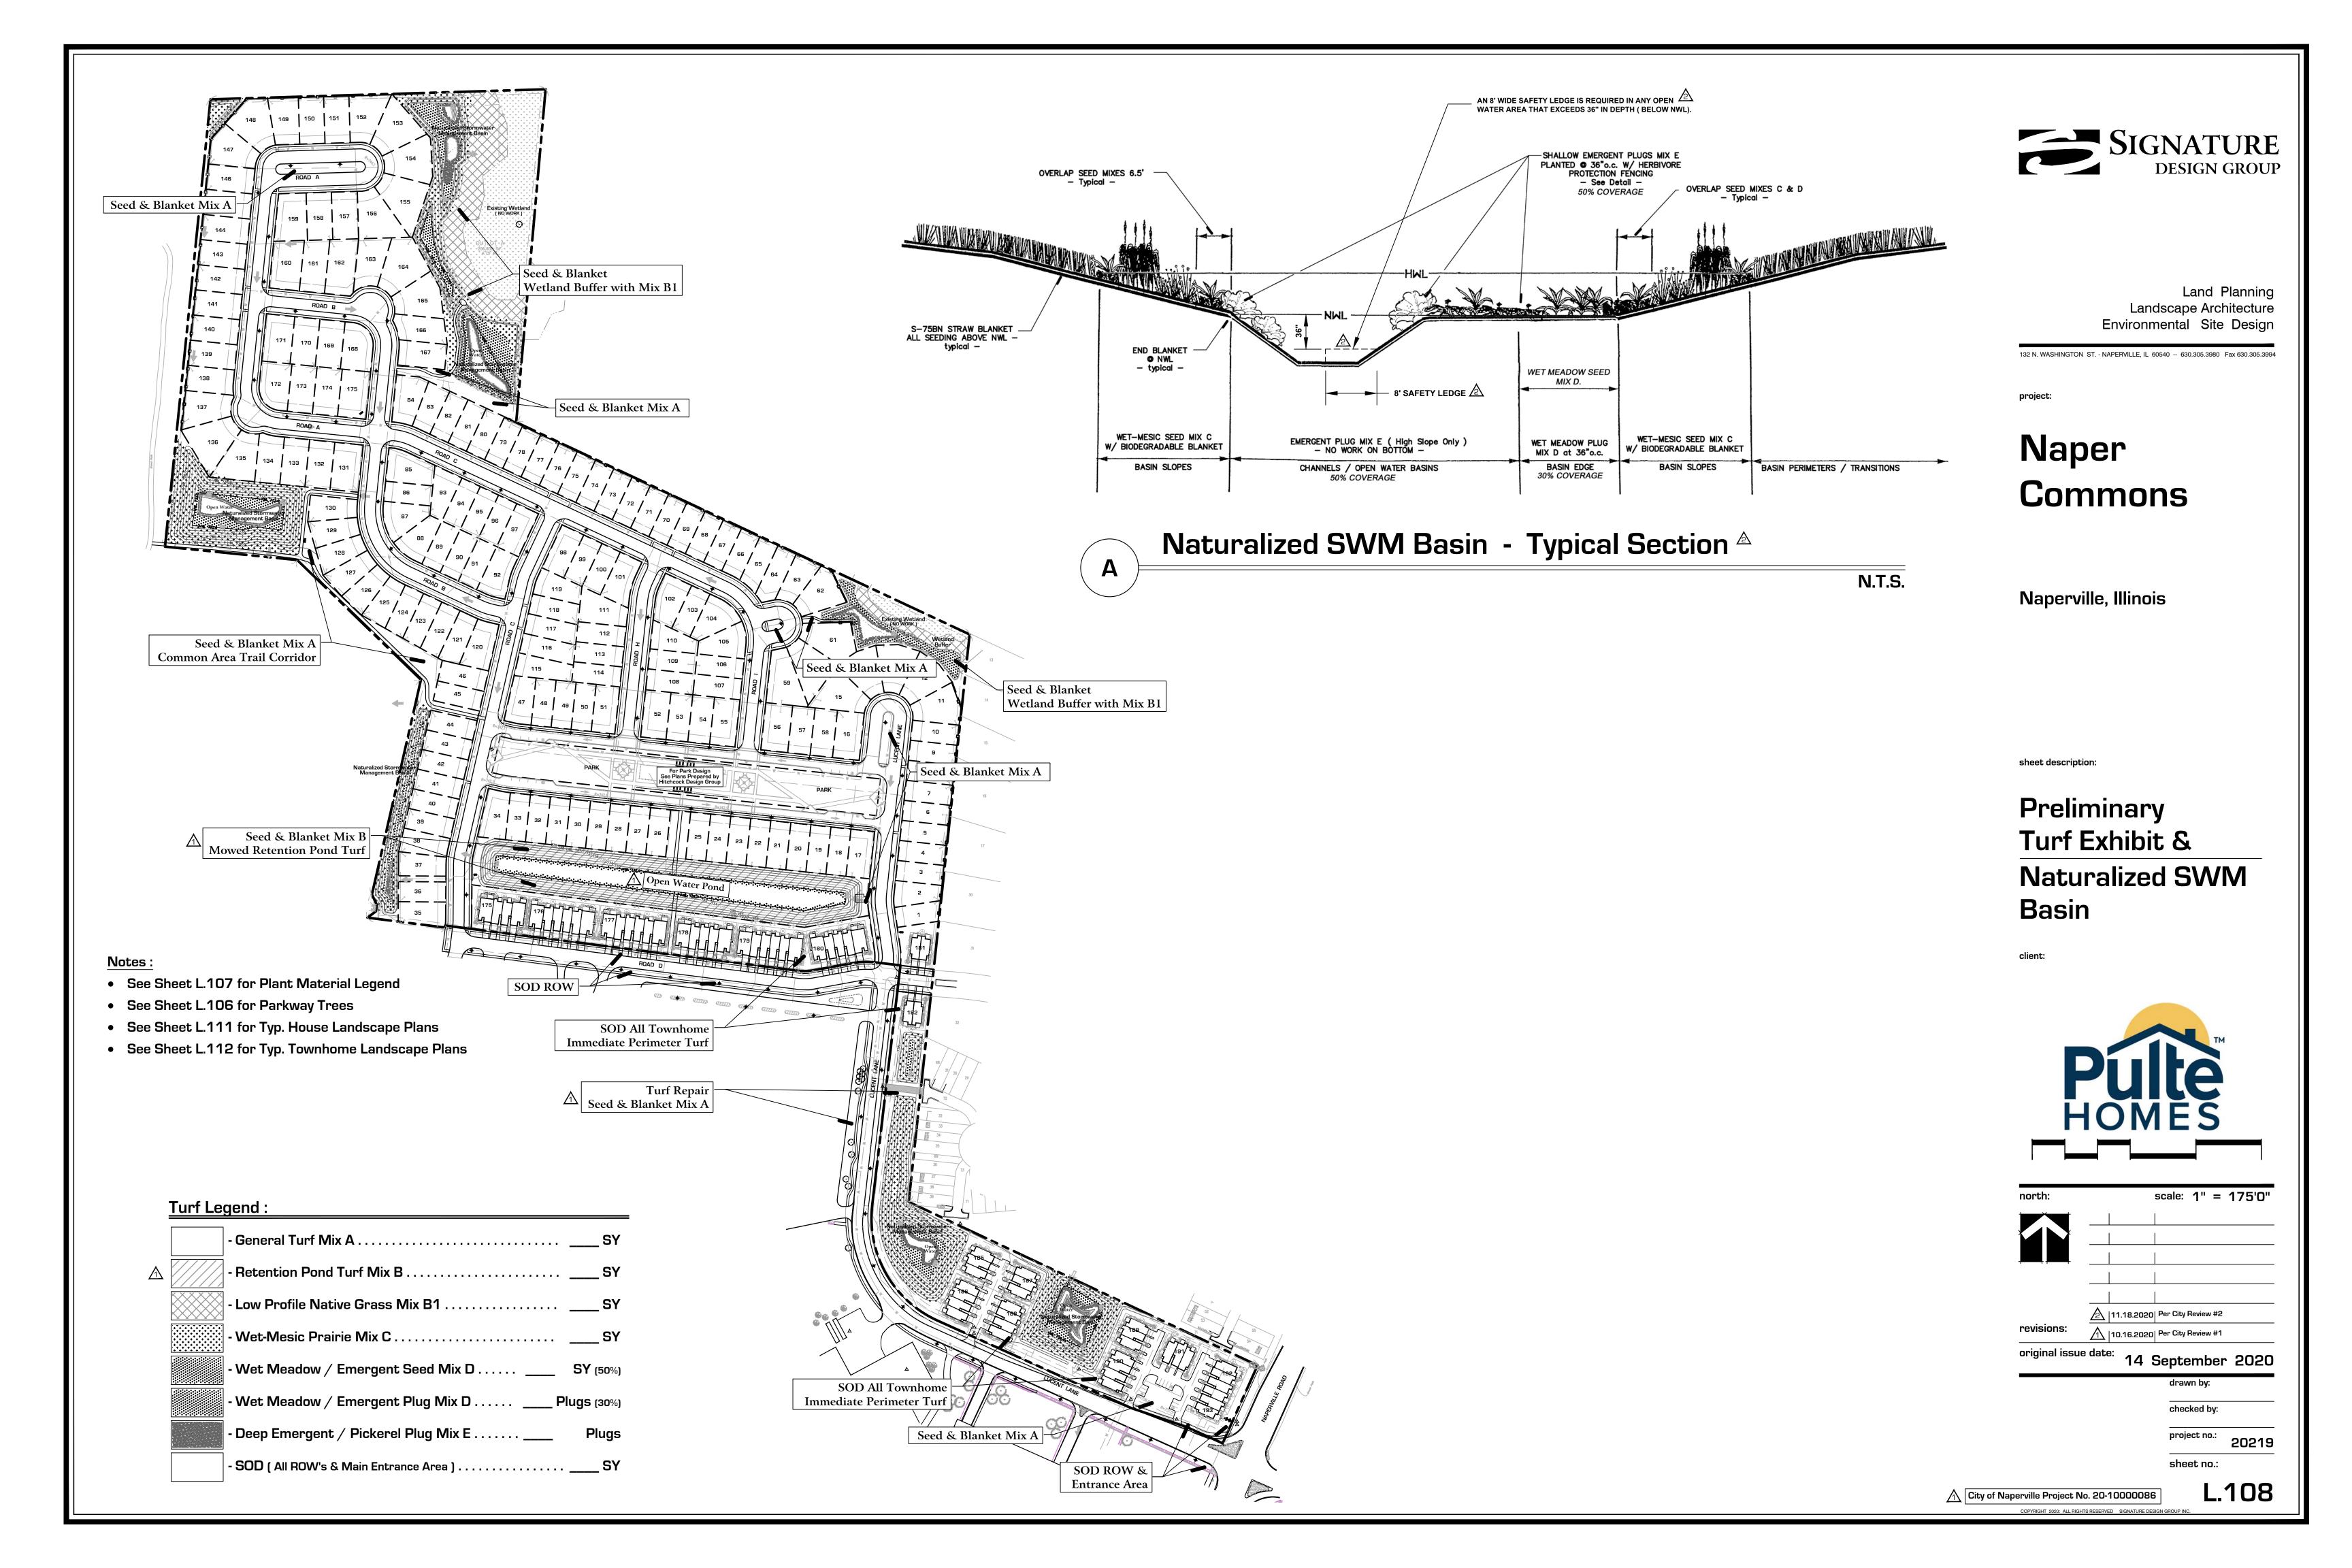(Sheets L.111 Only)



Ornamental Trees, 6' m/s or 2" Caliper

Ann Magnolia Apple Serviceberry 'Royal Raindrops' Crab **Red Jewel Crab** Jap Tree Lilac



Large Evergreen Trees, 6' tall

Black Hills Spruce Colorado Spruce **Swiss Stone Pine** Canadian Hemlock

Upright Evergreens, 4' - 5' tall Hooks #6 Upright Juniper

Mission Arborvitae Wintergreen Arborvitae Fairview Juniper Evergreen Shrubs, 18" - 24" wide

Dense Yew

Junipers, 18" wide

Kallay Compact Juniper

'Hughes' Juiper

Green Velvet Boxwood

Deciduous Shrubs, 18" - 36" tall

Peking Cotoneaster - L Black Chokeberry - M Redtwig Dogwood - L Limelight Hydrangea - L Double Take Pink Quince - M G.M. Alpine Current - S Goldmound Spirea - S

Little Princess Spirea - S Yellow Potentilla - S Mohican Viburnums - L K.O. Shrub Rose - S Snow Mound Spirea - M Miss Kim Lilac - L Bronx Forsythia - S Blue Muffin Vib. - M



Perennials, 1gal.

Annabelle Hydrangea - M

Yellow Coreopsis Purple Coneflower - Pixie Autumn Joy Sedum Happy Return Daylily Max Frei Geranium

August Moon Hosta Royal Standard Hosta **Blue Wonder Catmint** Summer Peek-a-boo Allium Montrose White Calamint

Seed & Blanket

Westchester Model

DRIVEWAY

Street

CONSTRUCTION NOTES:


- Sod all Lot turf areas as noted with an approved blend of improved Kentucky Bluegrass Sod with a mineral soil back. • Fine grading shall provide slopes which are smooth and continuous. Positive drainage shall be provided in all areas.
- Prepare perennial, ornamental grass, groundcover and annual flower beds with 1 CY. mushroom compost per 100 SF.
- rototilled to an 8" depth. • Mulch all trees, shrub, perennial & orn'l grass beds with a minimum of three (3) inches shredded hardwood bark mulch.
- Mulch all groundcover and annual beds with minimum of one (1) inch pinebark fines.
- All bed lines and tree saucers require a 4" deep spaded edge between lawn and mulch areas. • All evergreen (conifers) trees and shrubs must be grown in a natural shape - and not sheared.
- Plant material sizing, branching and ball sizes shall conform to the "American Standards for Nursery Stock" (latest edition) by the American Association of Nurseryman, Inc.
- Plant material shall be nursery grown and be either balled and burlapped or container grown. Sizes and spreads on plant
- list represent minimum requirements. • Quantity lists are supplied as a convenience. Contractor shall verify all quantities, and in case of a discrepancy, the plan
- The Landscape Contractor shall adjust plant locations in field to maintain appropriate spacing from fire hydrants, light poles, all utility structures, driveways and sidewalks. Approval of the Landscape Architect is required when field adjustments to be implemented do not conform to the intent of the plans.
- Contractor shall report any discrepancies in the field to the Landscape Architect and/or Owner.
- The Landscape Contractor shall verify locations of all underground utilities prior to digging, is required to Contact J.U.L.I.E. (1.800.892.0123), and any other public or private agency necessary for utility location 48 hours prior to
- Where underground utilities exist, all field adjustments must be approved by the landscape architect.
- The Landscape Contractor shall water plant material, seed and sod areas until the plants have become adequately established and until final acceptance by the owner. Owner to provide all supplemental watering and proper care and maintenance of all plant materials, seed and sod areas after acceptance of Landscape Contractors work.
- No plants are to be changed or substituted without the approval of the Landscape Architect and the City of Naperville.
- Landscape Contractor shall warrantee all material and labor for a period of one year from the date of final acceptance and shall repair any defects and replace all dead plant material as required during the warranty


Note: Typical Home Planting Plans show the general layout, plant material selections and design intent. Final Plans will be adjusted as required for utilities, drainage and adjacent plantings.


Contractor Quality Control:

Upon Completion of landscape installation, and prior to final acceptance, the Contractor Shall :

- Lightly hand-prune all trees and evergreens to remove broken, crossing or mis-shaped branches.
- On clump-form ornamental trees, remove all minor branches, suckers and stems from the bottom 24" of the main trunks. • Lightly <u>hand-prune</u> all shrubs to remove wild branches and insure <u>uniformity</u> in groups of similar shrubs.
- Dead head all perennials plants to remove all old flowers and dead or discolored foliage.
- Remove all nursery tags and ribbons from all plantings.
- Hand water all plant material.
- Rake out mulch beds to insure a smooth, uniform layer with a sharp, defined spade edge.

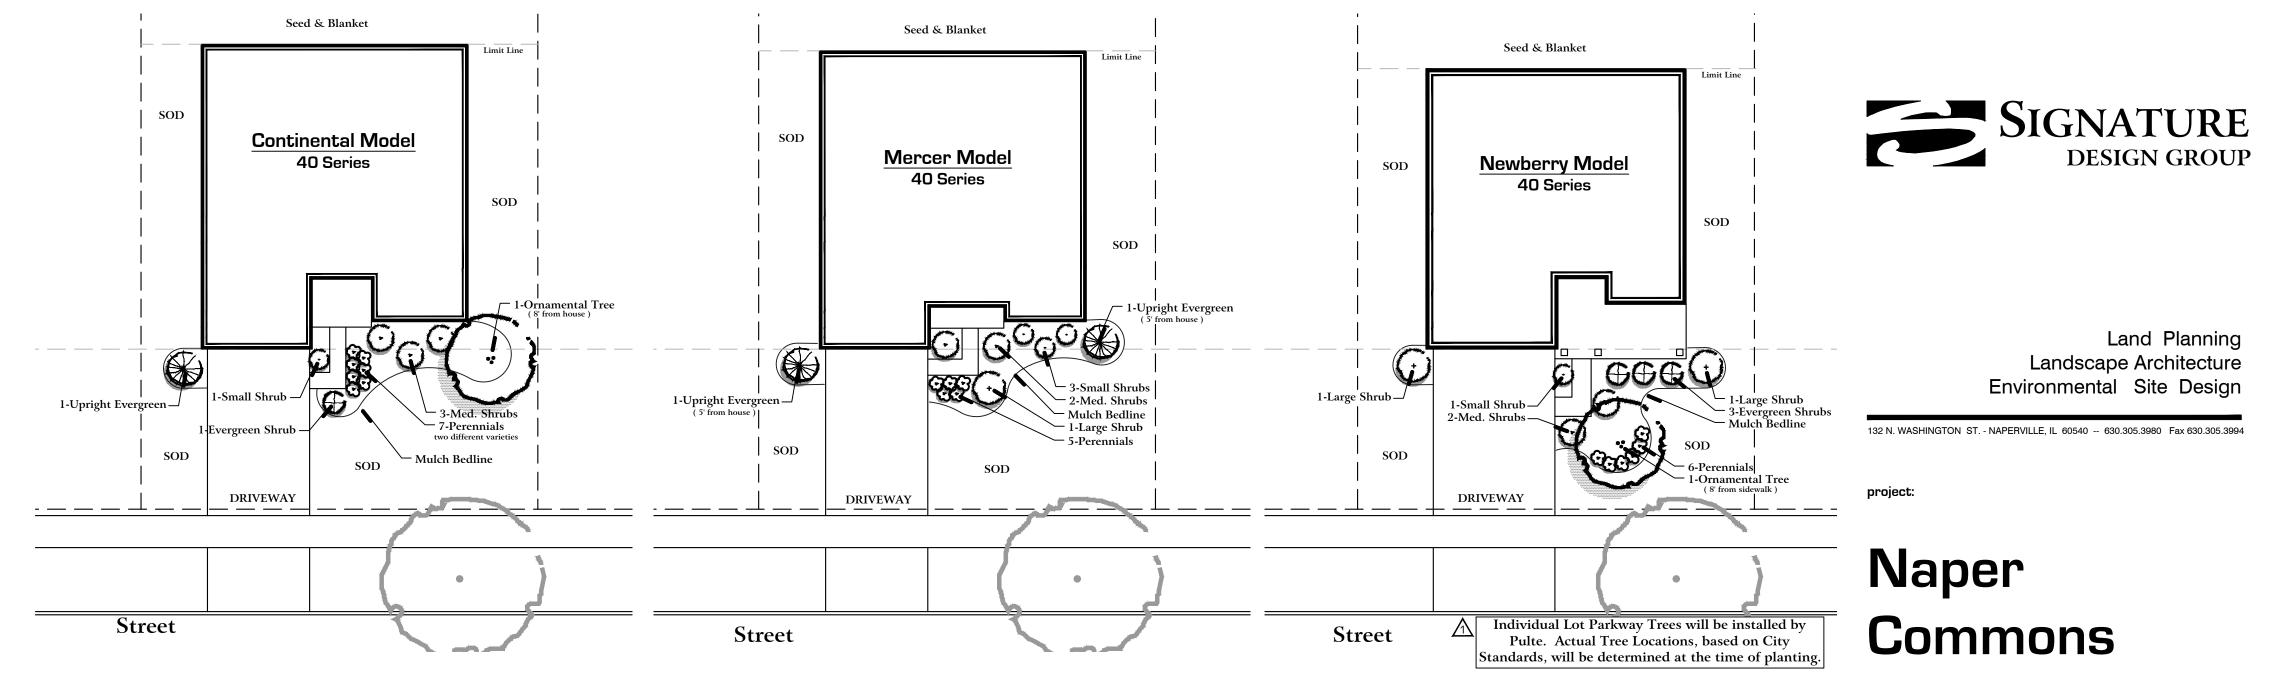

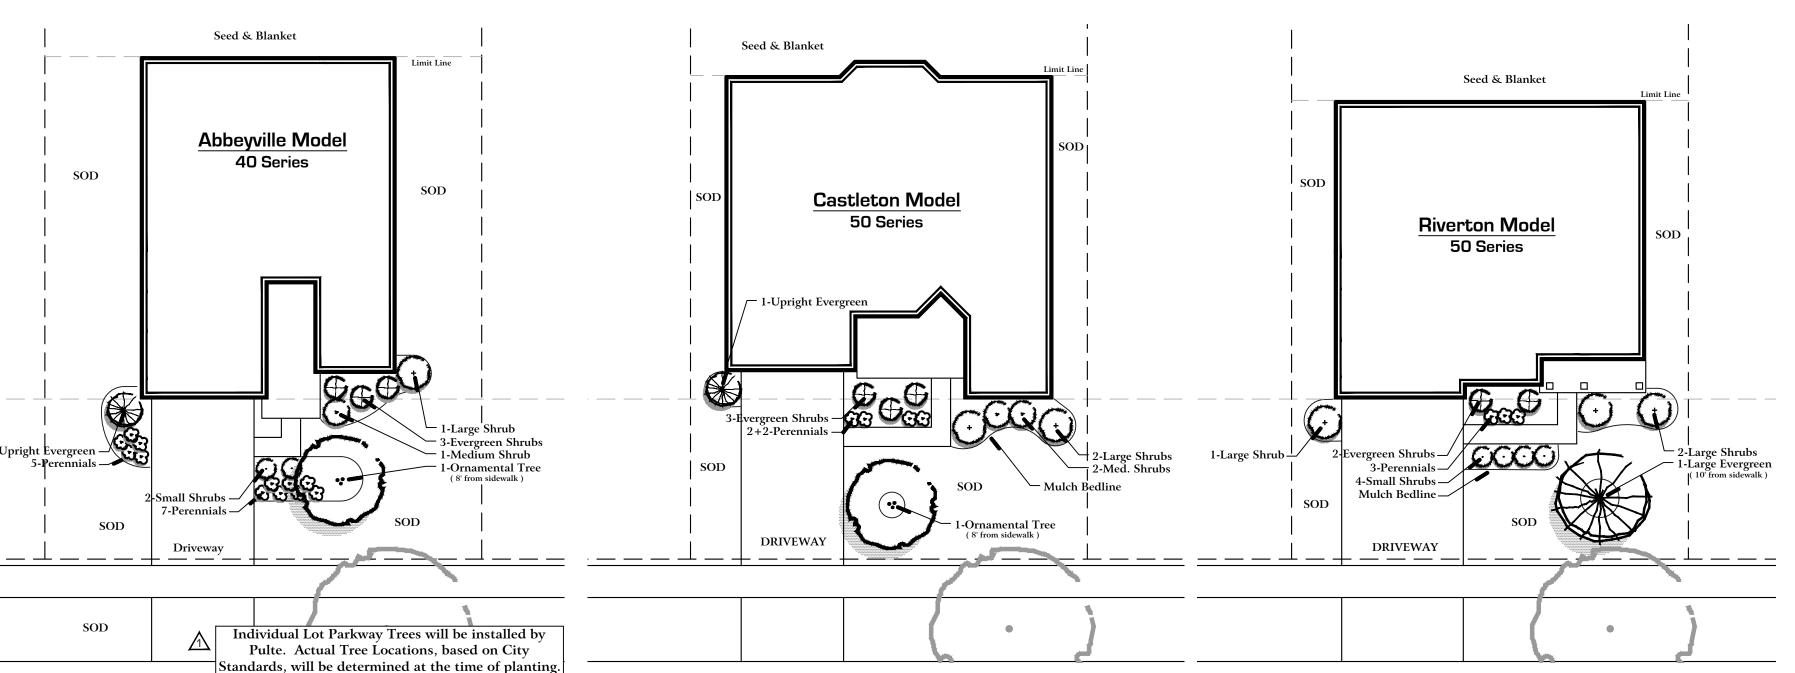

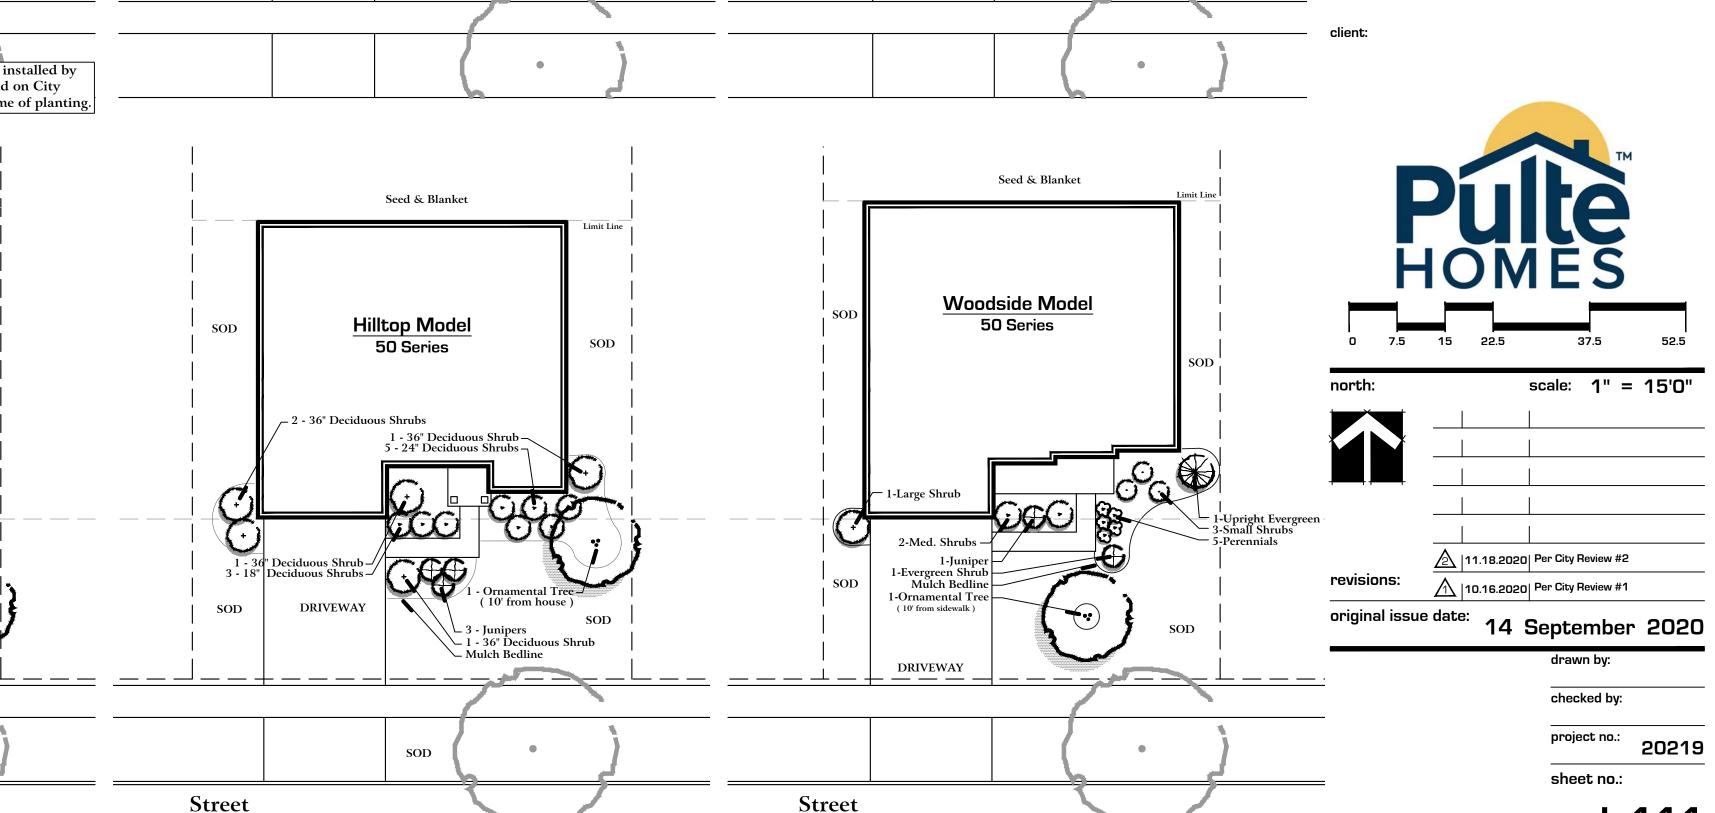

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Landscape Architecture

Land Planning

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Naperville, Illinois

sheet description:

Prototypical House Planting Plans

scale: 1" = 15'0"


/ |11.18.2020| Per City Review #2 10.16.2020 | Per City Review #1

> checked by: project no.: 20219

City of Naperville Project No. 20-10000086

PLANT MATERIAL LEGEND:

(Sheets L.112 only)

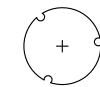

Ornamental Trees, 6' - 8' m/s or 2.5" cal. 20 % Royal Raindrops, 8' or 2.5" 20 % Red Jewel Crab, 8' or 2.5" 20 % Apple Serviceberry, 7' 20 % Eastern Redbud, 6' 10 % Common Witchhazel, 6' (shade) 10 % Ivory Silk Tree Lilac, 6'



Upright Evergreens, 4'-6' tall 40 % Mission Arborvitae, 6' 40 % Fairview Upright Juniper, 5' 20 % Hetz Wintergreen Arborvitae, 4'

20 % Green Velvet Boxwood, 18" 20 % Kallay Compact Juniper, 18" 20 % Hughes Juniper, 18"




Deciduous Shrubs, 18" 36" tall 20 % Peking Contoneaster, 36" (large) 20 % Blue Muffin Viburnum, 36" (large) 20 % Juddi Viburnum, 24" (large) 20 % Limelight Hydrangea, 30" (large) 20 % Miss Kim Lilac, 36" (large)



50 % Annabella Hydrangea, 24" (med.) 20 % Black Chokeberry, 24" (med.) 10 % Knockout Shrub Rose, 18" (med.) 10 % Grefshein Spirea, 24" (med.) 10 % Little Quickfire Hydrangea, 18" (med.)

20 % G.M. Alpine Currant , 18" (small) 20 % Goldmound Spirea, 18" (small) 20 % Bronx Forsythia (small)

20 % Potentilla - Yellow, 18" (small) 20 % Little Princess Spirea, 18" (small)

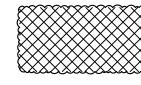

Perennial 20 % Blue Wonder Catmint 20 % Happy Return Daylily 20 % Autumn Joy Sedum 20 % Summer Beauty Allium 20 % Hosta Gold Standard


CONSTRUCTION NOTES:

- Sod all Lot turf areas as noted with an approved blend of improved Kentucky Bluegrass Sod with a mineral soil back.
- Fine grading shall provide slopes which are smooth and continuous. Positive drainage shall be provided in all areas. • Prior to turf installation all areas shall be fertilized with a 12-12-12 granular fertilizer at a rate
- Prepare perennial, ornamental grass, groundcover and annual flower beds with 1 CY. mushroom compost per 100 SF.
- Mulch all trees, shrub, perennial & orn'l grass beds with a minimum of three (3) inches shredded hardwood bark mulch.
- Mulch all groundcover and annual beds with minimum of one (1) inch pinebark fines.
- All bed lines and tree saucers require a 4" deep spaded edge between lawn and mulch areas.
- All evergreen (conifers) trees and shrubs must be grown in a natural shape and not sheared. • Plant material sizing, branching and ball sizes shall conform to the "American Standards for Nursery Stock" (latest
- edition) by the American Association of Nurseryman, Inc. • Plant material shall be nursery grown and be either balled and burlapped or container grown. Sizes and spreads on plant
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- shall prevail. • The Landscape Contractor shall adjust plant locations in field to maintain appropriate spacing from fire hydrants, light
- poles, all utility structures, driveways and sidewalks. Approval of the Landscape Architect is required when field
- adjustments to be implemented do not conform to the intent of the plans. • Contractor shall report any discrepancies in the field to the Landscape Architect and/or Owner.
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- No plants are to be changed or substituted without the approval of the Landscape Architect
- and the City of Naperville.
- Landscape Contractor shall warrantee all material and labor for a period of one year from the date of final acceptance and shall repair any defects and replace all dead plant material as required during the warranty

Note: Typical Home Planting Plans show the general layout, plant material selections and design intent. Final Plans will be adjusted as required for utilities, drainage and adjacent plantings.


Contractor Quality Control:

- Upon Completion of landscape installation, and prior to final acceptance, the Contractor Shall :
- Lightly hand-prune all trees and evergreens to remove broken, crossing or mis-shaped branches. • On clump-form ornamental trees, remove all minor branches, suckers and stems from the bottom 24" of the main trunks.
- Lightly hand-prune all shrubs to remove wild branches and insure uniformity in groups of similar shrubs.
- Dead head all perennials plants to remove all old flowers and dead or discolored foliage.
- Remove all nursery tags and ribbons from all plantings.
- Hand water all plant material.
- Rake out mulch beds to insure a smooth, uniform layer with a sharp, defined spade edge.

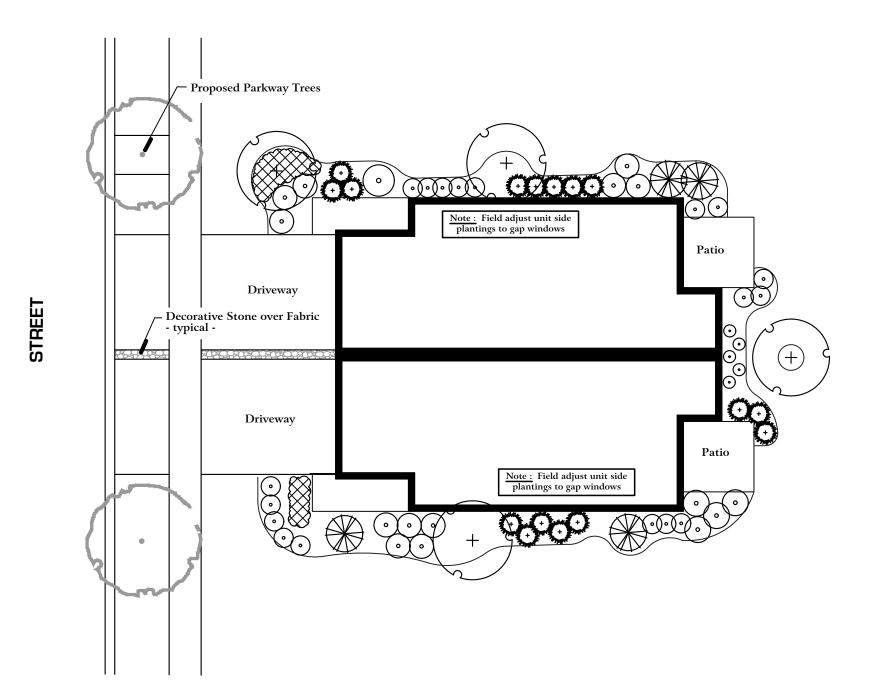

Typical 2 - Unit Building

scale: 1" = 15'0"

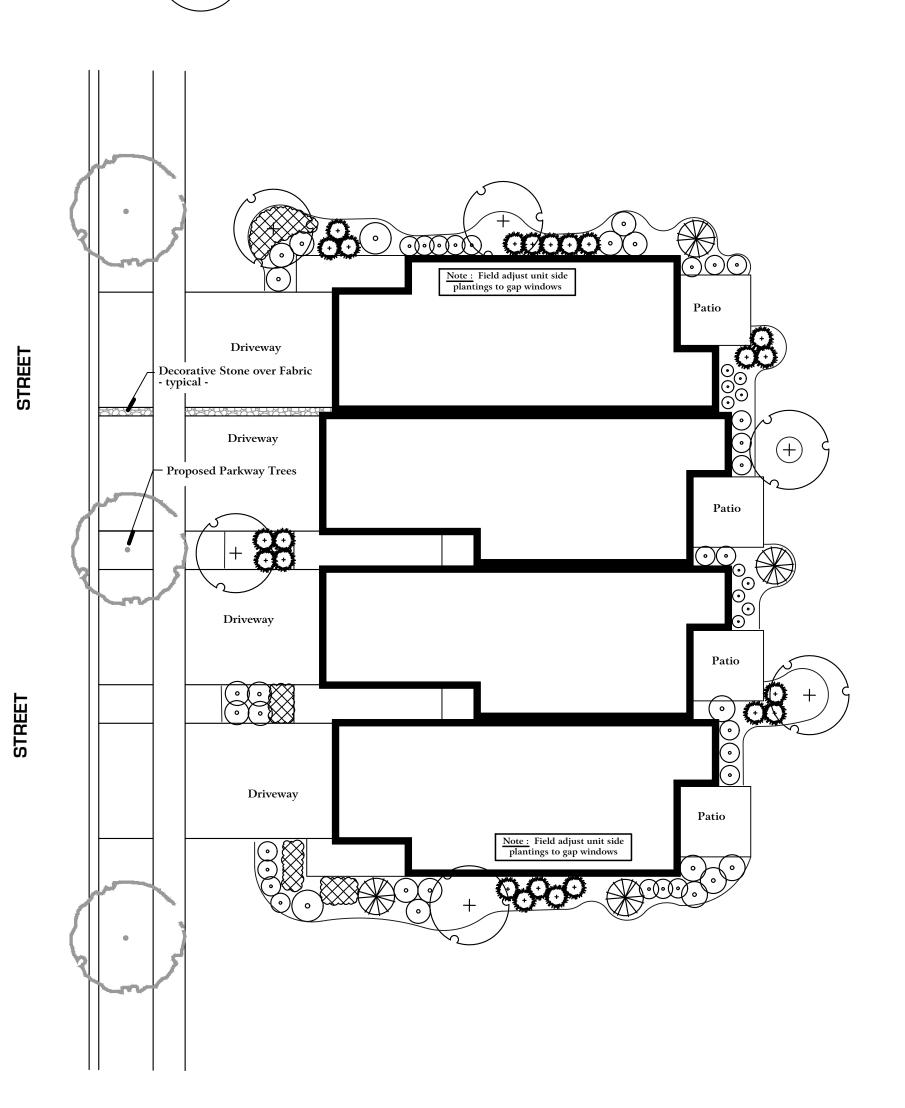

Typical 4 - Unit Building

scale: 1" = 15'0"



Land Planning Landscape Architecture Environmental Site Design

132 N. WASHINGTON ST. - NAPERVILLE, IL 60540 -- 630.305.3980 Fax 630.305.3994

project:

Decorative Stone over Fabric

Driveway

Proposed Parkway Trees

Driveway

Driveway


Note: Field adjust unit side plantings to gap windows

Naper Commons

Naperville, Illinois

sheet description:

Typical Townhome Landscape Package

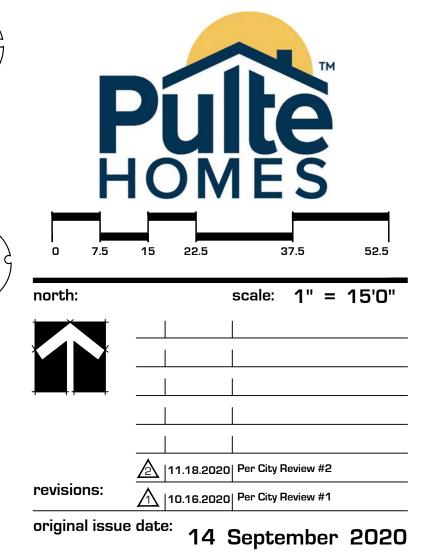


Note: Field adjust unit side plantings to gap windows

scale: 1" = 15'0"

Typical 6 - Unit Building

checked by: project no.: 20219

sheet no.: City of Naperville Project No. 20-10000086

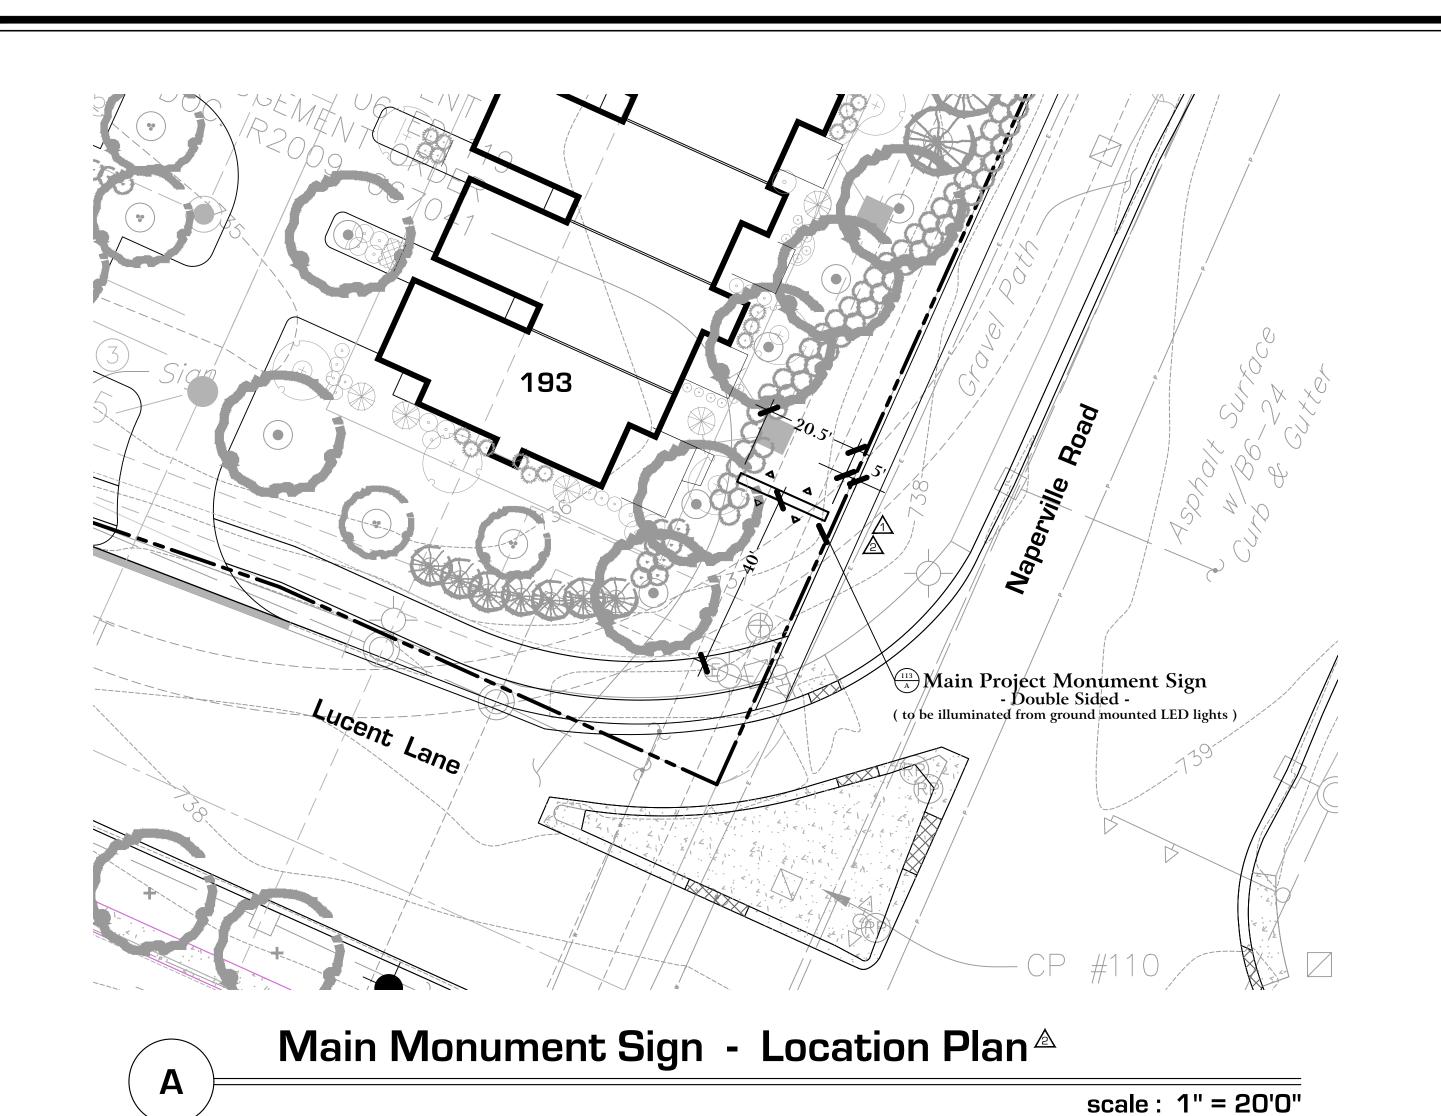

These are Preliminary elevations intended to show overall dimensions, materials and massing. These plans may be modified, or revised, in the Final Design Phase.



Land Planning Landscape Architecture Environmental Site Design


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Naper Commons

Naperville, Illinois

sheet description:


Preliminary Project Signage

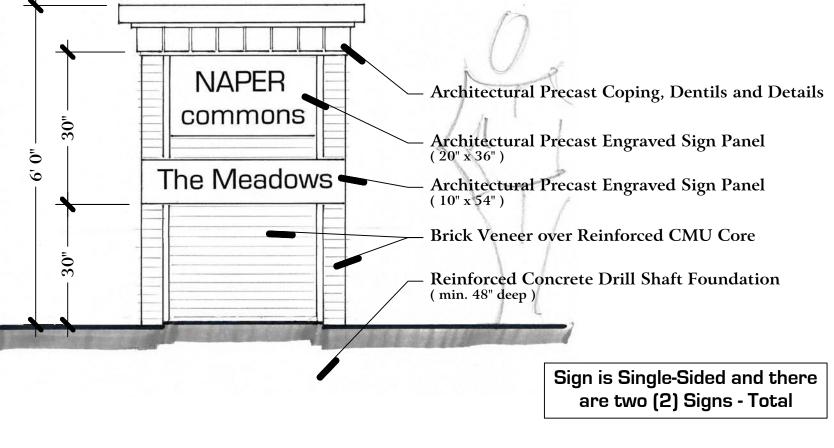

Secondary Monument & Neighborhood Identification Sign

В


scale: N.T.S.

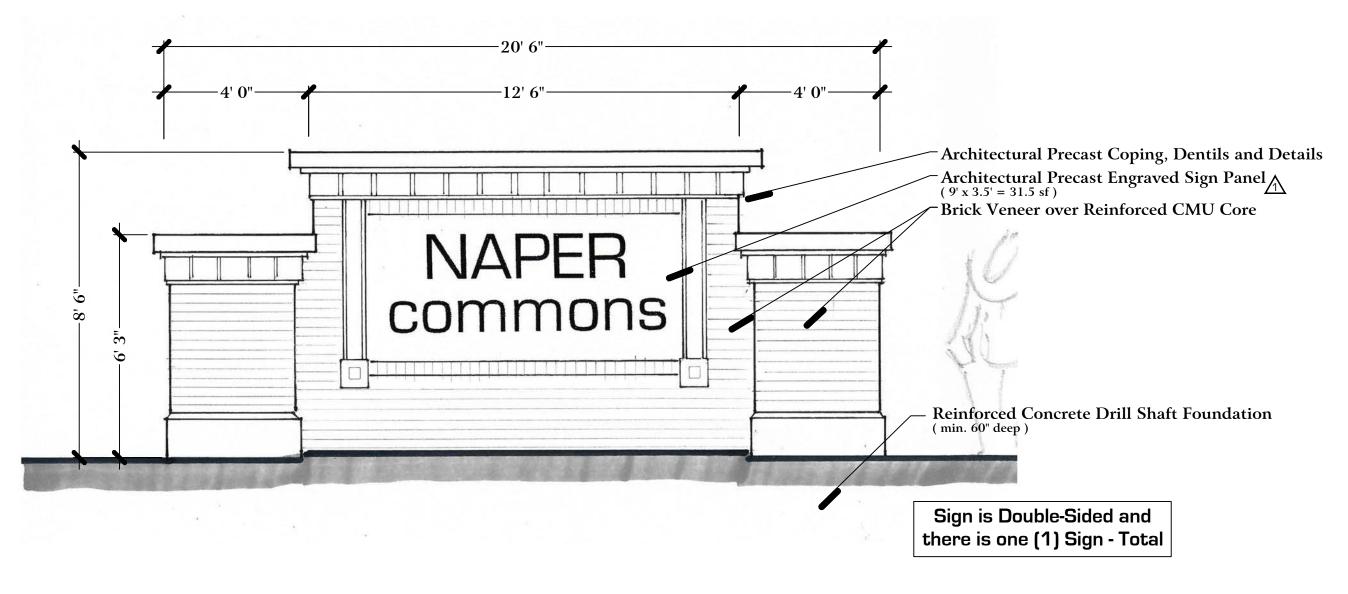

Main Monument Sign - Elevation


Α

approx. scale : $\frac{3}{8}$ " = 1'0"

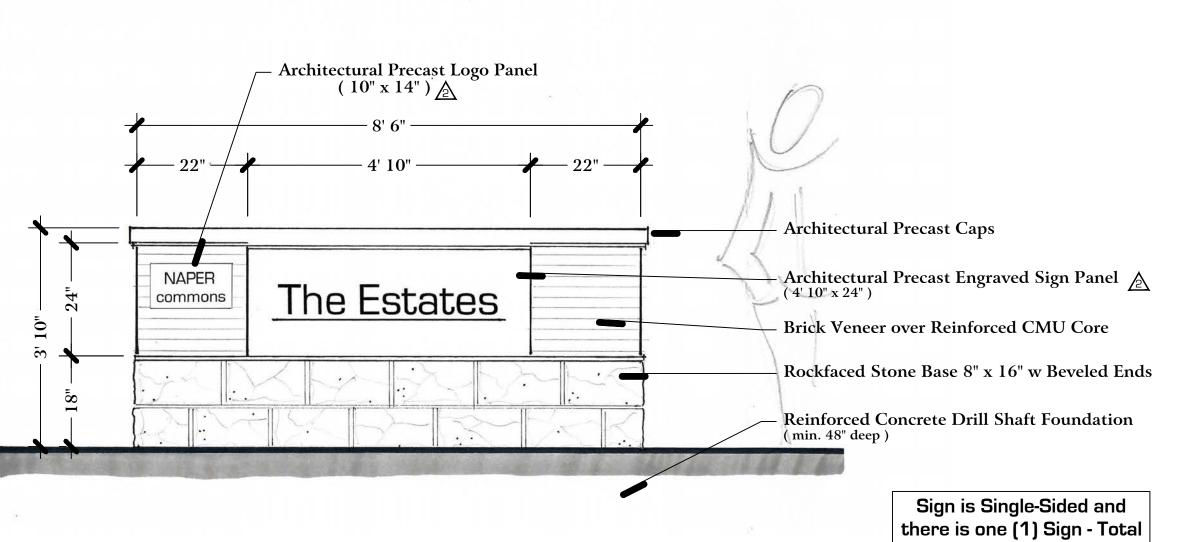

Neighborhood Identification Sign A

approx. scale : $\frac{3}{4}$ " = 1'0"

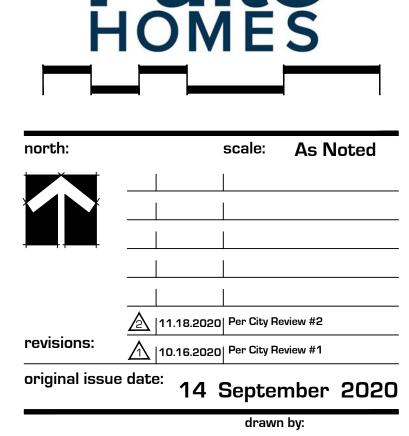

checked by:

project no.:

20219

sheet no.: City of Naperville Project No. 20-10000086