

PROPERTY:

HISTORIC PRESERVATION COMMISSION CERTIFICATE OF APPROPRIATENESS

COA #: 23-3770 **DATE OF ISSUANCE**: 10/27/23

DATE OF APPROVAL: 10/26/23 **BUILDING PERMIT:** Required

APPLICANT: Moses Khalil, 223 Center St., Naperville, IL 60540

OWNERS: MKJH Remodeling, LLC., 223 Center St., Naperville, IL 60540

APPROVED: A Certificate of Appropriateness is hereby issued to authorize the

applicant's request of approval of COA # 23-3770 to relocate and a change in style and material for two second-story windows, and a new roof system with a change in height and pitch and the use of asphalt shingles, and all related work as detailed all the documents attached to this certificate as

EXHIBIT A.

223 Center St.

EXPIRATION: October 26, 2026 - This Certificate of Appropriateness shall expire if the work

authorized by the certificate is not completed by October 26, 2026. The owner and/or applicant may submit a written request to the Zoning Administrator to extend the effective period of the certificate prior to the expiration date. The Zoning Administrator may grant an extension for a period of up to two (2)

additional years without reapplication to the Commission.

The application for the work summarized above was duly heard and considered by the Naperville Historic Preservation Commission at their meeting held on October 26, 2023. Approval was given to issue a Certificate of Appropriateness as noted in the minutes of the meeting. Any changes to the approved Certificate of Appropriateness will require additional approval from the City of Naperville or the Historic Preservation Commission.

Accordingly, I hereby issue the Certificate of Appropriateness for the above work.

Brad Iwicki, Assistant Planner, TED

for Allison Laff, AICP, Deputy Director of TED

CITY OF NAPERVILLE 400 SOUTH EAGLE STREET NAPERVILLE, ILLINOIS 60540-5248 TO SCHEDULE BUILDING AND FIRE PERMIT INSPECTIONS CALL 630-420-6100 OPT. 1 M-F 8AM TO 1PM AND 2PM TO 4PM

CALL 630-420-	6100 OPT. 1 I	M-F 8AM TO	1PM AND 2PM	TO 4PM	
Application Number Application pin nu Property Address Parcel Number: Tenant nbr, name Application type of Subdivision Name Property Use Property Zoning . Application valuat	mber	541350 223 CENTE D-0818126 KA CERTIFICA SLEIGHT'S TWO FAMIL SF & LOW	R ST 0020000N430 HLIL, MOSES TE OF APPROP	-70 RIATENES	
Owner		Co	ntractor		
KHALIL, MOSES 223 N CENTER ST NAPERVILLE (708) 372-5766	IL 60540	OW:	NER		
Permit	. CERTIFICATOR	TE OF APPR	OPRIATENESS Plan Check Fo Valuation .	ee	.00
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Fee summary	Charged				

Permit Fee Total .00 .00 .00
Plan Check Total .00 .00 .00
Grand Total .00 .00 .00

.00 .00 .00

CITY OF NAPERVILLE
400 SOUTH EAGLE STREET
NAPERVILLE, ILLINOIS 60540-5248
TO SCHEDULE BUILDING AND FIRE PERMIT INSPECTIONS
CALL 630-420-6100 OPT. 1 M-F 8AM TO 1PM AND 2PM TO 4PM

Property Ad Parcel Numb Tenant nbr Application Subdivision	ddress oer: , name n descri n Name		CERTIFICATE OF ALSLEIGHT'S 2ND A	OSES PPROPRIATENESS	21/01/23
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Additional	desc .				
		Required :	Inspections		
Seq	Insp Code	Description		Initials	Date
999	COA	COA INSPECT	ION		//

Building Info: 2-Story, Residential Use, Frame Building

DRAWING SHEET INDEX


GENERAL	•	ARCHITE	CTURAL
CS	COVER SHEET & SITE PLAN & DRAWING LIST	A-01	PROPOSED FLOOR PLANS & SCHEDULES
CM	CODE NATRIX	A-02	PROPOSED FLOOR PLANS & WALL TYPES
G-01	GENERAL PROJECT INFORMATION	A-03	PROPOSED ELEVATIONS
G-02	GENERAL PROJECT SPECIFICATIONS	A-04	PROPOSED ELEVATIONS
		A-05	BUILDING ADDITION FOUNDATION & GARAGE EXTENSION
DEMOLITI	ON	A-06	PROPOSED FRAMING PLANS
AD-01	EXISTING-DEMOLITION PLANS	A-07	PROPOSED FRAMING PLANS
AD-02	EXISTING-DEMOLITION ELEVATIONS	A-68	BUILDING SECTION
		A-09	BUILDING SECTIONS
		A-10	REAR DECK & BALCONY PLANS & DETAILS
ELECTRIC	AL	MECHANI	CAL
E-01	POWER & LIGHTING PLANS	M-01	PROPOSED MECHANICAL PLANS
E-02	POWER & LIGHTING PLANS	M-02	PROPOSED MECHANICAL PLANS
E-02	RISER DIAGRAM, LOAD CALCULATIONS,	M-03	LIGHT & VENT & EQUIPMENT SCHEDULE,
	SCHEDULES & PANELBOARDS	-	SPLIT SYSTEM DIAGRAM & MECHANICAL NOTES
		PLUMBIN	S
		P-01	SUPPLY AND WASTE DIAGRAMS

CITY OF NAPERVILLE ADOPTED CODES

2018 INTERNATIONAL BUILDING CODE 2018 INTERNATIONAL RESIDENTIAL CODE 2018 INTERNATIONAL FIRE CODE ILLINOIS PLUMBING CODE

2018 INTERNATIONAL FUEL GAS CODE 2018 INTERNATIONAL PROPERTY MAINTENANCE CODE 2021 INTERNATIONAL ENERGY CONSERVATION CODE

THIS IS TO CERTIFY THAT THESE PLANS WERE PREPARED UNDER MY DIRECT SUPERVISION, AND TO THE BEST OF MY KNOWLEDGE AND BELIEF CONFORM TO THE REQUIREMENTS OF THE CITY OF NAPERVILLE

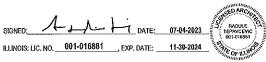

ENERGY CONSERVATION CODE COMPLIANCE STATEMENT

I CERTIFY THAT I AM A THE REGISTERED DESIGN PROFESSIONAL FOR THIS PROJECT, I ALSO CERTIFY THAT TO THE BEST OF MY PROFESSIONAL KNOWLEDGE AND BELIEF THE ATTACHED PLANS FOR: 223 CENTER STREET, NAPERVILLE, IL 60540 FULLY COMPLY WITH THE REQUIREMENTS OF THE 2021 INTERNATIONAL




LIABILITY INSURANCE:

EPAGLIETT INSURANCE, INDI MARNIESS AGREMENT; THE CONTRACTOR SHALL MAINTAIN CONTRACTIAL LIABILITY INSURANCE TO COVER LIABILITY ASSUMED LINGER THE FOLLOWING AGREEMENT; THE CONTRACTOR AND ANY SUBCONTRACTOR SHALL MORNEY AND SAVE HARMLESS OWNER AND AGAINTECTED LINGER THE FOLLOWING AGREEMENT; THE CONTRACTOR AND ANY SUBCONTRACTORS AND LINGER WAS AGREEMENT, AND CONTRACTORS AGREEMENT ANY LOSS, DAMAGE OR DEPENSE FOR WHICH THE OWNER AND ARE MAY EXCELLED THE AGAINTS ON THE CONTRACTORS, AND ARE MAY EXCELLED THE AGAINTS OR SERVANTS INCLUDED AND AGAINT AND AGAINT OF A MAY ANSE OUT OF OR RESILL FROM THE OPERATIONS OF THE CONTRACTOR OR OF THOSE ELEPHOTED BY HE AGAINTS OR SERVANTS INCLUDED HE SUBCONTRACTORS, AND THE EXECUTION OF ANY YORK INCLUDED WAS REPORTED. THE CONTRACTOR AND ARE THE OWNER AND AT THE BURNEY OR DAMAGE WAS CAUGHD THAT OF THE MAJOR OR DAMAGE AND ARE THE AGAINTS, SERVANTS OR EMPLOYEES, OR SY ANY OTHER PRESONS WHOMSOEVER AND THE CONTRACTOR AND ATTEMPT AND ARE THE AGAINTS OR EMPLOYEES, OR SY ANY OTHER PRESONS WHOMSOEVER AND THE CONTRACTOR SHALL AT HIS OWN EXPENSE, MAPPER, DEFENDENT ALL COSTS AND EXPENSES, MICHORISE PLANT OF THE AGAINT OF THE FOLLOWING INDENNIFICATION SHALL ALSO NEULOBE ALL TOWNERS, ARE AND OTHER CONTRACTOR AND SUBCONTRACTOR WHEN ACCEPTING CONTRACTOR. AND EVERY CONTRACTOR AND SUBCONTRACTOR WHEN ACCEPTING CONTRACTUAL COSLICATIONS FOR THIS PROJECT SHALL UNDERSTAND THAT A PRESENDENCY ON THE PROJECT SHALL UNDERSTAND THAT A PRESENCE TO ANY OPERATION AFFORMS THE FLED WITH ACCEPTING ON THAT THEY PAVE INFLIED AGREEMENT TO THE ABOVE TIEM, MOUD MARNIESS AGREEMENT AND ITS SPECEPTC WORDING).

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2. THE INFORMATION SHOWN IN THESE GRAWINGS ARE FOR BIODISC PURPOSES ORAY, THE GENERAL CONTRACTOR SHOULD SHALL SHALL BE SHALL BEFORE SHALL BE SHALL B





y Residence. Interior Rehab in including New Partitions, & Plumbing Systems, New leck & Balcony per Plans.

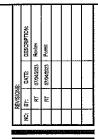

LOCATION: 223 Center Street Vaperville, IL 60540

Title Sheet

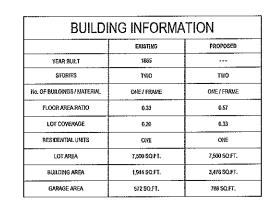

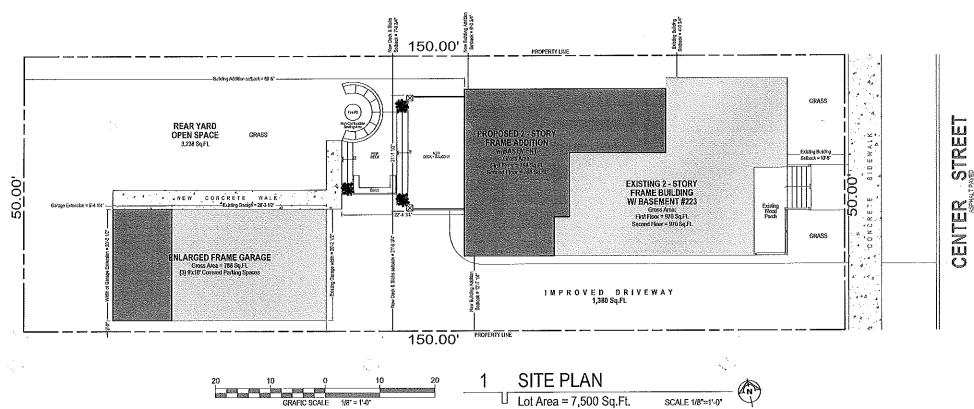





R.T. ARCHITECT INC.

RADLE TEPAVCEVIC
7501 BROWN AVE. SUITE A
FOREST PHON. L 60130
Tepavceric@asl.com

PROJECT ARCHITEC RT DRAFTPERSON: CS APPROVED: RT

PREPARED FOR: OWNER LOCATION: 223 Center Street Naperville, IL 60540 JOB NUMBER: 223CS-07042023

SHEET No.:

SHEET Name: Site Plan SP

ABBREVIATIONS

		6		0	
AC	Acoustical celling	GA CALLY	Gauge	QTY	Quanky
A/C	Air conditioning	GALV	Galranized	1-1	
ADJ	Adaced	GL GL	General Contractor	R	Radius
ALT	Abore finished Boor Alternate	GRD	GE#ss Ground	RAD	Radus
ALI	Ahardrum Ahardrum	GWB	G) psum Walfroard	RD:	Roof Drain
ALUM	Attention	GYP		REF	Reference
ALUM AP		GIP	Q ¹ bau	REDG	Reinforced, Reinforcing
APPROX	Access panel	1		REOD	
APPROX	Approximately	н	V 01 1		Required
- 1		HB	Hose Bibb	REV	Revise(d), Revision
8		HG	Handkapped Accessible	RN	Room
DV	Bottom, Bottom of	HOVYE	Hardware	RO	Rough Opening
BD	Board	HM	Hotow Metali		
BLDG	Building	HORIZ	Horizontal	s	
BLK	Block Blocking	HP	High Point	S	South
BM NB	Beam	HYAC	Healing, VentRation & A/C	SC	Sold Core
BSMT	Basement	,		SECT	Section
				\$F	Square feet
S		32	Inch	SHT	Sheet
CAB	Cathret	INSUL	Installed, Insulation	SEAT	Similar
C/C	Center-to-center	BAT	Interior	SPEC	Specification
CI	Central joint			SPKR	Spea'ter
cı	Center line)		SPRK	Sprinkler
CFC	Celing	Я	Joînt	SS	Stahless Steel
CLR	Clear			ST	Stahless
CNSU	Concrete Masonry Unit	TLT		SID	Standard
COL	Column	LAM	Lamhubi	STL.	Steel
CONC	Concreta	LAY	Lareby	STRUCT	Siructural
CONST	Construction	LP	LowPoint	SUSP	Suspended
CONT	Continuous	£Y	Light		ОСРЕМО
CORR	Contdor	LTG	Lighting	T	
CPT	Carpet	110	14.4	T- T	Top of
GF	Ceranic Re	11		TAB	Top and bottom (of)
O1	Casur se	MACH	Machine	18G	
. 1		MAS		18G TEL	Tongue & groove
)			Masony		Telephone
DIA	Diameter	MATL	Material	THK	TNA
DRM	Dimension	MAX	Maximum	TYP	Typical
DN	Dose	MECH	Mochanical		
DR	Door	MFR	Macefecturer	U	
DΠ	Delait	WDS	Micros	UL	Underwriters Laboratory
DWG	Drawing	MISC	Wiscetaneous	UNO	Unless noted of envisa
		MO	Masony Opening		
:		АПL	Metal	٧	
E	Easl	MULL	Multion	VΒ	Vapor Barrier
EA	Eath			VCT	Viryl Composition Tile
					Vertical
ELEC	Electric, Electrical	N		VERT	YELU, AL
ELEC	Electric, Electrical Elevator, Elevation	N	North	YERT	Verity in field
			North Noncombustate		
ELEV	Elevator, Elevation Equal	n		YIF	Verity in field Ving 112a
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WORKING DRAWING NOTES

- 1. CONTRACTOR SHALL VERIEY AND COORDINATE ALL NEW AND EXISTING CONDITIONS AND DIMENSIONS AT JOB SITE FOR COMPARISON WITH DRAWINGS AND SPECIFICATIONS PRIOR TO BIDDING AND START OF AND DURING CONSTRUCTION. IF ANY DISCREPANCIES OF OMISSIONS ARE FOUND, THE ARCHITECT SHALL BE NOTIFIED, IN WRITING FOR
- CLARFICATION PRIOR TO PROCEEDING WITH WORK.

 2. DO NOT SCALE DRAWINGS, CONTRACTOR SHALL RELY ON WRITTEN DIMENSIONS GIVEN. THE CONTRACTOR SHALL NOTIFY THE ARCHITECT FOR CLARIFICATIONS, ALL DIMENSIONS SHALL BE FIELD VERIFIED BY CONTRACTOR AND COORDINATED WITH ALL OF THE WORK OF ALL TRADES. IF DISCREPANCIES ARE FOUND , THE CONTRACTOR SHALL NOTIFY THE ARCHITECT IN WRITING FOR CLARIFICATION BEFORE THE COMMENCEMENT OR RETURN
- ARCHITECT OF ANY ABBREVIATIONS IN QUESTION.
- FINISH FACE OF WALL, MASONRY, OR CONCRETE, UNLESS OTHERWISE NOTED.

 5. IN THE CASE OF A CONFLICT BETWEEN THE DRAWINGS AND SPECIFICATIONS
- CONSTRUCTION MANAGER OF ANY CONFLICT BEFORE PROCEDURG WITH THE WORK.

 1. THE SPECIFICATIONS AND ALL CONSULTANT DRAWINGS ARE SUPPLEMENTAL TO THE ARCHITECTURAL DRAWINGS. IT SHALL BE THE CONTRACTOR'S RESPONSIBILITY TO COORDINATE WITH ARCHITECTURAL DRAWINGS BEFORE THE INSTALLATION OF ANY OF THE CONSULTANT'S WORK AND TO BRING ANY DISCREPANCIES OR CONFLICTS TO THE ATTENTION OF THE ARCHITECT, IN WRITING FOR CLARIFICATION, IMPROPERLY INSTALLED WORK SHALL BE CORRECTED BY THE GENERAL CONTRACTOR AT HIS EXPENSE AND AT NO EXPENSE TO THE ARCHITECT, HISHER CONSULTANTS, OR THE OWNER.
 7. THE ARCHITECT SHALL BE CONSULTED IN ALL CASES WHERE CUTTING INTO AN EXITING.
- STRUCTURAL PORTION OF ANY BUILDING IS EITHER EXPIDIENTOR NECESSARY, PRIOR TO PROCEEDING WITH WORK, REINFORCEMENT AND/OR SUPPORT SATISFACTORY TO ARCHITECT AND STRUCTURAL ENGINEER SHALL BE PROVIDED BY CONTRACTOR PRIOR TO CUTTING INTO STRUCTURAL PORTIONS OF ANY BUILDING.
- 8. LEGAL EXITS SHALL NOT BE BLOCKED AT ANY TME. 9. FINAL CLEAN UP AND DISPOSAL; REMOVE DEBRIS, RUBBISH, AND WASTE MATERIALS FROM THE OWNERS PROPERTY TO A LAWFUL DISPOSAL AREA AND PAY ALL HAULING AND DUMPING COSTS, CONFORM TO PERTAINING FEDERAL STATE AND LOCAL LAWS. REGULATIONS AND ORDERS UPON COMPLETION OF WORK, ALL CONSTRUCTION AREAS SHALL BE LEFT VACUUM-CLEAN AND FREE FROM DEBRIS, CLEAN ALL DUST, DIRT, STAINS,
- REPRESENTATIVE.
- 11. WHEN IT IS NECESSARY TO INTERRUPT ANY EXISTING UTILITY SERVICE TO MAKE CORRECTIONS AND/OR CONNECTION, A MINIMUM OF 48 HOURS ADVANCE NOTICE SHALL BE GIVEN TO THE OWNER, INTERRUPTIONS IN UTILITY SERVICES SHALL BE OF THI SHORTEST POSSIBLE DURATION FOR THE WORK AT HAND AND SHALL BE APPROVED IN ADVANCE BY THE OWNER.

 12, IN THE EVENT THE UTILITY SERVICE IS INTERRUPTED WITHOUT THE REQUIRED 48 HOUR.
- NOTICE, THEN THE CONTRACTOR SHALL BE FINANCIALLY LIABLE FOR ALL DAMAGES SUFFERED BY THE OWNER DUE TO THE UNAUTHORIZED INTERRUPTION. RECONNECTION SHALL BE MADE #/MEDIATELY.
- 13. IF THE CONTRACTOR ASCERTAINS AT ANY TIME THAT THE REQUIREMENTS OF THIS CONTRACT CONFLICT WITH, OR ARE IN VIOLATION OF APPLICABLE LAYS, CODES, REGULATIONS, AND ORDINANCES, HE SHALL NOT PROCEED THE WORK IN QUESTION, EXCEPT AT HIS OWN RISK, UNTIL ARCHITECT HAS BEEN NOTIFIED IN WRITING AND WRITTEN DETERMINATION IS MADE BY THE ARCHITECT, WHERE COMPLETED OR PARTIALLY COMPLETED WORK IS DISCOVERED TO BE IN VIOLATION WITH APPLICABLE LAWS, CODES, REGULATIONS AND ORDINANCES, CONTRACTOR SHALL BE REQUIRED TO REMOVE THAT WORK WITH ALL NEW COMPLYING WORK AT NO ADDITIONAL EXPENSE TO THE OWNER, ARCHITECT OR CONSULTANTS,

 14. ANY WORK INSTALLED IN CONFLICT WITH THE CONTRACT DOCUMENTS SHALL BE
- CORRECTED BY THE CONTRACTOR AT HIS/HER EXPENSE AND AT NO ADDITIONAL EXPENSE TO THE OWNER, ARCHITECT OR CONSULTANTS.

 15. THE CONTRACTOR SHALL BE RESPONSIBLE FOR VERIFYING FLOOR-TO FLOOR
- ELEVATION WITH RESPECTIVE FLOORS IN EXISTING BUILDING.

 16. THE CONTRACTOR SHALL FURNISH ALL MATERIALS, LABOR, EQUIPMENT, TRANSPORTATION AND SERVICES NECESSARY FOR THE SATISFACTORY COMPLETION OF

- 18. THE CONTRACTOR SHALL PROVIDE ALL NECESSARY PERMITS AND INSPECTIONS.
 19. SPECIAL NOTICE TO CONTRACTOR: ALL CONTRACTORS PERFORMING WORK ON THE PREMISES SHALL BE RESPONSIBLE FOR INITIATING, MAINTAINING AND SUPERVISING A REASONABLE AND PRUDENT SAFETY PROGRAM INCLUDING BUT NOT LIMITED TO THE ISOLATION OF YORK AREAS AND PROMPT REMOVAL OF ANY DEBRIS OR TOOLS WHICH MAY ENDANGER VISITORS AND STAFF OF THE OWNER OR ARCHITECT.

- 5'-0" DEEP INTO WHICH PERSONS MUST DESCENT.
- 23. CONTRACTOR AND SUBCONTRACTORS SHALL BE RESPONSIBLE FOR OBTAINING AND PAYING ALL PERMITS AND FEES REQUIRED, NOT NORMALLY COVERED BY THE BUILDING
- 24 DRAWINGS OF EXISTING CONDITIONS HAVE BEEN COMPILED FROM EXISTING DATA SUPPLEO BY THE OWNER TO THE ARCHITECT. THE ARCHITECT MAKES NO WARRANTY EITHER EXPRESSED OR IMPLIED, FOR THE ACCURACY OR COMPLETENESS OF THE EXISTING INFORMATION RECORDED, CONTRACTOR SHALL FIELD VERIFY ALL EXISTING
- 26, OVERHEAD DOORS ARE NOT PERMITTED AS EXIT DOORS.
- 27, THE CONSTRUCTION OR DEMOLITION OF ANY BUILDING STRUCTURE, SCAFFOLDING OR FALSEWORK MORE THAN THREE STORIES OR 36-0" IN HEIGHT REQUIRES A PERMIT FROM THE STATE OF ILLINOIS DIVISION OF INDUSTRIAL SAFETY (OR EQUAL) PRIOR TO THE
- BE PLAINLY VISIBLE AND LEGIBLE FROM THE STREET

W000
 SOUIDERNIYELLDNYPWE, PRESSURE TREATED USING ACQ-C, ACQ-D, CRAA OR CA-B PRESERVATIVE. GRADE NA.1 OR BETTER SHALL BE USED FOR COLUMNS AND GRADE NA2 OR BETTER SHALL BE USED FOR ALL OTHER MAYERRS.
 ALL WOOD CONSTRUCTION SHALL CONFORM TO THE AITC (AMERICAN INSTITUTE OF TRYBER CONSTRUCTION AND THE APA (AMERICAN PLAYMOOD ASSOCIATION) NATIONAL DESIGN SPECIFICATIONS.
 ALL WOOD CONSTRUCTION EXPOSED TO WEATHER TO BE PRESSURE TREATED.

FASTENERS

TO WORK.

3. ABBREVIATIONS THROUGHOUT THE PLANS ARE THOSE IN COMMON USE, NOTIFY THE

4. DIMENSIONS SHOWN ON FLOOR PLANS, SECTIONS, ELEVATIONS, AND DETAILS ARE TO

SPECIFICATIONS SHALL TAKE PRECEDENCE, CONTRACTOR SHALL NOTIFY THE

HANDMARKS, PAINT SPOTS, DROPPINGS AND OTHER BLEMISHES. 10. PRIOR TO INSPECTION OF EXISTING FACILITY, THE CONTRACTOR MUST RECEIVE PERMISSION FOR SITE ACCESS FROM THE OWNER OR THE DESIGNATED

ELEVATIONS; THE NEW BUILDING EXPANSIONS GROUND FLOOR SHALL ALIGN IN

WORK UNLESS DESIGNATED (H.LC) OR (O.F.O.L), ALL EQUIPMENT, WORK AND MATERIALS SHALL COMPLY WITH ALL CURRENT AND LOCAL APPLICABLE CODES AND GOVERNING REGULATIONS, AND CONTRACT DOCUMENTS.

17. THE CONTRACTOR SHALL PROTECT ALL FINISH WORK AND SURFACES FROM DAMAGE DIRING THE COURSE OF CONSTRUCTION AND SHALL REPLACE ANDOR REPAIR ALL DAMAGED SURFACES CAUSED BY THE CONTRACTOR OR SUBCONTRACTOR PERSONNEL TO THE SATISFACTION OF THE OWNER AND ARCHITECT.

20. THE CONTRACTOR SHALL VERIEV THE LOCATION OF ALL EXISTING UTILITIES BELOW GRADE AND RELATED SERVICE CONNECTIONS WITH THE RESPECTIVE UTILITY

21. THE CONTRACTOR SHALL PROVIDE SANITARY FACILITIES FOR WORKER'S USE, EXISTING FACILITIES SHALL AND MAY NOT BE USED.

22. THE CONTRACTOR SHALL OBTAIN OSHA PERMITS FOR ANY VERTICAL EXCAVATION OVER

CONDITIONS, NOTIFY ARCHITECT IN WRITING OF ANY DISCREPANCIES FOR CLARIFICATION

PRIOR TO PROCEEDING WITH WORK.

25. THE EXIT DOOR MUST OPEN OVER A LANDING NOT MORE THAN 1-0" BELOW THE

28, APPROVED NUMBERS AND ADDRESSES SHALL BE PROVIDED IN SUCH A POSITION AS TO

MATERIAL NOTES

	MATERIALS USED FOR IN	FERIOR WALL AND CEILING FINISH S
	STAIRWAYS, PUBLIC L	OBBIES & PUBLIC CORRIDORS
KY PINE, PRESSURE TREATED USING ACQ-C, ACQ-D, CR4-A OR C4-B PRESERVATIVE, GRADE HALL BE USED FOR COLUMNS AND GRADE M/2 OR BETTER SMALL BE USED FOR ALL OTHER	BUSINESS UNITS	
	RESIDENTIAL UNITS	
RUCTION SHALL CONFORM TO THE ALTC (AMERICAN INSTITUTE OF TIMBER CONSTRUCTION) ERICAN PLYYCOOD ASSOCIATION INATIONAL DESIGN SPECIFICATIONS.	FLANE SPREAD RATING	
RUCTION EXPOSED TO WEATHER TO BE PRESSURE TREATED.	CLASSIFICATION	FLAME SPREAD RATEIG
	CLASS 1	0 TO 12
	CLASS 2	26 TO 76

ASTENERS SHALL BE AS FOLLOWS: 1. MALS, STANLESS STEEL OR HOT-DIPPED GALVANIZED, SZED AS SPECCED IN DETAILS, 2. DECK SCENERS, 20°F 10 3-12° LOWS, AS JURNAUM SIZE, STANLESS STEEL OR HOT-DIPPED 3. LAS BOILS STANLESS STEEL OR HOT-DIPPED GALVANIZED, SUED AS SPECCED IN GET MALL DE SAE GRADE SZ. HEX BOLTS: STAPALESS STEEL OR HOT-DIPPED GALVARIZED, SIZED AS SPECIFIED IN DETAILS. MATERIAL

CONCRETE

CURRENTE ID.

ALL CONCRETE WORK SHALL BE IN ACCORDANCE WITH THE "AVERICAN CONCRETE INSTITUTE BUILDINGS CODE", (ACI 18) AND WITH "PRECIPICATIONS FOR STRUCTURAL CONCRETE FOR BUILDINGS" (ACI 30), LATEST BOTTOM.

ALL LINGURUL, VERGERT CONCRETE (HS P.C.F.) SHALL HAVE INVIDUANZED BAY COMPRESSIVE STREINGTH AS FOLLOWS.

FOOTINGS. - 200 PSI
FOOTINGS. - 200 PSI
FOOTINGS. - 200 PSI
FOOTINGS. - 200 PSI
FOOTINGS - 200 PSI

- ENCLOSING THE BUILDING.

 CALCIAN CHLORIDE AND/OR ADVINJURIES CONTAINING CALCIAN CHLORIDE SHALL NOT BE USED IN CONCRETE.

 ALL CONCRETE SUBJECT TO EXTERIOR EXPOSURE WITH SPECIFIED STRENGTH LESS THAN 6000 PSI SHALL BE
- ALC COMMENTER SERVICES TO EXPERIENTATION OF THE PROPERTY OF THE SERVICE OF THE SE
- WITH THE CITY OF NAPERVALIS

REINFORCEMENT BARS

1. REINFORCEMENT BARS SHALL BE ASTM A615, GRADE 60 STEEL.

MASONRY

. Masonry units shall comply viith applicable as im standards, and mortar shall be type mors, with the $1,150\,\mathrm{PS}$

METAL CONSTRUCTION CONNECTORS

I, SIMLL BE STAMESS STEEL, HOT-EPPED OALVAINZED OR TIBER IZ ZIC OALVANZED GET-SIS, SMPSONT STROME TE, UNITED STEEL PRODUCTS OR BOOM, TO BE USES FOR JOST HANGER, COLUMBUSCUM STEEP AND METAL MAKE COVINCETONS, KOIE THAT IT HOT DEPTED OALVANZED OR TIPELZ ZIC OALVANZED COCRECTIONS AND USED, ALL THE FASTENERS FOR THAT COMERCITION MAST OR HOT DE CALVANZED SAN LL, SICKE HE STAMESS STEEL COLUM DAVINGE HE OALVANZED.

FLASHING AND SEALANTS

FLASHING SHALL BE 28 GA. STANKESS STEEL ((0.015 in MODRIAN THEXNESS ASTMALO), TYPE 504) OR 18x ROLLED COPPER ((0.01 in INSTRUME) THEXNESS ASTM BAT(), CARLISLE COMINGS COVETOS SELF-ADERWAS VAPORAMIR EMBERT SYSTEM OR ROLL SHALL BE USED FOR THE VAPOR AMBRIEST IT THE CEOGER BEAM COVERCTIONS, SEALANT SMALL DE 100% SULCINE RUIDBER SEALANT WITH A SU YEAR BURBABLITY.

STRUCTURAL STEEL

ALL STRUCTURAL STEEL SHALL BE ASTM A-36, COATED WITH A RUSY PROMOTED PROVER WITH A PREMARA DRY THEORIESS OF 3 NELS.

TABLE A - METAL CONNECTORS

ITEM	SST MODEL#	USP MODEL#	GAGE	INSTALLATION HARDWARE
SINGLE JOIST PANGER 1	LUSZID Z OR SS	JUS210 TZ, SS	18	4-10d (Jolst), 8-10d (Header)
DOUBLE JOIST PANGER 2	LUS210-2Z OR SS	JUS210-2TZ, 5S	18	6-15d (Joist), 8-16d (Header)
SNGLE JOIST PANGER 3	EU\$28 Z	JUS28 TZ, SS	18	4-10d (Jolst), 6-10d (Header)
DOUBLE JOIST PANGER 4	LU\$28-2Z	JUS28-2TZ	18	4-165 (Jolst), 6-16d (Header)
METAL ANGLE 1	190 Z	AC9 TZ	16	10-10d, 5 each Leg
METAL ANGLE 2	A23 Z	A3 TZ	18	'8-10d x 1-1/2', 4 each Leg
METAL ANGLE 3	TA9 Z OR KT	SCA9 TZ	12	5-1/4" dis. x 1-1/2" wood Scre-r
COLUMN BASE, 6'35' POST	€BSQ66-SQS2 HDG	CBS066-SDS2TZ	12	14-1/4" dis. x 2" wood Screes
COLUMN BASE 5 15 POST	ABU66Z		12	12-16d, (2) 1/2" Ø Boi's, 5/8" Anchor
POST BASE, RAILING POST	PB\$44A HDG	WAS 44 TZ	12	14-16d, (2) 1/2" dla, Bolts
METAL STRAP	JASTA12 Z OR SS	MSTA12 TZ, SS	18	10-10d
POST BASE PLATE	CP\$4	CPB44	-	4-10d

NOTES.

1. USS SMALLER LENGTH IMALS WITH SPECIFED PENTY YEIGHT.

2. SST = SWYSON STRICHS TE. USP = UNITED STEEL PRODUCTS, HOG = HOT DIPPED GALVANZED

SS = SMAN ESS STEEL Z = Z-MAX GALVANZED (G-185) TZ = TRAFE ZZYC GALVANZED (G-185)


FLAME SPREAD RATING


MATERIALS USED FOR IN	TERIOR WALL AND CEILING FINISH	SHALL CONFORM AS FOLLOWS:					
STAIRWAYS, PUBLIC I	OBBIES & PUBLIC CORRIGORS	CLASS 1					
BUSINESS UNITS		CLASS 2					
RESIDENTIAL UNITS		CLASS !					
FLAME SPREAD RATING							
CLASSIFICATION	FLAME SPREAD RATEG	SYOKE DEVELOPED					
CLASS 1	0 TO 12	200					
CLASS 2	26 TO 76	450					
CLASS 3	76 TO 200	450					


BUILDING DESIGN LOADS


ROOF LOADS		
TWE TOAD	15 PSF	
DEAD LOAD	15 PSF	
SNOW LOAD	25 PSF	
DRIFT SNOW LOAD	16 P6F	
irst floor loads		
LIVE LOADS		
RESIDENTIAL	40 PSF	
DEAD LOADS	20 PSF	
ATERAL LOADS		
YEND LOADS	20 PSF	

GENERAL DRAWING SYMBOLS

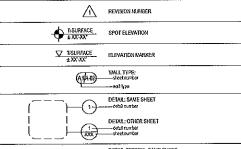

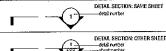


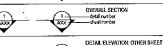

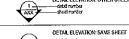





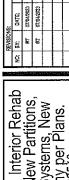

Convert 2-Unit to Single Family Residence. Interior Rehab & New 2-Story Frame Addition including New Partitions, New Electrical, Mechanical & Plumbing Systems, New Roof System & New Rear Deck & Balcony per Plans. 223 Center Street, Naperville Illinois 60540



PROJECT ARCHITECT IOB NUMBER: 2230S-0704202

SHEET No. G-01

SHEET Name: General Project Information



DIVISION 1 GENERAL REQUIREMENTS

- 1. ALL WORK SHALL BE PERFORMED IN ACCORDANCE WITH ALL APPLICABLE LOCAL, STATE AND NATIONAL CODES AND ORDINANCES AND ALL AUTHORITIES HAVING JURISDICTION.
- 2. THE CONTRACTOR SHALL VERIFY ALL DIMENSIONS AND CONDITIONS BEFORE PROCEEDING WITH WORK AND NOTIFY THE CONTRIVENCY SPACE YEARY TALL DIMENSIONS AND COLUMNAS SECTION PROJECTIONS WITH MOVE AND NOTIFY
 SUPERINTENDENT AT ONCE OF ANY DISCREPANCIES PRIOR TO COMMERCING VIORA.
 PLUMBING SCHEMATIC DRAYING, HVAC DRAYING, SEVIER MAIN, ELECTRICAL DUTLETS, SWITCHES, LIGHT LOCATIONS
 FOR ROUTING ALL PLUMBING, MECHANICAL AND ELECTRICAL WORK IS TO BE COORDINATED BETWEEN THE TRADES
- AFFECTED BY THE WORK AS PART OF THEIR INSTALLATION LAYOUT, NO PLUMBING, MECHANICAL OR ELECTRICAL INFORMATION IS TO BE SCALED FROM THE DRAWING.
- 4. ON-SITE VERIFICATION OF ALL DIMENSIONS AND CONDITIONS SHALL BE THE RESPONSIBILITY OF EACH
- 5. EXTRAS SHALL BE AUTHORIZED IN WRITTEN CHANGE ORDERS ONLY BY THE A/E OF RECORD. OWNER TO AUTHORIZE CHANGE ORDERS IF CONTRACT BETWEEN OWNER & CONTRACTOR ALOWS THEM.
- 6. ALL WORK SHALL BE PERFORMED IN A WORKMANLIKE MANNER.
- 5. ALL HOME SPALL DEPERFORMED HAY THORMANDLE AWARD.

 7. EACH CONTRACTOR SHALL INCLUDE LABOR, MATERIALS, TOOLS, EQUIPMENT, ETC., FOR THE COMPLETE CONSTRUCTION OF WORK INDICATED AND SPECIFIED BY THE DRAWINGS AND SPECIFICATIONS.

 8. MATERIALS AS SPECIFIED ON DIRAWINGS SHALL BE USED OR EQUIA APPROVED.

 9. SUBSTITUTION OF MATERIALS SHALL NOT BE ALLOWED WITHOUT THE WRITTEN CONSENT OF THE GENERAL
- 10. EACH SUBCONTRACTOR SHALL AMEND AND MAKE GOOD AT HISHER OWN COST, ANY DEFECT OR OTHER FAULTS IN
- 10. DADIT SUBDUMENTATION OF THE WARREN FOR THE PROPERTY OF THE
- THEIR WORK OR BE BACKCHARGED AT A RATE OF \$45,00 PER HOUR, 12. THE ARCHITECT SHALL NOT HAVE CONTROL OVER OR CHARGE OF AND SHALL NOT BE RESPONSIBLE FOR THE CONSTRUCTION NEARS, BETHOOS, TECHNIQUES, SEQUENCES, OR PROCEDURES, OR FOR SAFETY PRECAUTIONS AND PROGRAMS IN CONNECTION WITH THE WORK, SINCE THESE ARE SCLELY THE CONTRACTOR'S RESPONSIBILITY UNDER THE CONTRACT FOR CONSTRUCTION.
- 13. ALL YYORK AND USE OF MATERIALS SHALL BE IN ACCORDANCE WITH THE APPLICABLE MANUFACTURER'S TRADE ASSOCIATION AND/OR INSTITUTE STANDARDS AND SPECIFICATIONS.
- 14. OWNER WILL REQUIRE THE SUBCONTRACTORS TO OBTAIN AND MAINTAIN COMMERCIAL GENERAL LIABILITY INSURANCE WITH BROAD FROM PROPERTY DAMAGE COVERAGE AND CONTRACTUAL LIABILITY ENDORSEMENT INSURING THE INDEMNITY REQUIRED OF THE CONTRACTOR. THE INDEMNITES ENDORSEMENT INCLUDED ON THE CONTRACTOR'S COMMERCIAL GENERAL LIABILITY POLICY WILL PROVIDE THE FOLLOWING:

 A. THAT THE COVERAGE AFFORDED THE ADDITIONAL INSURED WILL BE THE PRIMARY INSURANCE FOR THE
- ADDITIONAL INSURED WITH RESPECT TO CLAIMS ARISING OUT OF OPERATIONS PERFORMED ON OR ON BEHALF OF
- THE CONTINGEOR.

 B. THAT IF THE ADDITIONAL INSURED HAVE OTHER INSURANCE WHICH IS APPLICABLE TO THE LOSS SUCH OTHER INSURANCE WILL BE ON AN EXCESS OR CONTINGENT BASIS.
- C. THAT THE AMOUNT OF THE COMPANY'S LIABILITY UNDER THE INSURANCE POLICY WILL NOT BE REDUCED BY THE EXISTENCE OF SUCH OTHER INSURANCE.
- D. THAT ADDITIONAL INSURED WILL BE GIVEN NOT LESS. THAN 30 DAYS. PRIOR WRITTEN NOTICE OF ANY CANCELLATION THEREOF.
- E. SUBCONTRACTORS SHALL CARRY THE FOLLOWING MINIMUM INSURANCE COVERAGE:

\$ 1,000,000,00 RODILY INJURY: \$ 1,000,000,00

DIVISION 2 SITE WORK

- 1. REMOVE EXISTING CONSTRUCTION AND PERFORM DEMOLITION WORK AS NECESSARY TO PREPARE THE SITE FOR THE NEW WORK AS FURTHER DESCRIBED IN THE CONTRACT DOCUMENTS.
- 2 REMOVE ALL DEMOLISHED MATERIALS FROM SITE IMMEDIATELY.
- Neinthan exit and access ways in a clean, unostructo, and properly illuminated mainer at all times.
 Protect unappected spaces from dust, noise and damage, maintain site in a closed and
 Secure mainer to prevent theft, vanidalism, and unauthorized entry.

DIVISION 3 CONCRETE

- 1. ALL CONCRETE WORK SHALL BE IN ACCORDANCE WITH THE "AMERICAN CONCRETE INSTITUTE BUILDING CODE" (ACL 318) AND WITH "SPECIFICATIONS FOR STRUCTURAL CONCRETE FOR BUILDINGS" (ACI 301), LATEST EDITION.

 2. ALL NORMAL WEIGHT CONCRETE (145 P.C.F.) SHALL OBTAINA MINIMUM 28 DAY COMPRESSIVE STRENGTH AS FOLLOWS:
- B. FOUNDATION WALLS 3500 PSI
- 3. CALCIUM CHLORIDE AIRDOR ADMIXTURES CONTAINING CALCIUM CHLORIDE SHALL NOT BE USED IN CONCRETE.
- 4. ALL CONCRETE SUBJECT TO EXTERIOR EXPOSURE WITH SPECIFIED STRENGTH LESS THAN 6000 PSI SHALL BE AIR ENTRAINED 4% TO 6%.

 5. COLD WEATHER CONCRETING SHALL BE DONE IN ACCORDANCE WITH ACT-306, HOT WEATHER CONCRETING SHALL BE
- DONE IN ACCORDANCE WITH ACI-305.
 6. BEARING CAPACITY OF SOIL SHALL BE 3000 LB/SF.
- 7. IN CASE OF OVEREXCAVATING FOR FOOTING, ALL EVEREXCAVATION UNDER FOOTING SHALL BE FILLED WITH

DIVISION 4 MASONRY

- 1. CLAY, BRICK, AND CONCRETE MASONRY CONSTRUCTION SHALL CONFORM TO THE 'BUILDING CODE REQUIREMENTS FOR ENGINEERED BRICK MASONRY' ISSUED BY THE BRICK INSTITUTE OF AMERICA AND "SPECIFICATION FOR THE DESIGN AND CONSTRUCTION OF LOAD BEARING CONCRETE MASNRY' ISSUED BY THE NATIONAL CONCRETE MASNRY ASSOCIATION LATEST EDITION
- ASSOCIATION, CALEST EDITION.

 GIVEN DESIGN DATA ASSUMES THE EXISTENCE OF ADEQUATE FIELD SUPERVISION OF CONSTRUCTION, FULFILLING THE WITH INSPECTION CRITERIA OF THE CODES.

 MASONRY MATERIALS SHALL CONFORM TO THE LATEST EDITIONS OF HE FOLLOWING SPECIFICATIONS:
- A. HOLLOW-LOAD BEARING UNITS, ASTM C90, COMPRESSIVE STRENGTH SHALL BE OVER 1,600 PSI ON AVERAGE NET
- B. SOLID-LOAD BEARING UNITS, ASTM C145, COMPRESSIVE STRENGTH SHALL BE OVER 1,551 PSI ON AVERAGE GROSS
- C. MORTAR, ASTM C270, TYPE "M" OR "S", ONLY. FOR REINFORCED MASONRY MORTAR SHALL BE ASTM C476, TYPE "S". D. METAL WIRES USED AS TIES AND ANCHORS SHALL CONFORM TO ASTM AB2, ONLY CORROSION-RESISTANT METALS

- OR METALS WITH SUCH COATING SHALL BE USED.

 E. REINFORCEMENT, WHEN INDICATED SHALL BE ASTM A615, GRADE 50.

 C. CONCRETE MASORINY STRENGTH, THAT AZ DAYAS SHALL BE 1,350 PSI MINIMUM.

 CALCIUM CHLORIDE ANDIOR ADMIXTURES CONTAINING CALCIUM CHLORIDE, SHALL NOT BE INCLUDED IN MORTAR OR
- 6. NO EXTERIOR MASONRY SHALL BE LAID WHEN THE OUTSIDE TEMPERATURE IS LESS THAN 40 DEGREES FARENHEIT UNLESS ADEQUATE PROTECTION, APPROVED BY THE ARCHITECT IS USED.

- . MASONRY WALLS SHALL BE ADEQUATELY BRACED DURING ERECTION
- 8. TYPICAL JOINT REINFORCEMENT SHALL BE #9 GA, CONTINUOUS SIDE WIRES WITH #9 GA, CROSS TIES, SPACING 16" O.C.

DIVISION 5 METALS

- STRUCTURAL STEEL SHALL BE DETAILED, FABRICATED AND ERECTED IN ACCORDANCE WITH THE AISC "SPECIFICATION FOR DESIGN, FABRICATION AND ERECTION OF STRUCTURAL STEEL FOR BUILDINGS" AND THE AISC "CODE OF STANDARD PRACTICE".
- 2. STEEL SHALL CONFORM TO THE FOLLOWING ASTM SPECIFICATIONS (UNLESS OTHERWISE NOTED):

- 2. STEEL SHALL CONFORM TO THE POLLOWING AS IM SPECIFICATIONS (UNLESS OTHERWISE MOTEU):
 STRUCTURAL TUBING:
 A 500 GRADE B
 3. TYPICAL CONNECTIONS FOR STEEL BEAMS SHALL BE STANDARD AISC FRAMED BEAM CONNECTIONS, EXCEPT WHERE SHOWN WELFORD, SHALL BE BOLTED WITH 34" DM. HIGH STRENGTH BOLTS CONFORMING TO ASTM A 325 N, OR GREATER, UNLESS OTHERWISE NOTED. CONNECTIONS SHALL BE DESIGNED FOR 50% OF THE TOTAL ALLOWABLE. UNIFORM LOAD DERIVED FROM THE AISC MANUAL'S TABLE OF "UNIFORM LOAD CONSTANTS" FOR NON-COMPOSITE
- DECAYS.

 A LIL COPED BEAMS TO BE DESIGNED IN ACCORDANCE WITH APPENDIX "B" OF THE AISC MANUAL "ENGINEERING FOR STEEL CONSTRUCTION". PROVIDE REINFORCING AS REQUIRED. ALL RE-ENTRANT CORNERS TO BE SHAPED, NOTCH-FREE, TO A RADIUS OF AT LEAST 1/2".
- 5, ALL WELDING ELECTRODES SHALL BE E-TOXX, ALL SHOP AND FIELD WELDING SHALL BE MADE IN ACCORDANCE WITH A.W.S. D1.1-88 'CODE FOR WELDING IN BUILDING CONSTRUCTION', AND SHALL BE MADE BY QUALIFIED 'CERTIFIED'
- 6. ALL STRUCTURAL STEEL EXPOSED TO THE ELEMENTS SHALL RECEIVE ONE COAT OF APPROVED SHOP PAINT, IN ADDITION TO FIELD PAINT AS SPECIFIED IN THE ARCHITECTURAL SPECIFICATIONS.
- 7. PROVIDE MINIMUM WELD SIZE PER AISC 1.17.2.

DIVISION 6 CARPENTRY

- 1. FLEXURAL FRAMING MEMBERS SHALL BE AS FOLLOWS:
- A. RAFTERS: SPRUCE-PINE-FIR #2
 B. FLOOR JOISTS: SPRUCE-PINE-FIR #2
- C. CEILING JOISTS: SPRUCE-PINE-FIR #2
- C. CHILING JOISTS: SPRUCE-PINE-PINE 2

 LAMINATED VENEER LUMBER ("MICROLLARS) SHALL BE BY TRUSS JOISTS MACHILLAN OR ARCHITECT APPROVED EQUAL MINUMUM STRUCTURAL REQUIREMENTS; Fb-2,500 psi, MODILUS OF ELASTICITY-1,900,000,

 PROVIDE "1-x" OR METAL CROSS BRIDGING NOT OVER 5" ON CEPTIER FOR ALL WOOD JOISTS.

 PROVIDE SOLID BLOCKING OF THE SAME DIMENSION AS THE JOISTS BETWEEN THE JOISTS AT ALL SUPPORTS.

 ALL PLYWOOD SHOWN FOR FLOORROOF DECKS AND AS WALL SHEATING SHALL BE OF THE TUCKNESS SHOWN ON THE

- DRAWINGS AND SHALL MEET ALL THE REQUIREMENTS OF U.S. PRODUCT STANDARD PS 1, LATEST EDITION, FOR STRUCTURAL 1 GRADE MATERIAL
- FOR HEADERS WITH SPANS IN EXCESS OF 6 FEET, MIN. END BEARING AT HEADERS SHALL BE 2-2x4 (JACKS) AND 1-2x4

- FULL HEIGHT (MING) STUD.

 7. PROVIDE DOUBLE JOISTS UNDER ALL BEARINS PARTITIONS.

 8. NOTICHING IS PERMITTED TO 18 JOISTS DEPTH, EXCEPT NOTICHING IS NOT PERMITTED @ MIDDLE 1/3 OF SPAN.

 9. HOLES MAY BE BORED THROUGH FRAMING NOT TO EXCEED 2" IN DIAMETER, OR BE CLOSER THAN 2" TO TOP OR
- BOTTOMOF MEMBER.

 10. WOOD SILL PLATES ON TOP OF FOUNDATION WALLS SHALL BE PRESSURE TREATED, ON A 1/2" FOAM SILL SEALER WITH CEDAR SHIMS @ 16" O.C. (MAXIMUM) AND ANCHORED WITH BOLTS AS SHOWN IN DRAWINGS.

 11. ALL BOTTOM PLATES OF BASEMENT PARTITIONS TO BE PRESSURE TREATED.
- 12. ALL WALL PARTITIONS TO HAVE STUDS @ 16" O.C. MAXIMUM SPACING. DOUBLE TOP PLATES @ ALL EXTERIOR BEARING WALL WITH MINIMEM LAP OF 48"
- 13. BALLOON FRANE WALLS @ VOLUME CEILINGS. `\
 14. ALL SUBFLOORS TO BE 3/4" TONGUE AND GROOVE PLYWOOD SLUED AND SCREWED @ 6" O.C. @ EDGES AND 12" O.C. @
- 15. ALL EXTERIOR DECK FRAMING SHALL BE PRESSURE TREATED.
- 16, ADHERE TO TJI-MACMILLIAN REQUIREMENTS FOR MINIMUM END BEARING @ LYL's.

DIVISION 7 INSULATION

- 1. PROVIDE INSULATION IN ACCORDANCE WITH PLANS AND SPECIFICATIONS AND AS NEEDED TO ACHIEVE THE FOLLOWING VALUES FOR COMPLETED ASSEMBLIES ACCORDING TO 2018 IECC:
- A. FENESTRATION: U-FACTOR = 0.30
- B. SKYLIGHT: U-FACTOR = 0.55
- R-VALUE = 49 R-VALUE = 20 or 13+5 (Cavity + Continuous) R-VALUE = 13/17
- E. MASS WALL:
- F. FLOOR: R-VALUE = 30 G. CRAWI SPACE WALL: R-VALUE = 15/19
- 2. INSTALL INSULATION MATERIALS IN ACCORDANCE TO MANUFACTURER'S RECOMMENDATIONS. FILL CAVITIES 2. INSIGHT INDUCTION AND FEMALS IN ACCORDANCE TO ADMINISTRATION FOR COMPLETELY AND TAPE JOINTS BETWEEN BOARDS.

 3. FILL GAPS BETWEEN JAMASS AND FRAMING WITH NON-FORMAL DEHYDIE FOAM FILLER.

 4. INSULATE DUCTS AND PLUMBING PIPES SUBJECT TO SYFEATING.

DIVISION 8 WINDOWS & DOORS

- INTERIOR DOORS

 1. PROVIDE BLOCKING @ HINGES AND JAMB REINFORCING AS RECOMMENDED BY DOOR FRAME MANUFACTURER.

 2. BIFOLD DOORS SHALL BE IN ALIGNMENT WITH ONE ANOTHER AND PARALLEL. TO THE TRACK WHEN CLOSED, PROVIDE SPACERS AS REQUIRED, BEFOLD DOORS SHALL BE 1.36°, 2 PANEL FOR PART WITH HEAVY-DUTY TRACK, TRACK TO BE CONCEALED BY MA ROUND WOOD TRIM. BIFOLD DOOR JAMBS TO SE TRIMMED OUT WITH 1x POPLAR JAMBS AND DOOR
- CASING AS NOT EXPRESS ON A STATE OF THE ASSOCIATION OF THE ASSOCIATION
- 5. PROVIDE THRESHOLDS FOR EXTERIOR DOOR, NEOPRENE WEATHER STRIPPING, TYPICAL AT HEADS, JAMBS AND SILLS.

- DOOR HARDWARE

 1. PROVIDE HARDWARE COMPATIBLE WITH DOOR THICKNESS, WEIGHT AND MATERIAL.
- ALL DOORS SHALL HAVE 5'8" THROW AT ALL LATCH SETS AND LOCKSETS.
 LATCH BOLTS SHALL HAVE 5'8" THROW AT ALL LATCH SETS AND LOCKSETS.
 EXTERIOR DOOR NARDWARE SHALL BE LEVER TYPE, STANDARD GRADE, CYLINDER LATCH BY BALDWIN (OR OWNER).
- 5. INTERIOR DOOR HARDIYARE SHALL BE LEVER TYPE, RESIDENTIAL GRADE, CYLINDER LATCH BY SCHLAGE (OR EQUAL).

DIVISION 9 FINISHES

- FINISHES GENERAL NOTES

 1. ALL FRISHES SHALL BE CLASS 1,0-25 FLAME SPREAD RATING.

 2. CLEAN AND PREPARE PRIME SURFACES IN COMPLIANCE WITH THE FINISH MATERIAL'S MANUFACTURERS.
- 3. PROVIDE A MINIMUM OF ONE PRIME COAT AND ONE FINISH COAT FOR ALL PAINTED SURFACES.
 4. DO NOT PAINT OVER LABELS, FACTORY FINISH METAL TRIM, DOOR HAROWARE, ELECTRICAL FIXTURES, EQUIPMENT, SPRINKLER HEADS, OR MELYMORK ASSENBLIES.
 5. PROVIDE TOUCHUP PAINTING TO MATCH EXISTING PAINT COLORS AND TEXTURES WHERE NIFILL OR PATCH AND
- REPAIR WORK IS REQUIRED AT EXISTING CONSTRUCTION.
- REPAIR YOURS IS REQUIRED AT EAST BRIS CONSTRUCTION.

 A MLD RYWALL SURPACES SHALL BE PAINTED EXCEPT WHERE CERAMIC TILE IS SPECIFIED.

 PROVIDE CORNER AND JEBADS AT ALL TERMINATIONS AND CORNERS OF GYPSUM BOARD.

 ALL DIMENSIONS TO FACE OF DRIVYALL.
- I. GENERAL CONTROTOR SHALL COORDINATE STAIR CONSTRUCTION WITH FINAL FLOOR FINISH SELECTIONS TO OBTAIN
- 10 PROVIDE CEMENTIFICUS BACKER BOARD AT ALL TILE LOCATIONS AND WET SURFACES. II. PROVIDE THRESHOLDS AS REQUIRED OR AS NOTED AT ALL FLOOR MATERIAL TRANSITIONS, PROVIDE BLOCKING AS REQUIRED BY DRAWINGS, COORDINATE WITH OTHER TRADES FOR SIZE AND LOCATION.

- GYPSUM BOARD

 1. PROVIDE ALL LABOR AND MATERIALS NECESSARY TO COMPLETE THE WORK IN ACCORDANCE WITH ALL CODE AND
- 2. ALL DRYWALL SHAL BE MINIMUM 5/8' THICK UND.
- 3. COMPLY WITH THE RECOMMENDATIONS OF THE GYPSUM CONSTRUCTION HANDBOOK PUBLISHED BY THE USG CORPORATION, EATEST EDITION, FOR METHODS AND INSTALLATION OF METAL FRAMING AND GYPSUM DRYWALL
- 4. PROVIDE METAL CORNER REINFORCEMENT TRIM AT ALL OUTSIDE CORNER CONDITIONS, TRIM SHALL BE
- USG-DUR-A-BED OR EQUAL.

 5. PROVIDE CONTINUOUS BED OF SOUND SEALANT AT TOP AND BOTTOM OF ALL SOUND RATED INSULATED. PARTITIONS AND AT PARTITION PENETRATIONS, INCLUDING ELECTRICAL OPENINGS.
- PARTITIONS AND AT PARTITION PERCENTAGES.

 CORROBATE WITH OTHER TRADES FOR INSTALLATION OF YYOOD BLOCKING.

 PROVIDE GYPSUM BOARD EDGE TRIM, USG-801-A AT EXPOSED EDGES OF ALL NON-FULL HEIGHT GYPSUM DRYWALL
 PARTITIONS EXCEPT WHERE TOP OF WALL HAS GRYWALL FINISH.
- 8, FINISH DRYIYALL JOINTS AND CONCEAL ALL FASTENERS USING USG 'PERF-A-TAPE' SYSTEM OR EQUAL. APPLY FINISHING COMPOUND, SAND AND REPEAT AS NEEDED TO COMPLETELY CONCEAL ALL JOINTS AND FASTENERS.
- PROVIDE ADDITIONAL SUPPORTS, BRACKETS, TIES, AND FRAMING AS RECOMMENDED OR REQUIRED FOR PROPER INSTALLATION AND RIGIO ASSEMBLY.
- INSTALLATION AND RIGID ASSEMBLY.

 10. CLEAN ALL SURFACES AND LEAVE READY FOR PAINT, REMOVE ALL EXCESS MATERIALS AND DEBRIS FROM SITE.

 11. ALL DRYWALL USED ON WALLS IN THE TOILET ROOMS SHALL BE WATER RESISTANT RATED.

 12. DRYWALL SUPPORT SYSTEMS AND FRAMING SHALL BE OF SUFFICIENT CAPACITY AND RIGIDITY TO SUPPORT THE ASSEMBLY WITH A MAXIMUM DEFLEXION OF LIZ40 WHERE 'L' REPRESENTS THE LENGTH OF THE SPAN, DEFLECTION LIMIT INCLUDES LIVE LOADS AND DEAD LOADS SIMULTANEOUSLY IMPOSED.

- 1. PREPARE SUBSTRATES AS REQUIRED TO RECEIVE PAINT, PATCH ALL NAIL HOLES, REPAIR DEFECTS.
 2. PRIME ALL EXPOSED GYPSUM BOARD SURFACES. SPRAYED SURFACES SHALL BE ROLLED OUT WITH A MEDIUM NAP
- 3. INTERIOR MILLYORK TO BE FOR PAINT SHAL BE PRIMED WITH OIL BASED PRIMER, FINISH PAINT SHALL BE TWO COATS HIGH GLOSS ALKYD FNAMEL (SAND BETWEEN COATINGS).
- (1397) GLOSS CALTU DEWICE, ISAND BEHTEEN LOWINGS).


 4. CELLINGS ISOPED 8 FLAT SHALL BE PARITED WITH TWO COATS CELLING FLAT LATEX PAINT-WHITE.

 5. WALLS SHALL BE PARITED WITH TWO COATS EGSHELL ENAMEL.

CERMAIC TILE FOR FLOORS SHALL BE 12'x 12' x 3'8' FLOOR TILE UNLESS OTHERWISE NOTED, ORDER SELECTION SHALL PREVAIL, INSPECT SUBSTRATE PRIOR TO INSTALLATION REPAIR ANY AND ALL DEFECTS, LEVEL NEW CONCRETE SLAB WITH APPROPR

IVALL TILES SHALL BE INSTALLED ONLY ON CEMENTITIOUS BACKER BOARD UNITS (durock) THAT IS LEVEL AND FREE OF

DERRIS WITH APPROPRIATE LATEX THINSET SETTING MATERIAL. REBOOK, MATAPTANCE OF THE FOR GROUT JOINTS LESS THAN 1/8" AND SANDED FOR JOINTS 1/8" AND LARGER. LAYOUT TILE SUCH THAT TILE IS NOT LESS THAN 1/2 THE WIDTH OF THE TILE.

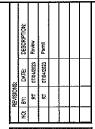

-Unit to Single Family Residence. Interior Rehab -Story Frame Addition including New Partitions, ectrical, Mechanical & Plumbing Systems, New ystem & New Rear Deck & Balcony per Plans. 223 Center Street, Naperville Illinois 60540 Convert 2-1 & New 2-5 New Elec Roof Sys

CATION

IOB NUMBER: 23CS-07042023


OJECT ARCHITEC

R.T. ARCHITECT INC


RADULE TEPAVCEVIC 501 BROWN AVE., SUITE FOREST PARK, IL 50130 TEL: (312) 217-8553 rlspavcevic@aolcom


SHEET No.:

SHEET Name Specifications

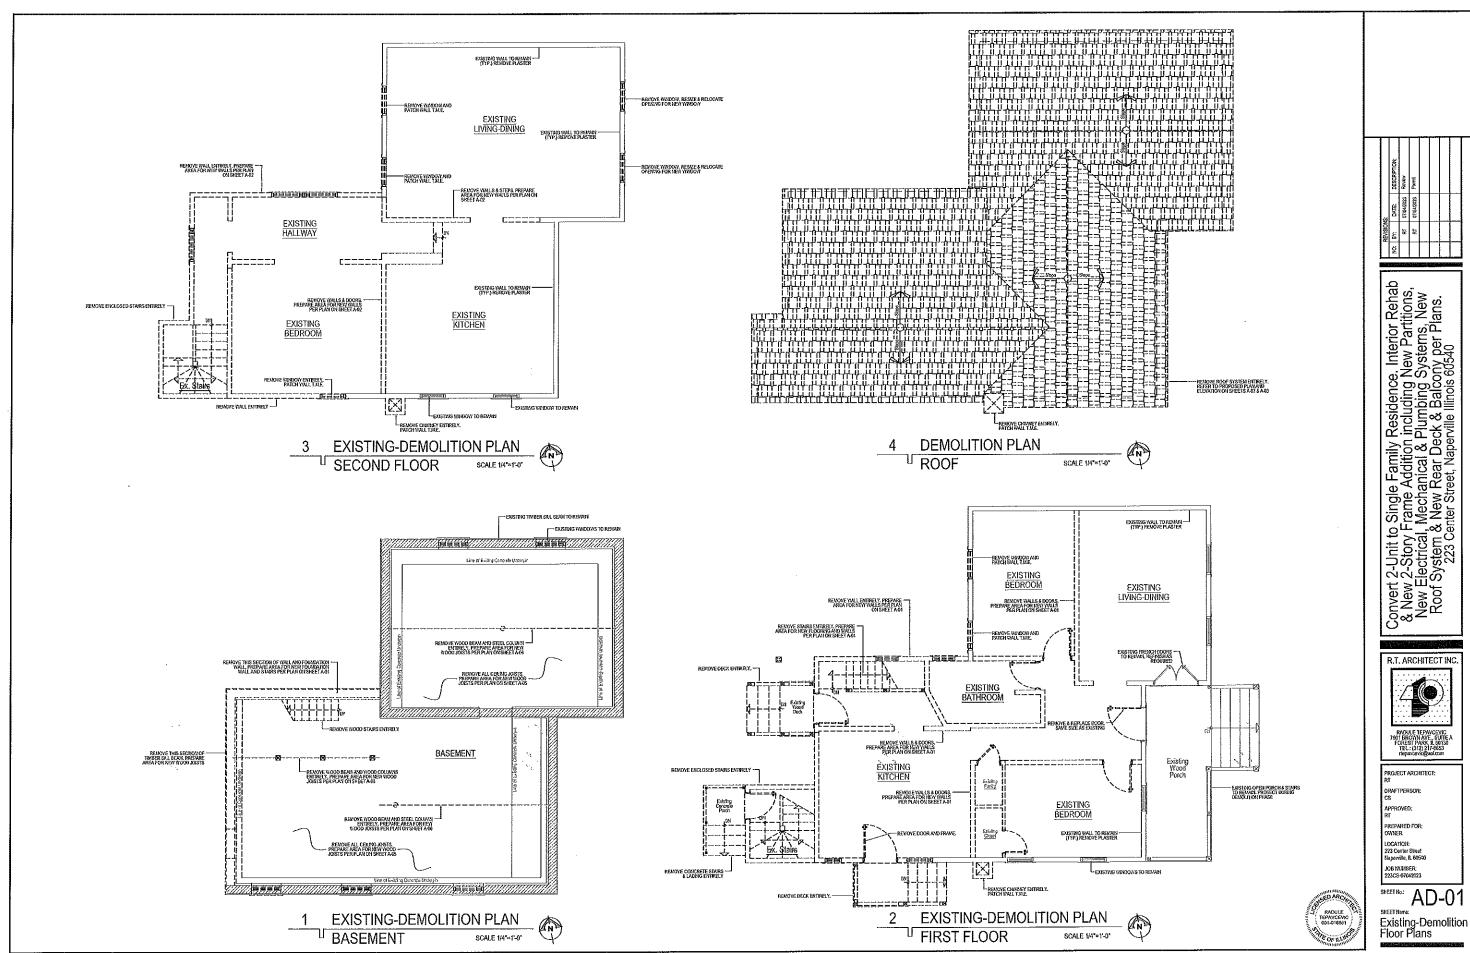

AD-01

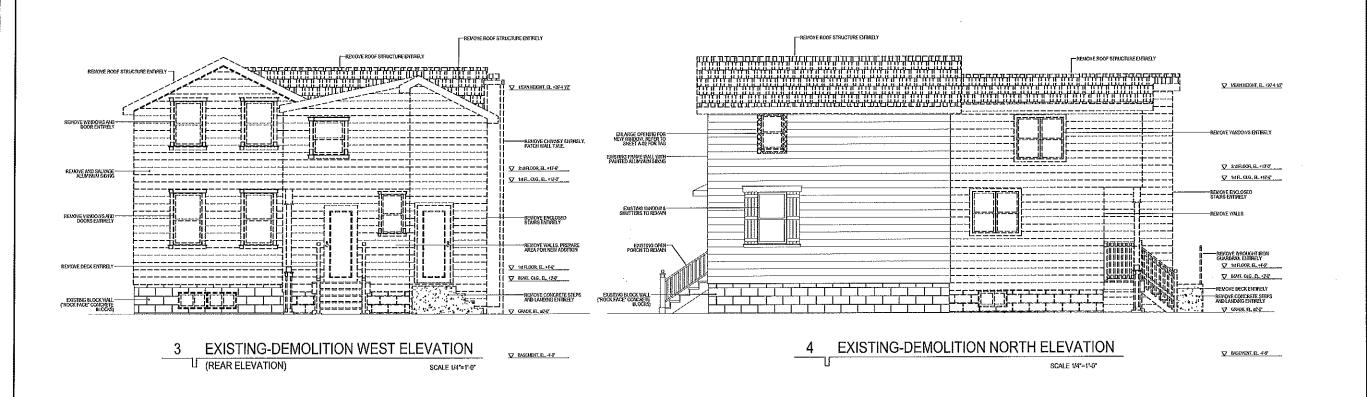

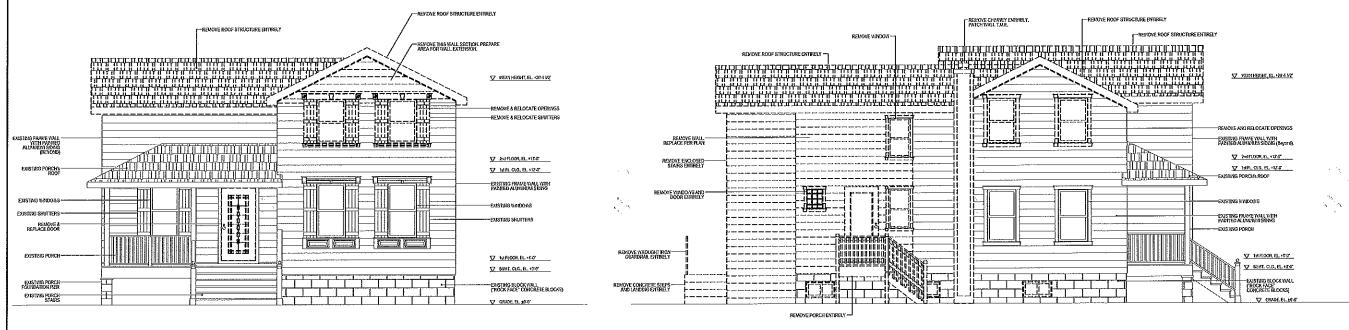

EXISTING-DEMOLITION EAST ELEVATION

(FRONT ELEVATION) SCALE 1/4"=1'-0"

2 EXISTING-DEMOLITION SOUTH ELEVATION




Convert 2-Unit to Single Family Residence. Interior Rehab & New 2-Story Frame Addition including New Partitions, New Electrical, Mechanical & Plumbing Systems, New Roof System & New Rear Deck & Balcony per Plans. 223 Center Street, Naperville Illinois 60540

RADULE TEPAVCEVIC 501 BROWN AVE., SUITE. FOREST PARK, E. 60130 TEL.: (312) 217-8653 rlepavcenic@aoLoom PROJECT ARCHITECT: APPROVED; PREPARED FOR LOCATION: 223 Center Street Haperville, IL 60540

R.T. ARCHITECT INC


JOB NUMBER: 223CS-07042023 SHEET Ho.: AD-02


SHEET Home: Existing-Demolition Elevations

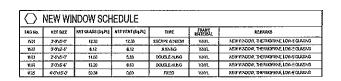


COOM No.	ROOM NAME	FLOOR	BASE		W A	LLS		CERING	CELLAG	REWARKS
қоны жа.	KODA KORE	FLUCK	EASE	н	E	s	η	CERIAP	HEGHT	REMANA
sjt	BASELIENT	12	YLO	DAIST	DWPT	1130	DAPT	GW:PT	8-9	
B02	STOPAGE	NP :	MD	Dn:PT	00∙PT	ONPT	DAPT	DMPT	647	
B33	BEDROOM #3	ΥP	หอ	DANEL	EWPT	19:60	DA'PT	DAVPT	6.4	
8030	NALK-IN-CLOSET	¥Ρ	หอ	DNTT	DAIPT	DOT	ONFT	DISPT	6-77	
BOI	BATHROOM	119	WD	DWPT	CONVERT	OWNE	DAYPE	CAMPT	8-7	CT AT TUS WALLS
B%	LAUNDRY	\P	หอ	DN/PT	OV.P.	DAPT	DAYPT	CWAL	F-F	
Bilda.	UTILITY	۱P	110	SW:PT	ዕሊክ	DAPT	DAPI	thing	6-5	
101	DASV3 ROOM	HVD	เทอ	DAIPT	OV:54	DWAL	DWPT	DOPT	16-2	
105	KUTCHÉN	HAD	พอ		DNPF	DAPI	DNPI	DN:PT	10-01	CT AT AITCHEN BACKSPLASH
1024	PAKTRY	CT	WD.	DARAL	DAPL	DAPT	DATE	DWAFT	10-0	
183	INDROOM:	13	WS	04.21	DWBL	DAPI	1940	DWAL	10'-0"	
194	FAMILY ROCU	HAD	113	DATA	OWN	DAPT	DATE	DWAL	18-0	
166	STARCASE	HAD	WD	DALPT	DW:PT		BAPT	DIAPT	16-0	
105	OFFICE	HAD	סת	DAPT	DAIPT	OVERT	PTTT	DATA	100	
107	POADER RECAT	CT	400	DA-PT	DA:PT	DNPT	DNPT	DAPT	10-0	
201	PALINAY	HAD	n i	D _E PT	DV: LL	THAT	DAPT	DNIPT	10-0*	,
202	GJEST BEDROOM	KUD	Wa	DAIPT	DVAL	DOPT	ONPT	DINPT	10-0	
2023	BATHROOM	CT	¥t0	OWEL	DAIPT	IMPI	DWPT	DAPE	10.5	CLAY FUR TATO
20%	CLOSET	Hat	พอ	DAPT	DAFT	UNPT	DNFT	DWPT	10-37	
203	BEDROOM#t	HAĐ	no.	DAIPT	DINPT	DAPT	DWPT	DIVPT	10-31	
2039	CLOSET	HAD	าาอ	DWPT	DIEPT	DAFFE	DWFF	DIVPT	10-3	
294	BATH-ROOM1	CT	YIĐ.	DWPT	DYuPT	DAPT	DAPT	DNPT	10-0	CTAT SHOMER WALS
205	BEDROOM#2	AVD.	WO	DVAL	CULT	DAYPT	THYO	TRING	10°-0"	
26	MASTER BEDROOM	GUR	ทอ	DAPT	DNAPT	DAPT	DAPT	DAPT	10'0"	
206a	MACK-IN-CLOSET	4VD	Wa	DANPT	DIVE	DAYPT	DWPT	DWPT	10-01	•
250	WASTER BATHROOM	GT	MD :	DALPT	DAPI	DAPT	DAYPT	DIFFL	10-0*	CTAT SHOMER WALLS
207	LEUNDAL	র	ทอ	DAPT	(FA, FT	DAIPT	DATE	GAPT	10-0	
207a	LULITAL BOOK	C£	ma	DAPT	DOLPT	Da PI	DATI	DNPT	10'-0"	
FINESEES	NOTES;		-		ΉТ.	FINESIES A	BBREVIAT	DNS:		

BOOR HEL			DOOR FRAME FIRE HAR											
DOUR NO.	TIPE	SEE	THKK	KATERIAL	FINISH	GLAZING	CORE	TTPÉ	KATEKKI.	HEMEN	RATENS	3£Ţ	REMARKS	
PM	A	\$455	198	ND	PTD:		5C	PH	4D	PID	NR	GROUP#1	STORAGE	
EXI	٨	3.025.5	1-38"	иD	PTO		sc	PH	GN.	PTD	NR	GROUP #1	BETUROON	
B93a	D	54155	1-38	MD	PTD	,	£G	PH	'mD	PTD	NR	GROUP#3	DOUBLE DOOR	
534	A	2-55.5-5"	1-38	WD	PIO	***	5C	FHt	no.	PTD	NR	GROU-#1	BATHROOM	
6X	E	34555	1-3%	MD.	ere	***	SC	PH	úù	PTD :	NR	GPCMP#2	ACRELIC PISERT	
B/Aa	A	2-515-5	1-36	WD	PID		\$C	PH	AΩ	PID	NR	GROUP #2	24"AS" BOTTOM LOW/EN	
131	В	34555	1-36	THD.	PTD .	1EUP	\$C	PII	to :	PRO	NR	GROUPUT	ENTRY	
102	C	3-015-5	133	th D	PTO	TEUP	sc	PH	'AD	[गर	13.6	GROUPS	EXTRY	
197a	A	2-655-5	1-3%	Gar	PTD		EG.	PH	Gñ	PEO	NR	SROUP #2	ADMILIC INSERT	
103	Ċ	3-95-5	1-51	110	PED	16159	86	PH	ńΩ	PTD	NR	GROUP #1	DOWN	
105	F	5-005-5	1-31"	40	PED		sc	PH	6ñ	PTO	NR	G80.32 FI	FRENCH STVLE	
107	A	2-515-5	1-33	4.0	PTO		\$C	Ħ	410	PTO	NR	GROLP#1	POWDER ROOM	
202	A	3-05-5	1-39"	an an	PTO	***	SC	PH	ĢΝ	PTD	NR	GROUP #1	MOORGE	
262b	٨	7-513-5	1-38	4vD	PTEQ.		\$C	PH	W.	ÞΤÐ	ЫR	GROUP#1	BATHROOM	
2025	A	7555	1-33	ทบ	PTO		5C	PH	ano.	धान	NX.	GROUP #2	CLOSET	
203	Α.	3.455.5	1-38	WD	PTD		SC	PH	ND	PTO	NR	G900-741	t*cora±a	
2034	A	2-655-5	1.35	ND.	PTD	***	SC.	PH	no.	PID	NR	GROUP #2	(20 5 E)	
201		2-555-5	1-38"	ทอ	PTD		sc	#H	40	PTD	NR	690UP#1	BATHEROOM	
2(4)	٨	2-555-5	135	U.D.	PTD		SC	PH	ሰው	GF9	NR	GROUP #1	BATHORDON	
205	A	3-65-5	1-3.5"	ñĐ.	PID		50	эн	ΔĐ	PID	NR	GROUP#1	EEDROOM	
216a	٨	7.6%5-8	1:38	ŊΌ	PTD		\$C	fΗ	ηū	Pto	NB	GROUP #2	CLOSET	
209	٨	3.6×2.8.	1.13	WD	PTO		\$C	PH	ňπ	PTD	NR	GROUP #1	MOORGE a	
2(6)	A	3 6 355	1-35	ነስው	PTO		\$C	PH	n)	P10	NR	GROUP #4	POCKET DOOR	
206b	A	3-5%5°5	1-38"	ทย	PTD		sc	PH	'AD	Plo	NR	GROUP #1	BATHSCOV	
207	D	5-0:5-8	131	ทอ	PTD	***	5C	PH	6D	PTD	NR	GEOUP #3	DOUGLE DOOR	
2₹71	Α.	2-515-5	130	เกอ	PTD	***	SG -	PK	60	PTO	NR	GROUP#2	2F2S18OTTOWILGHAE	

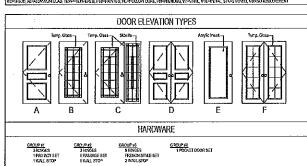

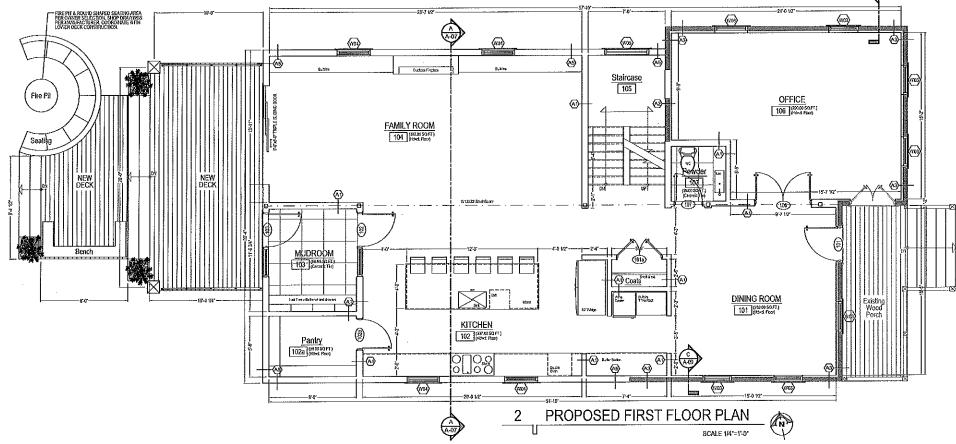

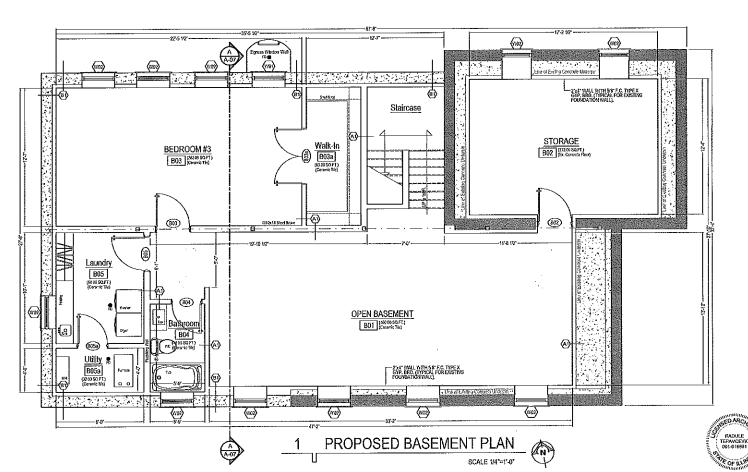

(B)

R.T. ARCHITECT INC.

RADALE TERAVCEYO

7901 BROWN AVE. 50/150

TEL: (1/2) 217-5853

fleyarchings.do.on

TEL: (312) 217-253
rlepartenic@set.com

PROJECT ARCHITECT:
RT

BRATTERSON:
CS


APPROVED:
RT

PREPARED FOR:
OWNER

LOCATION:
223 Center Steet
Napenille, 1, 60540
JOB NUMBER:
223CS-07042023

SHEET No.: A-01

SHEET Name: Proposed Floor Plans

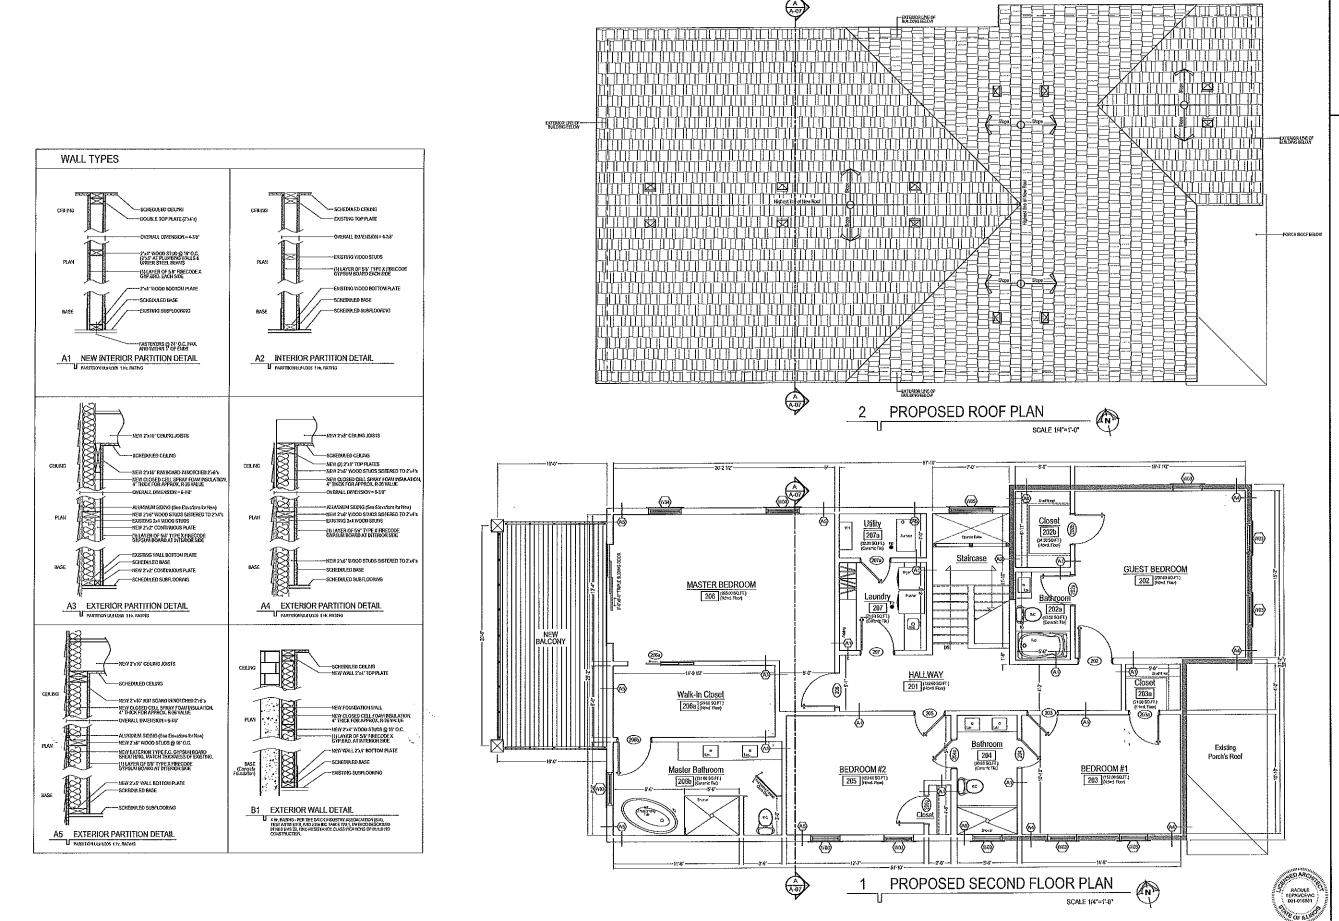


R.T. ARCHITECT INC.

RADALE TEPAVCEVIC
7501 BROWN AVE. SUTIEA
FOREST PIAKY & 50130
TEL. 19(7) 217-5653
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SHEET Ho.: A-02

Proposed Floor Plans

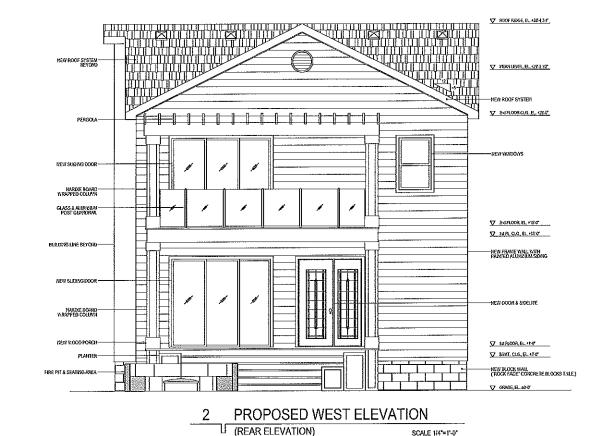

 № 800£ 800€ ET #31.42.1. T JEANLEVEL EL. +29-2 VZ → 2-4 FL00R CLG, EL +25-6 -NEW SHUTTERS ♥ 2-d FL00R,EL+15-0* EXISTING FRAME WALL WITH-PAINTED ALLWANGED (BEYOND) ▼ 14 FL CLG, EL+15-0 EXISTING PORCH'S ROOF, -EXISTING FRAME WALL WITH PAPITED ALUMINUM SIDING EXISTING YUNDOWS NEW DOOR IN-EXISTING OPENING ▼ 1st R.00R, RL+1'6' ▼ B5NT, CLG, EL +3-0" -EXISTING BLOCK YI'ALL ('ROCK FACE' CONCRETE BLOCKS) EXISTING PORCH-FOUNDATION PER (LUCK LYCE, CONCRETE STOCKS)

Output

Description

Output

Description EXISTING PORCH— STAIRS

> PROPOSED EAST ELEVATION ☐ (FRONT ELEVATION)



Convert 2-Unit to Single Family Residence. Interior Rehab & New 2-Story Frame Addition including New Partitions, New Electrical, Mechanical & Plumbing Systems, New Roof System & New Rear Deck & Balcony per Plans. 223 Center Street, Naperville Illinois 60540

R.T. ARCHITECT INC

PROJECT ARCHITECT

DRAFTPERSON: CS

LOCATION: 223 Center Street Napervize, IL 60540

JOB NUMBER: 223CS-07042023

Proposed Elevations


A-03

SHEET No.:

APPROVED: PREPARED FOR: OWNER



A-04

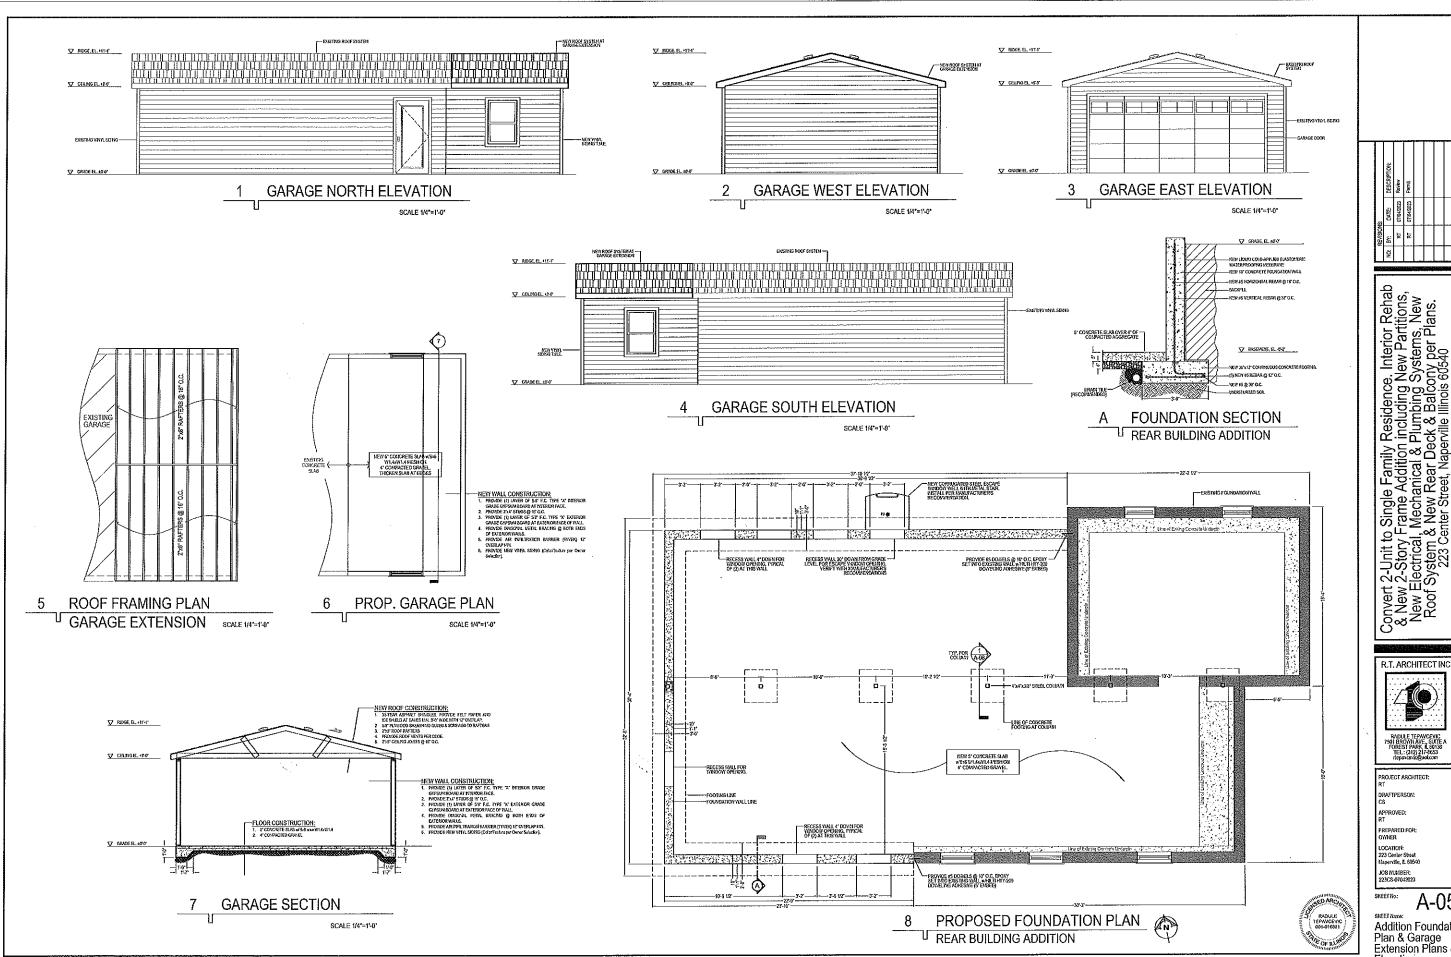



PROJECT ARCHITECT

LOCATION: 223 Center Street Naperville, il. 60540 JOB NUMBER: 223CS-07042023

SKEET No.: A-05

SHEET Name: Addition Foundation Plan & Garage Extension Plans & Elevations

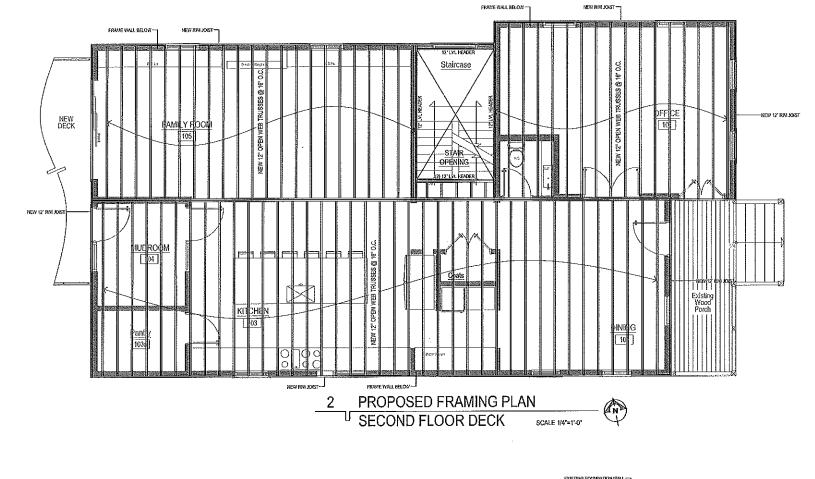

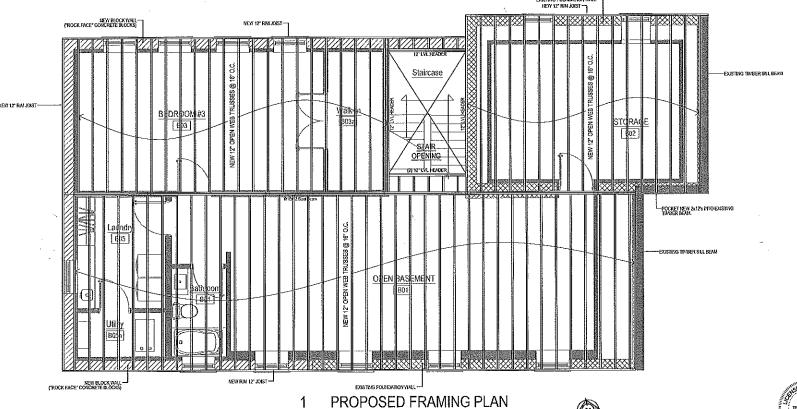

□ FIRST FLOOR DECK

SCALE 1/4"=1'-0"



Convert 2-Unit to Single Family Residence. Interior Rehab & New 2-Story Frame Addition including New Partitions, New Electrical, Mechanical & Plumbing Systems, New Roof System & New Rear Deck & Balcony per Plans. 223 Center Street, Naperville Illinois 60540

R.T. ARCHITECT INC.


RADIAE TEPAVCEVIC
7501 BROWN NYE, GUTEA
FOREST PARK £ 60139
TEL. (21) 217-2553
1(aparcon/sglad.com

PROJECT ARCHITECT: RT DRAFTPERSON: CS APPROVED: RT PREPARED FOR: OWNER

LOCATION: 223 Center Street Hapervite, IL 60540 JOB HUMBER: 223CS-07042023

SHEET 1802 A-06

SREET Harne:
Proposed
Framing Plans

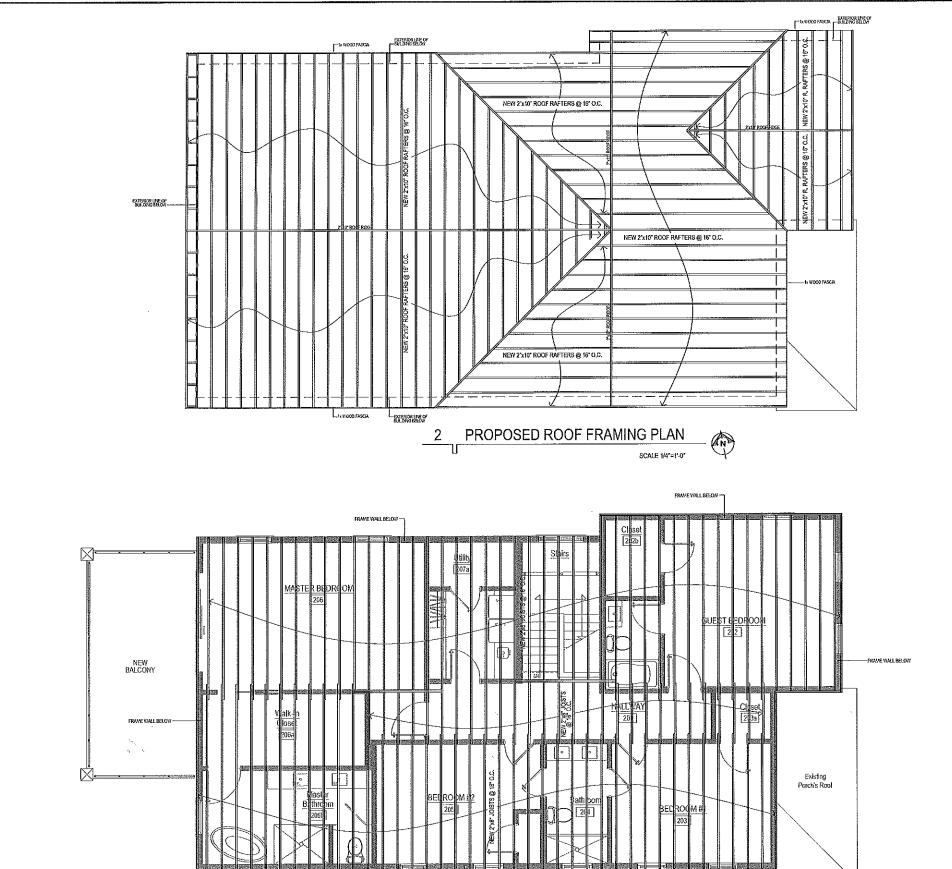

1 PROPOSED FRAMING PLAN

SECOND FLOOR CEILING SCALE 1/4"=1"-0"



Convert 2-Unit to Single Family Residence. Interior Rehab & New 2-Story Frame Addition including New Partitions, New Electrical, Mechanical & Plumbing Systems, New Roof System & New Rear Deck & Balcony per Plans. 223 Center Street, Naperville Illinois 60540

R.T. ARCHITECT INC.

RADULE TEPAVCEVIC 7501 BROWN AVE., SUITE A FOREST PARK, IL 60130 TEL.: (312) 217-8653 depavcevic@aoLoom

PROJECT ARCHITECT:


APPROVED;

LOCATION: 223 Center Street Naperville, IL 60540 JOB NUMBER: 223CS-07042023 SHEET No.:

SKEET Name: Proposed Framing Plans

A-07

RO, BY: DRE DESCHPTON:
RT 07040202 Femil
RT 07040202 Femil

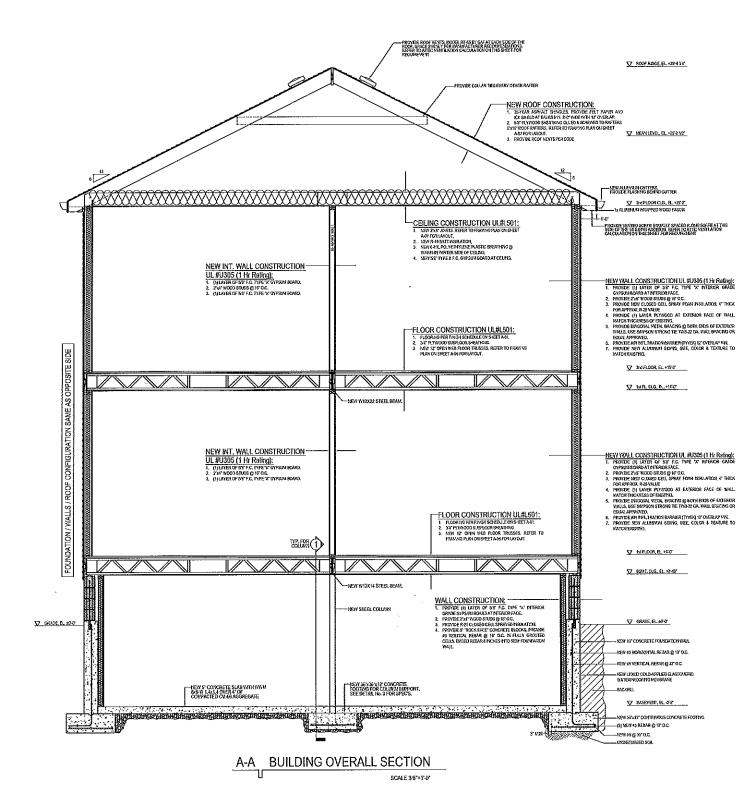



- 1. PROVIDE D'ACCION. METAL BRACRIG Q BOTH EIROS DE EXTERIOR FRAVE WALLS USE
 SINYRONISTRONIS TIET TINEZ GA, WALL BRACRIS GRI ECOM, APRIOCED.

 ALL DIMENSIONS DI PRAVINGS DE DE CHIECRED AGUNT ARCHITECTURAL, PECHANICAL
 AND BECRITICAL D'HANNIGS BY THE GIBERAL CONTRACTION, AND DECREPANCES MAST BE
 REPOCITIET OF THE ARCHITECTENSIVERS OF RECORD METADAMEY.

 GEMERAL CONTRACTOR SHULL INSPECT ALL EXISTING TO BELMARY SIRUCTURAL MEMBERS
 PRIOR TO CONVENEIGEMENT OF AN THEY WORK, DEPENAL CONTRACTOR SINUL INFORM
 THE ARCHITECTENSIVERS HAT OF THE WORK OF HEMPIL CONTRACTOR SINUL INFORM
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 STRUCTURAL SINOPORT MOVINGES TIMEDAMEY, NO THORS STRUCT ED DOSE DIRESS.
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 CONSEQUENCING OF DE DOME ARCHITECTURAL OR TO CONTRACE AND THE
 CONSEQUENCING OF DE DOME ARCHITECTURAL OR TO CONTRACE.

ATTIC VENTILATION CODE REQUIREMENT

REQUIRED ATTIC YEATH ATRON:
According to lift'C, Section 1835.2:
V = Yentilating Area = (1/300)"A
A = Attic Area = 1,738 Square Feet


V = (1/300)*(1,738) = 5.60 Square Feet (835.2 Square Indres)

PROVIDED VEHTILATION:

Using Vest SCREEN'S Series by 'GAF', which comes in 6' king serifaces with a not fine area of 68 square bridges and not fine area of 69 square bridges.


SCREEN'S SQREEN'S SQREEN'S SQREEN'S ARRAY OF A SQREEN'S SQREEN'S GREEN'S SQREEN'S SQREEN'S GREEN'S SQREEN'S SQREEN'

A VAPOR BARRIER HAVING A TRANSVISSION RATE NOT EXCEEDING 1 PERMISIVAL BE INSTALLED ON THE WARM-DEVINGER SIDE OF THE CELLING (6-m) polyem/ene playfo sheating

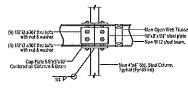

W12 BEAM DETAIL



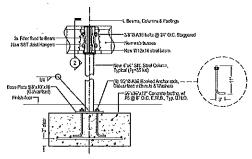

COLUMN-FOOTING DETAIL

RADULE TEPAVCEVIC 001-016581


Convert 2-Unit to Single Family Residence. Interior Rehab & New 2-Story Frame Addition including New Partitions, New Electrical, Mechanical & Plumbing Systems, New Roof System & New Rear Deck & Balcony per Plans. 223 Center Street, Naperville Illinois 60540

R.T. ARCHITECT INC RADULE TEPAVCEVIC 7501 BROYN AVE. SUITE A FOREST PARK, I 60130 TEL: (312) 217-8653 rlepavce-ro@aol.com

PROJECT ARCHITECT

SHEET No.:

Building Section

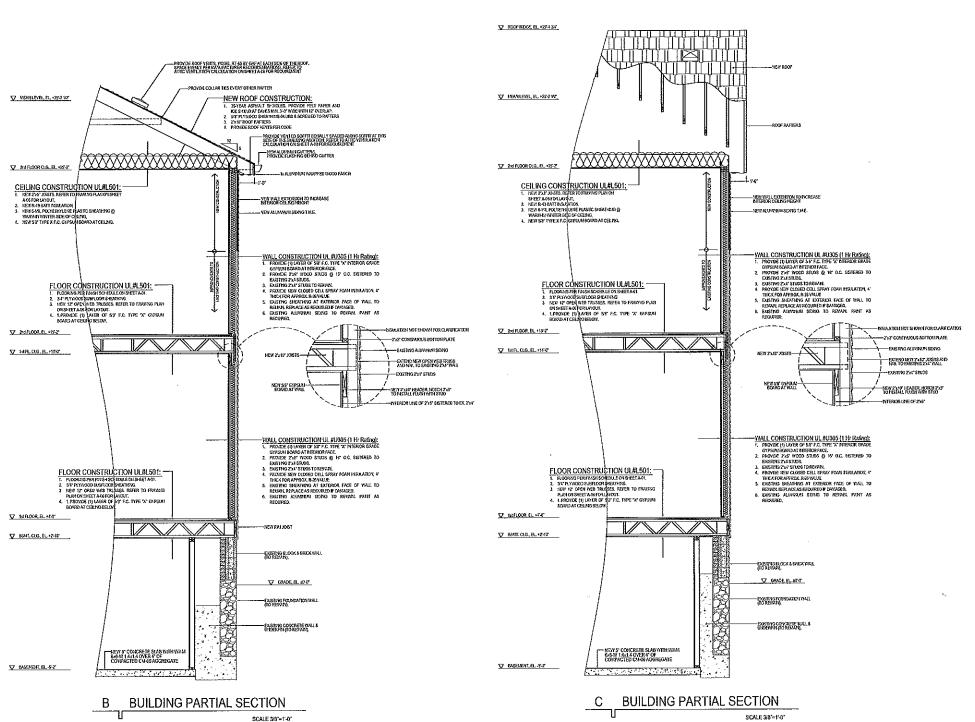



PROJECT ARCHITECT:
RT

DRAFTPERSON:

R.T. ARCHITECT INC.

PROJECT ARCHITECT:
RT
DRAFTPERSON:
GS
APPROVED;
RT
PREPARED FOR:
OWNER
LCCATION:
123 Genice Store!
Naponitie, 8, 60540
JOB NUMBER:
22325-09192023

SHEET No: A-(

SHEET Items:
Building Sections

	NEW SP	READ FO	oting s	CHEDUL	Ę				fc≕	3,500 ps
		FΟ	OTIN	G			PED	ESTAL		
Mark	LONG WAY		MINIMUM	REINFO	RCEMENT		LENGTH	REINFOR	RCEMENT	NOTES
	B	,0,	"t	LONG WAY	SHORT WAY	' Ø'	ı.	HORIZ.	VERTICAL	1
F-1	1'-6"	17-6"	1'-0'	(3)-45	[3] -8 S	10'	36*	43 @ 18" O.C.	(4)-#5	1,2
F-2	2-0*	2'-0"	1'-8"	(3)-45	[3)-#5	14"	36*	#3 @ 18° O.C.	(4)-#5	1,2
F-3	3:-0*	3.0,	1'-0'	(3)-45	(3)-#5	14"	361	#3 @ 18* D.C.	(4)-#5	1, 2

1 PROPOSED FOUNDATION PLAN
U REAR DECK SCALE 141'=1'0'


MARK	TYPE	SIZE	MATERIAL.	BASE CONNECTOR	NOTES
C-1 to C-3	NEV?	B'>:8"	P.T. W000	C89088-SDS2	1, 2
C-4 to C-10	NEW	6'x6'	P.T. W000	C8SQ68-SGS2	1,2

ARCHITECTURAL NOTES
THE ABOVE PLANS SHOW OVEY A PARTIAL PORTION OF THE FRAVE BUILDING, REFER TO PROPOSED PLAN ON SHEETS A.0.
8 A-02 FOR LOCATION OF DECK & BALCONY IN GENERAL VIEW.
2, THRUSTS ON HANDRAILS: HANDRAILS SHALL BE DESIGNED TO RESIST A
SIMULTANEOUS VERTICAL & HORIZONTAL THRUST OF 50 INT. APPLIED AT THE TOP OF THE RAILING OR A CONCENTRATED
LOAD OF 200 WA. IN ANY ORECTION.

PROPOSED FRAMING PLAN


1 REAR BALCONY - SECOND FLOOR SCALE 114*=1*-0*

ADDUITEDTUBAL HOTEO

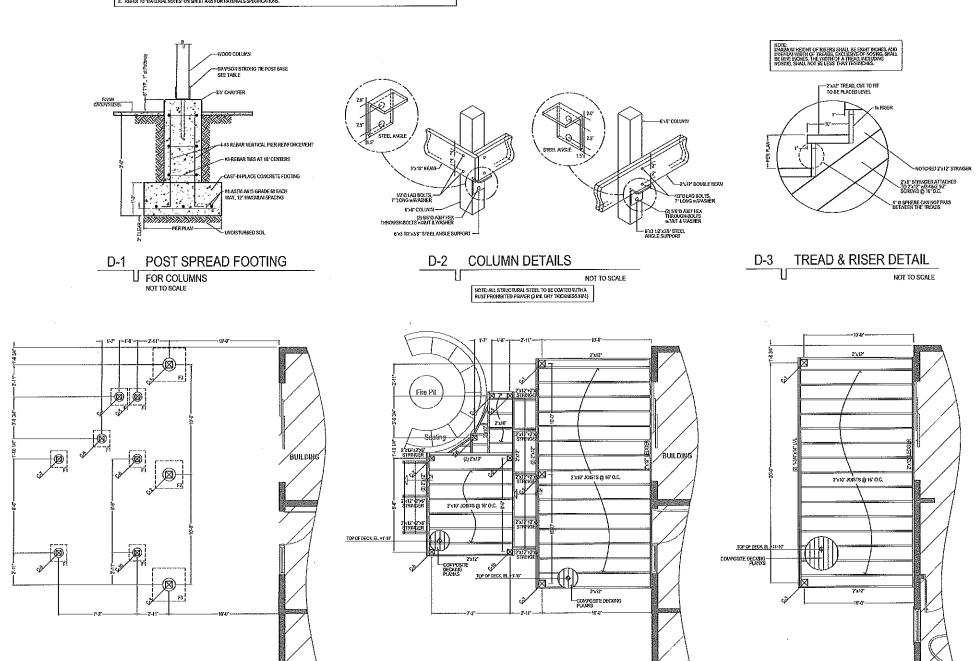

2 PROPOSED FRAMING PLAN

REAR DECK - FIRST FLOOR SCALE 1/4"=1-0"

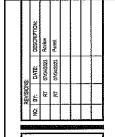

Convert 2-Unit to Single Family Residence. Interior Rehab & New 2-Story Frame Addition including New Partitions, New Electrical, Mechanical & Plumbing Systems, New Roof System & New Rear Deck & Balcony per Plans. 223 Center Street, Naperville Illinois 60540




PROJECT ARCHITECT:
RT
DRAFTPERSON:
CS
APPROVED:
RT
PREPARED FOR:
OWNER
LOCATION:
223 Center Street
Napanitle, 8, 6550
JOB RUMBER:
223CS 37042023

SHEET (8): A-10

Porch & Balcony Plans & Details




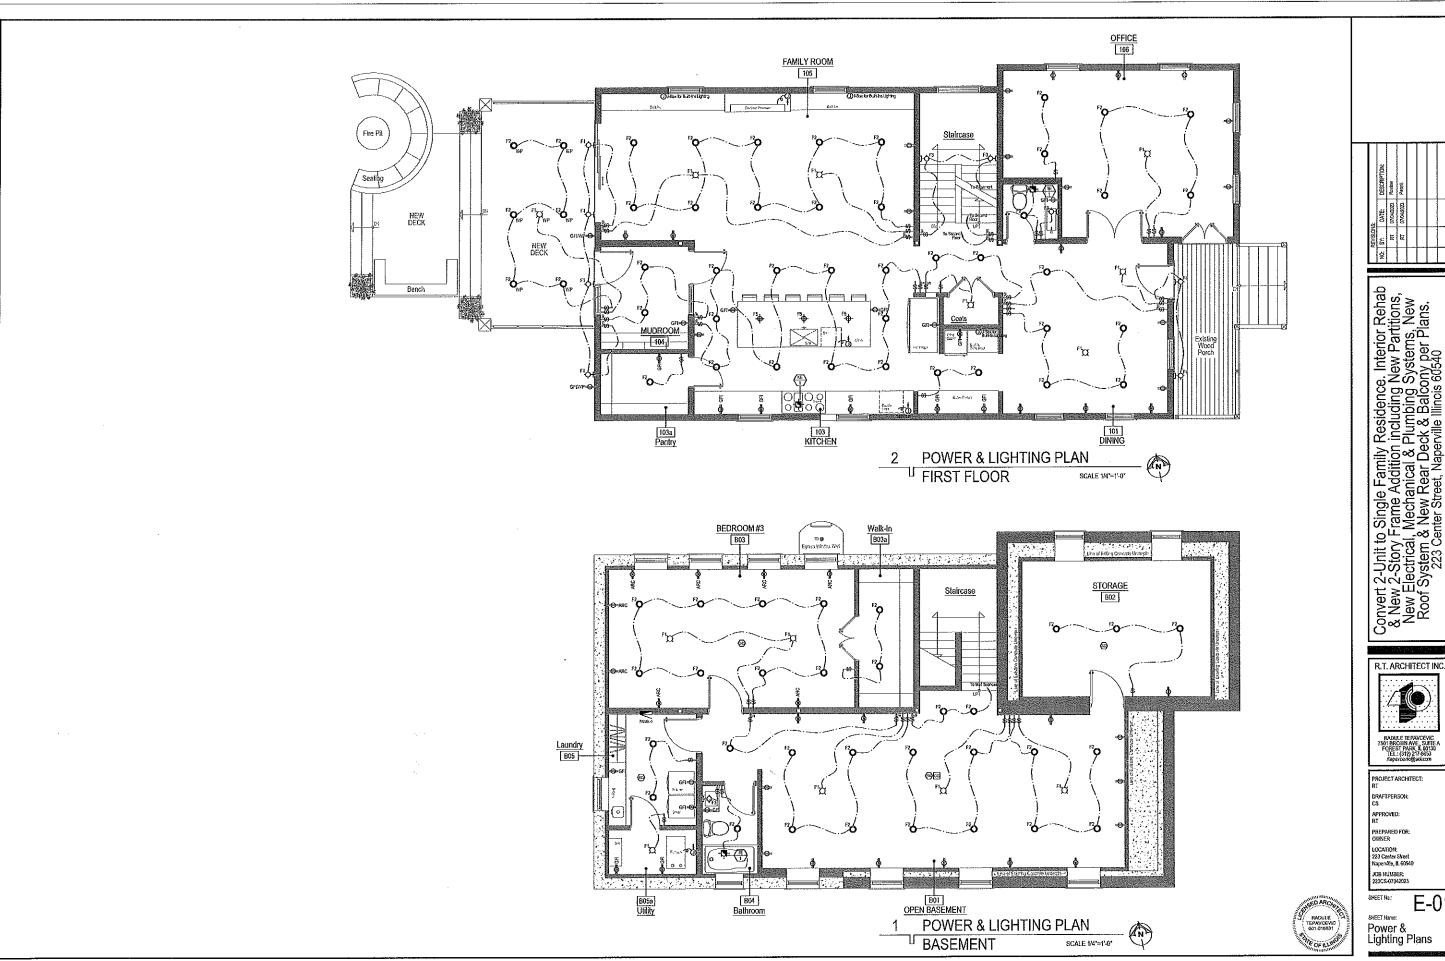

LOCATION: 223 Center Street Naperville, IL 60540

E-01

SHEET Nama: Power & Lighting Plans

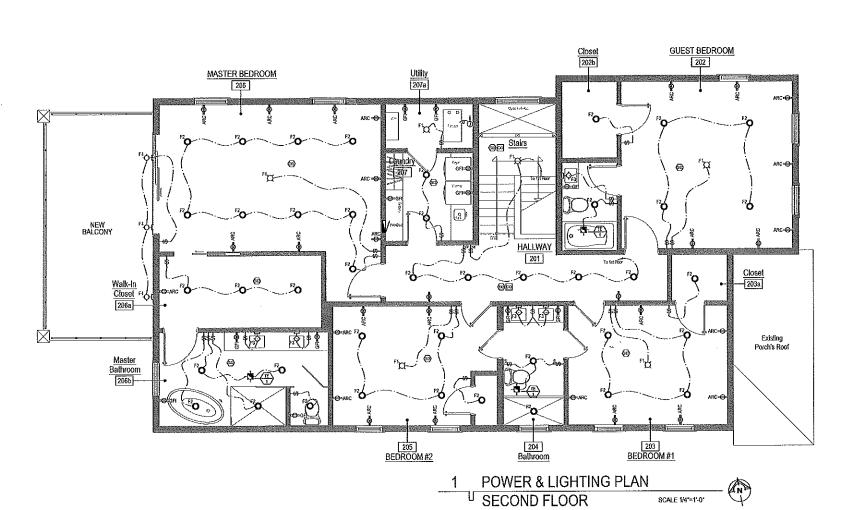



R.T. ARCHITECT INC.

RADIAE TERAVCEVIC 5501 BROWN AVE. SUITE FORCES 100130 TEL-10 TO 25 ACCOUNT 100 FORCES 100

THE CONTROL OF THE CO

SHEET No.: E-02

Power & Lighting Plans

ELECTRICAL NOTES

- 1. ALL ELECTRICAL WORK SHALL BE PERFORMED IN A WORKMANLKE MANNER BY A LICENSED ELECTRICAN IN THE CITY OF INDERNALE ALL ELECTRICAL WORK MUST COMPLY WITH THE CITY OF INDERNALE AND PERFORMED AND APPROVED FOR THE PUPPOSS INTENDED.

 2. ALL MATERIALS SHALL BE ULL UISTED, AND APPROVED FOR THE PUPPOSS INTENDED.

 3. ODSTAIN AND DAY ALL FEES, TAXES, AND PERMITS REQUIRED FOR ELECTRICAL WORK, PREPARE AND SUBSIT TO THE CITY OF INDERVALE BATT AND ALL DATA, DRAWNISS, AND DETAILS YINCH HAV BE REQUIRED FOR APPROVAL PROTO TO INSTILLATION OF SAME.

 4. FIRMISH ALL LADOR, MATERIALS, EQUIPMENT AND RELATED APPARTEDIANCES REQUIRED FOR ALL WORK MICLIED AND PART OF THE ELECTRICAL MISTALLATION FOR THIS PROJECT.

 5. COORDINATE ELECTRICAL WORK WITH ALL OTHER TRADES TO AVOID CONFLICTS AND DELAYS.

- 5. COORDMATE ELECTRICAL WORK WITH ALL OTHER TRADES TO AVOID CONFLICTS AND DELAYS.

 6. FIRMISH AND INSTALL ALL AUXILIARY SUPPORTS AND INTERNAL INCESSARY TO INSTALL EQUIPMENT, INSTEALL, LICHTING FIXTURES, DEPICES, CONDIT AND WISBARD.

 7. ALL SYSTEMS WINCH ARE INCLUDED AS PART OF THE ELECTRICAL INSTALLATION FOR THIS PROJECT SHALL BE COMPLETE IN ALL DETRIALS, INCLUDING ALL COMPONENTS REQUIRED FOR PROPER AND SATISFACTION OPERATIONS WILLIAMS.

 8. ALL WINE SHALL BE INSTALLED IN CONDUIT, MINIMAM SIZE OF CONDUIT SHALL BE 1/2* LD. LARGER SIZES SHALL BE USED WITHER EXPORTED BY ADDITIONED FOR THE INSTALLATIONS ON INTERIORS ONLY.

- 9. ELECTRICAL METALUC TURNIG (EMT) MAY BE USED WITHIN CODE LIMITATIONS ON INTERIORS ONLY.

 10. CONDUITS SHALL BE CONCEALED BY ALL "FRISHED" AREAS, IN "UNFINISHED" AREAS CONDUITS SHALL BE CONCEANED BY ALL "TRISHED" AREAS, CONDUITS MAY BE RUIN EVEROPSED, AS ADMINISTRAL AND INSTALL ALL OUTLET BOXES RAISED COVERS, COVER PLATES, AND SUPPORTS AS ROUTED.

 11. FURRISH AND INSTALL BREAKERS FOR ALL EQUIPMENT, INCLUDING EQUIPMENT FURNISHED BY OWNERA AND OTHERS.

 13. ALL ELECTRICAL OUTLETS NEAR WATER MUST BE GFC!.

 14. ALL CLOSETS SHALL BE:

 14. AL CLOSETS SHALL BE:

 15. NEARLEST DOWN OF STORAGE SPACE.

 16. FLUDRESCHET LIGHTS WITH 6" CLEARANCE BETWEEN FIXTURE AND NEARLEST POWN OF STORAGE SPACE.

 17. LIGHTSCHET HIS WITH 5" CLEARANCE BETWEEN FIXTURE AND NEARLEST POWN OF STORAGE SPACE.

 18. INCADISSCHET LIGHTS WITH 12" CLEARANCE BETWEEN FIXTURE AND NEARLEST POWN OF STORAGE SPACE.

 18. INCADISSCHET LIGHTS WITH 12" CLEARANCE BETWEEN FIXTURE AND NEARLEST POWN OF STORAGE SPACE.

NEW SINGLE POLE LIGHT SWITCH ℓ Of above finish floor (TVP.)

(SO) NEW CEILING MOUNTED HARDWIRED SY/OKE DETECTOR WEATTER' BACK UP

NEW 120V. 10. WALL-MOUNTED DUPLEX GROUND OUTLET 19" ABOVE FLOOR (TYP.)

NEW 120V, 10/Y/ALL-MOUNTED DUPLEX GROUND FAULTED INTERRUPTOR OUTLET

MEW 120V. 1/3 WARL ANOUNTED DRIPLEX ARC-FAULTED INTERRUPTOR DEFLET

ELECTRICAL SYMBOL LIST

F2 O

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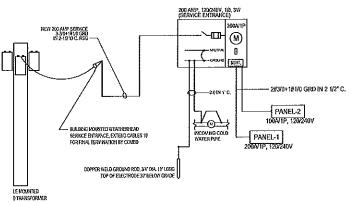
F5 🕁

NEW RECESSED CAN LIGHT

INEW ELECTRICAL PANEL

NEW ELECTRICAL METER

COPPER KIELD GROUND ROD, 34" DVA. 11" LONG TOP OF ELECTRODE 37" BELOW GRADE ELECTRICAL SINGLE LINE DIAGRAM



	PANEL80	ADD SCL	IEO(II)	DAME	-9	
	FANELO		IL.OUL.	-, FF33L		
PAVEL WITE.	WALL PRENTED	YOUTAGE	120243	¥	PANEL DIMENS	2013
MANIFLEE	13) AND EREASE ?	LOCATION	SECCAL	F.003	HEIGHT	ASF
MANS		FFASE	10 (34)	,	MEGEN	
tuss		FEEDER STE	040a	INE DAGAM	DEPTH	
No DECCTS	20	SECTION	Vetre		COVATIOND	23.43
GREAR	YES	DESCREDIO				
		the acceptor.	2000	"		_
150. GR.	М	L				Ļ
CCT CCT		WATTS	HATES			CCI
	GENLUS-MNG/2/4FL)	1313	יוווווו	G29 11/2	(TRIS (2rd FL)	
	GEN DE ATTNO (2 of FL)	1111111	1543	G-71LUG	THE (2-d FL)	75
	GEN LIGHTING (ZALIFLI	1943	7/////		(Fitted Control	(15
	RECEPTACLE (2-67L)	VIIIIX	21(4)		TACLE (2:4FL)	
9 80	RECEPTACLE (2-1/11)	2100			(ACLE (2×4FL)	120
	RECEPTACLE (2-0 FL.)	VIIII	2100		TACLE (Zelfl)	23
13 20	RECEPTACLE (2-3 FL)	2100	11111		FACLE (2-d FL.)	20
15 20	2nd FL ECOFSETIT		5503		ACUST	₹ 60,

CALCULATION	ON FOR
ELECTRICAL	SERVICE

1,272 Sq.Fl. x 3 (W per Sq.Fl.) 3,816 W 1st Floor 1,543 Sq.Fl. x 3 (W per Sq.Fl.) 4,629 W 2nd Floor 1,510 Sq.Fl. x 3 (W per Sq.Fl.) 4,530 W

Basement 1,272 Sq.Ft. x 4 (W per Sq.Ft.) = 5,088 W 1st Floor 1,543 Sq.Ft. x 4 (W per Sq.Ft.) = 6,172 W 2nd Floor 1,510 Sq.Ft. x 4 (W per Sq.Ft.) = 6,040 W

MOTOR LOAD @ 100%=....

*FROM MECHANICAL AND ELECTRICAL SYSTEMS (MBUNLDAYGS BY RICHARD R. LEWIS AND ALD. TASKE 13-3 PG. 419

	120241	ν (MARK COVENS	ays.		1 I	PAY	न भार		WALL PURINTED	YOUTAGE	Т	1202431	,
╛	BASSIE	NT	HEIGHT	ASE	EVD.	1 I	NY.	FLSE		133 ASSP EREASER	LOCATION	7	ECCAD I	F.003
1	12 (30)		MOIR	\vdash		1 1	NA.	s			PEASE.	1	10 (34)	
Н		LE EDIAGRAD	OCENTAL TOTAL	\vdash		1 1	tus	e			FEEDER SEE	-13	-0.40	NE DAGAM
-						1 1		_	_			_	PETER	
_	VETER		CONLIGAD	38 95	O7			FCCT	δ.	20	SERVEDITIO	-		
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			(PAZS) DATES	15	7	1 1	7	15		ELLÚS-MNG(2MFL)	1313		777	GFILLIS
	2112		HT::G(8519T)	15	4) [3	15		ELUSATING (ZAJELI	1111111		43	G⊋Ł1ii
_			HULY (ALT)	15	6	} [5	15		N DG-TING (ZAJEL)	1943	1//	///	GENTR
_	2112		ZITNG(SUFL)	15	ß) !	7	ĸ		CEPTACLE (2-47L)	11/11/	1 21	(0)	RECE
			3([#13(]#FL)	15	10	} !	9	e		CEPTACUE (2:1/H.)	2100	(11)	411	RECE
	2450		TACLE (BSAIT.)	20	12	} (- 55	я		CEPTACLE (2-d FL.)	VIIII	1 2	(0)	RECE/
_			TACLE (BUSINE)	52	11) (13	20		COPTACLE [2:37L)	2100	///	111	RECE
_	2:00	RECE	TACLE (191FL)	20	14.) (15	20		HFL ECOFSEIN	4/////	1.3	(0)	
_			TABLE (191FL)	23	11	4. 1	17	53/	п	RVACE	3500	111	///	
	2430		TATIE (141FL)	2	2)	1 1	19	\sim	_		MILLEL		\$	
			DEKARDI ŞI	2)	22	1 1				TOTAL WATTS/ PHASE	11,566	į 11,	213	
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	77.0	-		/	30	1 1				DEVEASO FACT				
	19,934			٠.		1 1	68	:P.C	_	SPARE LOAD FAC	ris Lars	_		
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PROJECT ARCHITECT

R.T. ARCHITECT INC.


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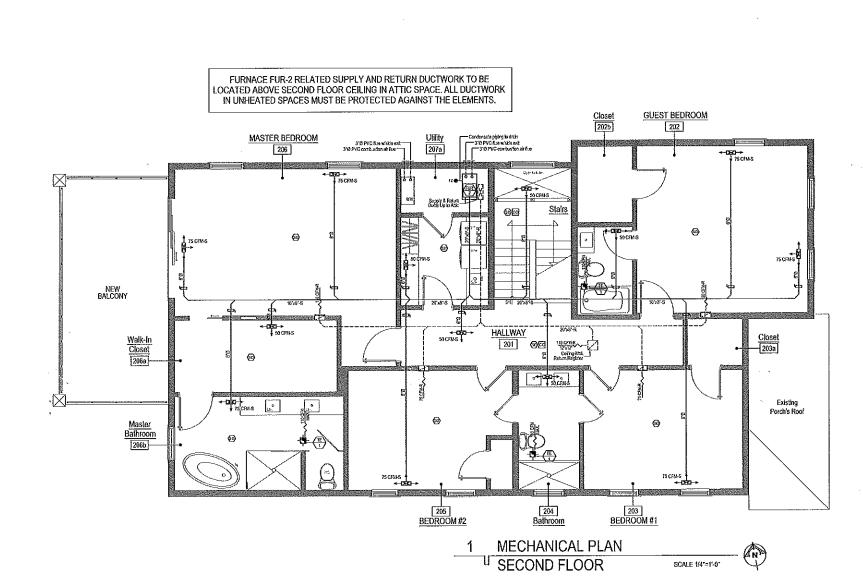
SHEET No.:

Riser Diagram, Load Calc's & Schedules & Panelboards



PANELBOARD SCHEDULE, PANEL-1



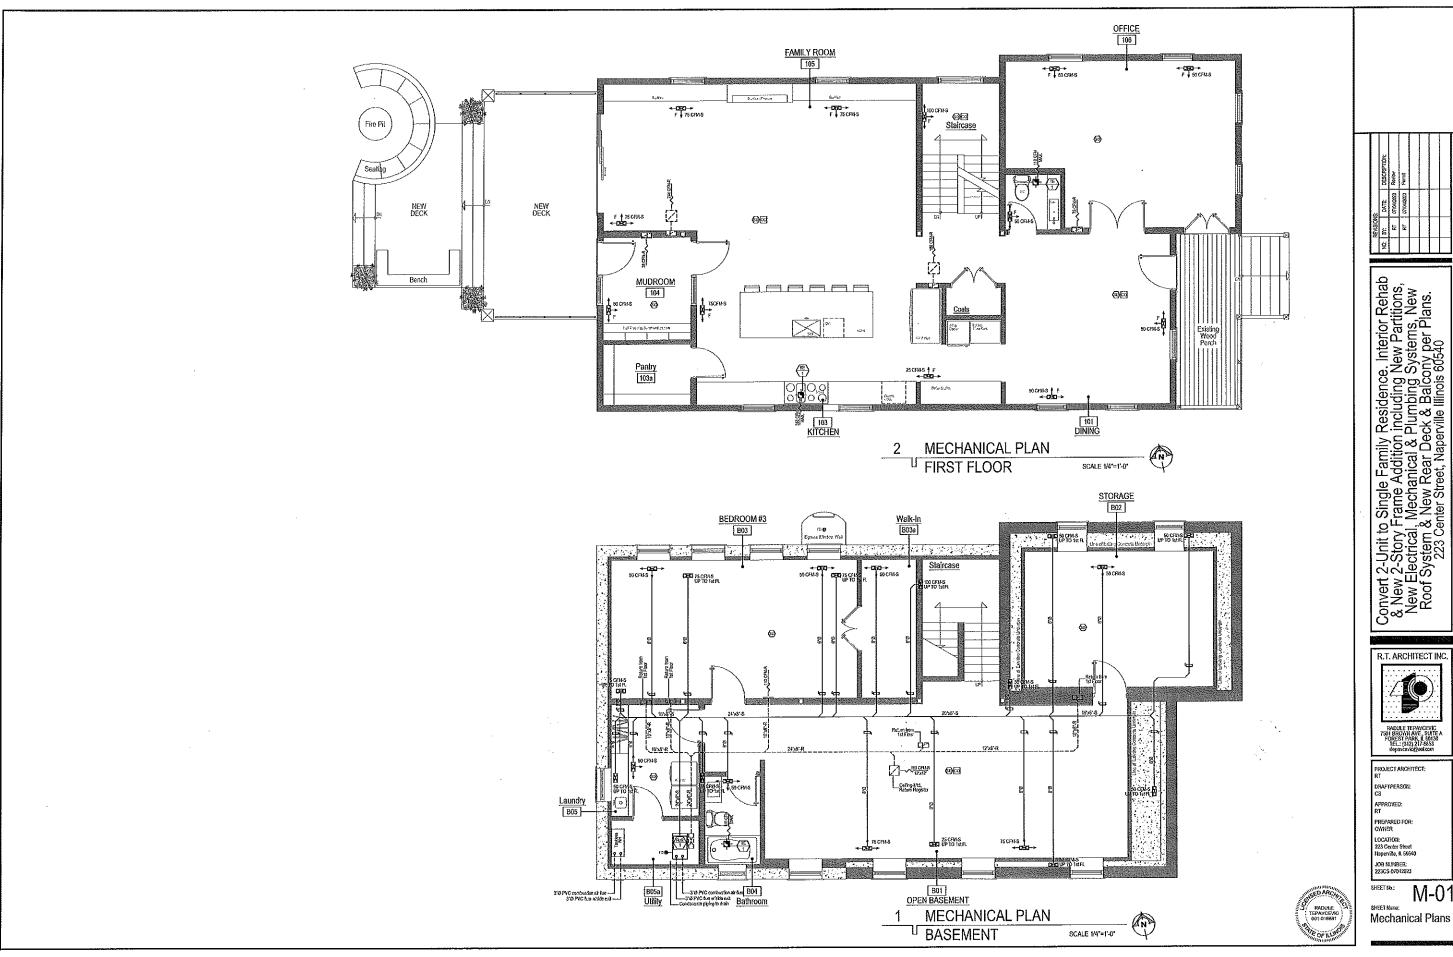



RADIJLE TEPANCENI
799 BROWN AVE, SUT
FOLL CITY OF THE CITY OF T

R.T. ARCHITECT INC.

SHEET No.: M-O

SHEET Name:
Mechanical Plans

	MECHANICAL EQUIPMENT SCHEDULE																	
	UNIT DATA HEATING DATA CONNECTIONS BLOWER PERFORMANCE																	
TAG	SERVICE	MARUF.	MODEL #	EFF.	TONS	TINUL	HEAT SOURCE	AIGIA	AR FLOY (CFM)	HEATING IMPUT HIGH (Kw)	HEATING OUTPUT HIGH (Kw)	TEMP, RISE RANGE HIGH (FF)	FLUE	GAS PIPE SIZE (in)	AIR YOLUKE (CFM)	TONS ADO-ON COOLING	FAN DIA. {lo}	MOTOR HP
FUR-1	85NT & 1ST	GCODAVAN	GN9595-1205DN	96%	1.53	156 LB.	NAT. GAS	120-1160	750-1954	120,050	115,320	35-65	3° PYC	1/2	750-1951	3-5	11x11	1
FUR-2	SECONO FL	GCCOCHIAN	GA/9596-06438N	96%	1.5-3	f18 LB.	NAT, GAS	120.150	512-1060	60,000	57,660	35-65	3" PVC	1/2	512-1050	1.5-3	168	1/2

1. ALL FURNICES TO BE PROTUDED WITH PLEIDAM MOUNTED HAPDOFFER APPLIAR VOL. #550, VITH ALL DECESSARY WATER A DRAWL PRIVE DETECTION THEATING OFFICE.

2. ALL PARVICE UNITS TO BE PROVIDED WITH PROOM THE PROMISTAT AND SUBMISE WITH ALL CONTROL WEING.

3. ALL EXPANSIT FAIS TO BE PROVIDED WITH HITEGRATED DAVPER.

			REF		RATI	ON S	CHE	ULE			
TAG	SERVICE	COMP.	CORP.HP	REFRIG.	WT. REFRIG.	REMOTE	SELF CONT.	LOCATION	ALR COOLED	YATER COOLED	SPECIAL
CU-1	BSMT, & IST PL	3.5	3.5	R-410A	1218	0		GROUND	⊗		
CU-2	2/10 FL	2.0	2.0	R-410A	1218	8		GROUND	⊗		

			EX	HAUST	FAN	SCI	HED	ULE				
				l	T	Γ	PERI	OFWANCE		ELI	ECTRICAL D	ATA
TAG	SYSTEM	LOCATION	PANUFAC.	MODEL #	TYPE	CFM	SONES	DUCT SIZE (In)	DISCHARGE DIRECTION	HP OF YYATTS	VIOIR	AMPS
TEA	SATH EXPAUST	CELENG	BROAVE	LoSone#160	RECESSED	110	0.90	3	SIDE	67 Y	120/1/60	1.1
KE-1	RANGEHOOD	KITCHEN	Per Ovcer			350 max.	0.3-3.0	4 'B'	UP .		120/1/50	

	MECHANICAL SYMBOL LIST
SYMBOL	DESCRIPTION .
+ #	NEW 10'16' CLG-ATID, SUPPLY DIFFUSER WITH ADJUSTABLE LOWERED SCREEN
+050+	NEW 1036' FLOOR-WID. SUPPLY DIFFUSER WITH ADJUSTABLE LOUVERED SCREEN
	NEW CEADIG-ATO, RETURN GRALL, SIZE AS SPECIFIED
"]ና"	NEW WALL-SITD, RETURN GRAL, SIZE AS SPECIFIED
X	NEW FERNACE, REFER TO EQUIP, SCHEDULE FOR SPECS.
®	NEW CELLING MOUNTED HARDWIRED SMOKE DETECTOR WIRATTERY BACK UP
60	NEW CELLING-AITD HARDVIEWED CARBON MONOXIDE DETECTOR WIBATTERY BACK UP
4	NEW EXHAUST FAN
arc _	NEW SUPPLY DUCT, SIZE AS SPECIFIED, REFER TO SIKE TIMETAL NOTES
_2 <u>724</u> .	NEW RETURN DUCT, SIZE AS SPECIFIED, REFER TO SHEET METAL NOTES
□	NEW YOUR DAMPER
	NEW SUPPLY DIFFUSER WITH VOLUME CAMPER

						LIG	HT AND	VENTIL	ATION S	CHEDUI	LE						
FLOOR	ROOM/NUMBER	AREA (SQ.	KANIGRO .Q2)		ACT (SQ	UAL .FT.)		ICE REQ'D FM)		VAL FM)	SUPPLY	EXHAUST	METHOD OF	ACTUAL HEAT LOSS	CFM TO HEAT	CFM	HEAT PROVIDED
FLUVA	ROUMINUMBER	FT.)	NAT. LIGHT	NAT. VENT	HAT. LIGHT	NAT. VENT	SUPPLY	EXHÁUST	SUPPLY	EXHAUST	EQUIP.	EQUIP.	CALCULATION	(BTUHR)	-10°F TO 70°F	SUPPLY	BTU's
	BASEMENT - 801	450.00	N/R	9.20	24.45	2448	147	110	150	113	FUR-1	FUR-1	ASHRAE	18,400.00	110	150	120,000
	STORAGE - B-02	212.00	N/R	K/R	12.24	12.24	50	39	50	0	FUR-1	INA		8,480.00	36	50	
	BEDROOM #3 - B53	282.00	22.56	11.28	30.69	30.69	95	68	150	75	FUR-1	FUR-1		11,280.00	68	100	L
	WALK-IN CLOSET - BO34	63,00	NR	K/R	0.00	000	56	38	50	36	FUR-1	FUR-1		2,520.00	35	50	
FIRST	BATHROOM - 824	40.00	NR	NR	6,12	6.12	50	100	50	38/110	FUR-1	FUR ME	ĺ	1,600.00	100	50	II
-	LAUNDRY - 805	80,03	NR	K/R	6,12	612	58	38	50	38	FUR-1	FUR-1		3,200.00	38	50	l
Ę	DIKING ROOM - (0)	232.00	18.56	9.28	34.98	17.49	74	56	100	75	FUR-1	FUR-1		9,280,00	56	100	
BASEMENT	KITCHEN - 102	307.00	24.56	1221	26.40	1320	98	195	100	75/350	FUR-1	FUR-TAKE-1		12,280.00	196	100	
18	MUDROOM - 103	66,00	NR	K/R	22.00	2400	50	38	50	36	FUR-	FUR-1		2,540.00	38	59	I
26	FAMILY ROOM - 104	182.00	30.56	15.28	90.40	55.86	122	92	225	169	FURIS	FUR-1		15,280.00	92	225	II
	STAIRCASE - 105	82.00	N/R	KR	50.34	. 0.00	56	38	100	75	FUR-1	FUR-I		3,280,00	38	t00	
	OFFICE - 106	290.00	23.20	11.60	46,64	23.32	93	70	100	75	FUR-1	FUR-1		11,600,00	70	100	
	POWDER ROOM - 107	25,00	N/R	K-R	0.00	000	50	100	50	38/110	FUR-\$	FUR-1/TE-1	1	1,000.00	100	50	♦
l	TOTAL SYSTEM	2,521.00	£19.44	68,92	350,41	213.52	974.96	979.02	1,175.00	847.00			ASHRAE	100,840.00	979	1,175	120,000
	HALLWAY - 201	12200	N/R	N/R	0.00	0.00	54	44	100	75	FUR-2	FUR-2	ASHRAE	4,880.00	- 4	100	60,020
	GUEST BEOROOM - 202	237.00	15.96	5,48	34.95	17.49	114	B5	150	113	FUR-2	FUR-2	1	9,480.00	85	150	1
	BATHROOM - 2024	40.00	NA	8.8	0.06	0.00	50	38	- 50	38/110	FUR-2	FUR-2/TE-1		1,600.00	38	50	
_	REBROOM #1 - 203	157.50	12.56	€ 28	23.32	11.66	75	57	75	57	FUR-2	FUR-2		6,280.00	57	75	1.
SECOND	BATEROOM - 204	60.00	NR	NH	11.66	5.63	50	38	50	38/110	FUR-2	FUR 2TE 1		2,400.00	38	50	
i ig	BEDROOM #2 - 205	150.00	12.00	6.00	23.32	11.66	72	54	75	54	FUR-2	FUR-2	i	6,000.00	54	75	
দ	MASTER BEDROOM - 206	295,00	23.60	11.80	90.40	55.86	142	154	150	£13	FUR-2	FUR-2		\$1,800,00	105	150	
	WALK-IN-CLOSET - 206 a	96.00	NA	ХR	0.00	000	50	38	50	38	FUR-3	FUR 2		3,810,00	38	50	
	MASTER BATHROOM - 2066	131.00	N/R	NA	11.66	5.63	63	47	75	57/110	FUR-2	FUR-2/TE-1	1 1	5,240.00	47	75	
	LAUNDRY - 207	71.00	N/R	HVR	6,00	000	.SJ	38	50	38	FUR-2	FUR-2	Ŷ	2,840.00	38	50	7
	YOTAL SYSTEM	1,359.00	67.12	\$3.56	195.34	108.33	724	543	825	621,00			ASHRAE	\$4,360.00	543	825	60,000

MECHANICAL GENERAL NOTES

- 1. ALLIEW MECHANICAL WORK SIMIL CONST. WITH STATE AND VALIGE BURDING CODES, LATTEST EXPROPAL AND SIMIL BELLET IN PROFESSIO OPERATION COMMISSION.

 1. PROVINE OR SESSION WITH INSULTOR PARKET ON ALL GAS FERD EDUCATION.

 2. PROVINE OLD SESSION WITH SHOT OF PARKET OLD ALL GAS FERD EDUCATION. ALL GAS PRIVADE SHOULD EXPLAIN A ALL DICTIONS CONTINUED AND ALL DICTIONS CONTINUED AS ALL DICTIONS CONTINUED AS ALL DICTIONS CONTINUED AS ALL DICTIONS CONTINUED AS ALL CONTINUED AS ALL CONCORDING THE MORK WITH GENERAL CONTINUED.

 3. THE CONTINUED IS OLAVIOR DIVIDED FROM CONTINUED AND ALL OTHER TRANSES IS AND AN EXPLICATE MORK WITH GENERAL CONTINUED.

 4. ALL COMMISSION SHALL SO SIMIL SENSION FRACTOR.

 5. ALL COMMISSION SHALL SHE BY THIS CONTINUED.

 5. ALL COMMISSION FROM SHALL BE BY THIS CONTINUED.

 6. ALL CONTINUED AND ALL SENSION FRACTOR.

 6. ALL CONTINUED AND ALL SENSION FRACTOR OF MINISTERS.

 6. ALL CONTINUED AND ALL SENSION FRACTOR OF MINISTERS.

 6. DECEMBER OF THE SENSION FRACTOR OF PRINTET PROCESS OVER, VERIEF WITH MICHIPACH CONTINUED.

 6. THE CONTINUED AS A SEPCIFIC OR FORM IT PROCESS OVER, VERIEF WITH MICHIPACH CONTINUED.

- APPROVED BY THE YILLIOE.

 1. COMBUSTION, ARRIVED SUPPLY BY COMPANY ARRIVED STELL, SERVE A SHAGE APPLICATE EXACUSINE AND MUST COMPONING THE YILLIOE COOP.

 1. AND CANAGE ON CHYMING IN THE PERLANCE, SESPERATIONS AND THE SLEMMITTED BY WITHING TO THE ENVIRORM SESPERATIONS AND THE SLEMMITTED BY WITHING TO THE ENVIRORM SHADE OF THE PERLANDIS. THE SERVE SHADE OF THE PERLANDIS AND SHADE OF THE SERVE SHADE OF THE S

SHEET METAL NOTES

- ALL DUCTIVORK MUST BE GALVANZED BRON, CAUGES PER ASHRZE GUDE, BRAES OTHERRISE ROTED, ALL SOLARE BLOWS TO HAVE DOUBLE THROWES TYPE TURNING WAYES, LINESS OTHERWISE ROTED, ALL ROMO BLOWDS SHALL NEW BROSE PARAME EDUM, TO 15% OF DUCT WIDTH, MARIAL, VOLUME DAMPERS TO HAVE LOCKING OMARBAST.
- COMPANY.

 2. DEFIDER, GRALES, AND REGISTERS: EACH REGISTER SHALL BE FURNISHED WITH AN OPPOSING BLANS YOULDE CAUPER WITH AD INSTANCE AN RETURN LOADER.

 3. ALL DUCTYORN WI LINEATED AREAS SHALL BE ADEQUATELY PROTECTED AGAINTS THE ELEMENTS.

VENT NOTES

- YENTS SHALL TERMINATE NOT LESS THAN 2 FEET ABOVE THE HIGHEST POXITI OF THE ROOF PENETRATION AND NOT LESS THAN 2 FEET HIGHER THAN ANY PORTION OF A
- HOLD PENELBRAIKH AND MILESS HAVE FEEL HOLDER (1994 AN PORTION OF A BUILDING WITHOUT OF FEET.). HORIZOUTHAL TERMINATIONS FOR VEHIS ARE PERMITTED ON CATEGORY IV APPLIANCES ONLY AND SPALL BE LOCATED PER APPLICABLE CODE.

COMBUSTION AIR DUCTS

- COMBUSTION AIR DUCTS SHALL:

 1. BE OF GALVANIZED STEER. COMMANNE WITH CHAPTER 8 OR OF EQUIVALENT CORRESSOR MESSIAMIT LIMITERAL APPRIORED FOR INSI AFFLICATION.

 2. HAVE A LIMITAGESTATION LIMITAGES AND STATES AN


REFRIGERATION NOTES

- refrigeration piping; i. Copper Tubbig May be type acq or type "n" unless the pressure exceeds the
- ANED CAPACITY OF ACR TIBERA.


 2. ALL DON'TS A CONNECTION'S TO BERAZED
 3. BRICKIVE EXPANSION VALVES, DEDICES, AND CONNECTIONS FROM THE ARK STAEAUL
 4. RISTAUL PRESSURE RELIEF VALVE ON HIGH PRESSURE SIDE OF SYSTEM, LPSTREAM OF
 ANY DITERPRESAND VALVES.

CONDENSATE PIPING NOTES


- FIZEL-BURNING, EVAPORATINE & COOLING DEVICES THAT PRODUCE CONDENSATING MUST BE DRAWED. CONDENSATE SHALL BE COLLECTED AND INSCHARGE TO AN APPROVED FACE OF GISPOSAT. COMPOBATE PROX SHALL BE TIPM COPPER OF SCHEDULE OF INC AND SHALL NOT BE SMALLER THAT THE DRAW COMPOTION OF THE APPLAYER SIXTH PER SHALL BANTAIN A MEN HOROWITH. SCOPE IT THE ORDERION OF DISCUSSED ON DITLES THAT DISCUSSED THAT THE THE APPLAYER STATES.
 CHERCHOL PROMISS SHOULD DESCRIPT WAT VEHICLA UP UNINTSHORE.
 COMERGIOUS PRANS SHOULD DESCRIPT WAS PREVIOUS LICATION.

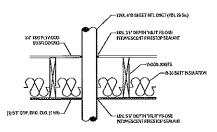

2 METAL DUCT THRU-PENETRATION FIRE STOP SYSTEM#FC-7013, 1 HR. RATING

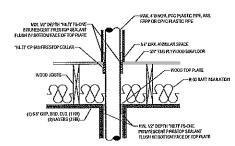


3 PLASTIC PIPE THRU-PENETRATION FIRE STOP SYSTEM # FC-2025, 1 & 2 HR. RATING

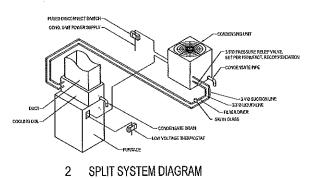



NTS

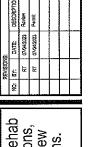

Convert 2-Unit to Single Family Residence. Interior Rehab & New 2-Story Frame Addition including New Partitions, New Electrical, Mechanical & Plumbing Systems, New Roof System & New Rear Deck & Balcony per Plans. 223 Center Street, Naperville Illinois 60540

R.T. ARCHITECT INC

PROJECT ARCHITECT: DRAFTPERSON: PPROVED: PREPARED FOR LOCATION: 223 Center Street Naperville, IL 60540 JOB NUMBER:


SHEET No.:


Light, Vent & Equip. Sched.- Mech. Notes


PI	UMBING FIXTURE SCHEDULE	
SYMBOL	DESCRIPTION	YIJTYAUD
	NEW TOLET / W.C.; PER OYMER SELECTION	5
o Lix	NEW LAVATORY. PER OWNER SELECTION	7
T.o	NEW TUB: PER OWNER SELECTION (80')	1
	NEW FREESTANDING TUB: PER OWNER SELECTION (80')	1
Book	NEW SHOWER: PER OWNER SELECTION	2
Warba Land	WASHER: PER OWNER SELECTION (Residental Grade)	2
::0	LAUXDRY SERVICE SING- PER OWNER SELECTION	1
Sal	NEW KITCHEN SING PER OWNER SELECTION	1
[]	DISHWASHER: PER O'WIER SELECTION (Residental Grade)	1
	TOTAL	21
00 (19)	NEW WATER HEATER: HIGH EFFICIENCY TANKLESS. PER MANUFACTURER RECONMERNIATION	2


PLUMBING NOTES

- 1. THE FLUMBING CONTRACTOR SHALL INCLUDE ALL NECESSARY LABOR MATERIALS AND EQUIPMENT REQUIRED FOR A COMPLETE AND OPERABLE INSTALLATION OF ALL WATER AND SENAGE SYSTEMS
 2. ALL SYSTEMS AND EQUIPMENT SHALL CONFORM TO APPLICABLE LOCAL, STATE AND NATIONAL COORS.
 3. UNDERGROUND WATER PROPS SHALL BE THE C. COOPER WITH PARED FITTING.
 4. HITERIOR SUSPENDED WASTE AND VENT PEWES SHALL BE SCHEDULE OF PVC-PPE AND FITTINGS.
 5. BURRED VINSTE PIPMEN AND THE VEHICS CONSCIENCE TO IT SHALL BE CAST RICH OF SERVICE WEIGHT, UNLESS CITY APPROVES THE USE OF SOLM OF PC.
 5. SUSPENDED WATER PROPS SHALL BE THE COOPER WITH LEAD PREE SOLDER.
 7. ALL WATER POPES TO PKTURES AND WATER HEATER SHALL BE VALVED.
 8. PROVIDE "TO R"TO ONCICIONED ROMOIS WASSEN TO DISSOCIAL.
 9. PULMBING FATURES TO BE PER ATTACHED BUILDERS SPECIFICATION.
 10. UNDERGROUND & UNDERFLOOR WASTEN MIA F.
 11. UNDERGROUND & UNDERFLOOR WASTEN MIA F.
 12. ALL FLOOR GARDIS SHALL BE ROMOIDMALLY VENTED.
 13. YATER TEMP. FOR TIUS AND SHOWERS = 110.
 14. PROVIDE "PT TRASS FOR ALL FLOOR FRATURES, MAX AT FROM FEMURE TO TRAP WEIR.
 15. SUPLY & WASTE ARE NOT PERMITED IN EXTERDIOR YALLERS.
 16. THE TEMP. FOR TIUS AND SHOWERS = 110.
 17. EXTERIOR DRAINSWASTE LIBES SOR OR BETTER IS PERMITED.
 18. ALL RANK WASTE AND STATE SHALL BE CHAILED AND FROM THE PRINCE OF THE SHALL BE.
 19. ALL RANK WASTE AND THE STREAM FOR THE STEML BE FORTON TO ENCLOSING, SUCH TEST SHALL BE DONE BY FALLOR THE PRINCE SHALL BE FUT UNDER AR PRESURE AT 5 LBS. FOR A PERIOD OF 15 VRATES ON HORE.

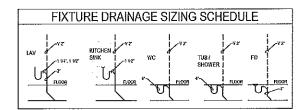

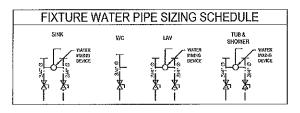

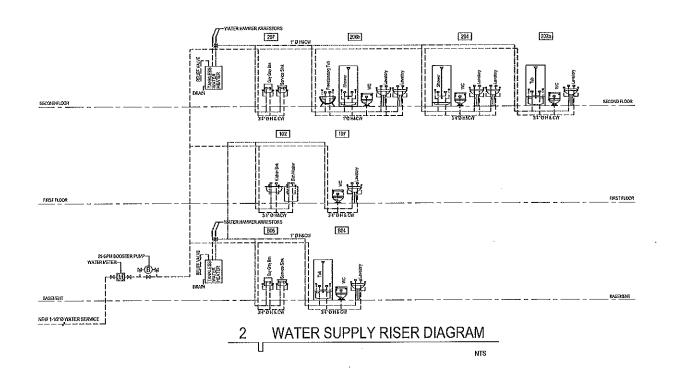

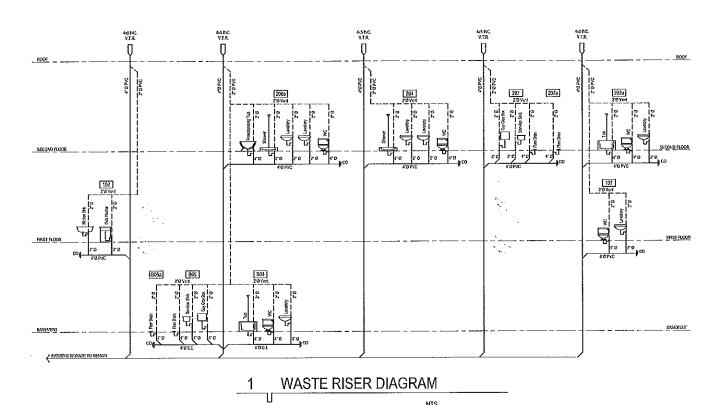



Convert 2-Unit to Single Family Residence, Interior Rehab & New 2-Story Frame Addition including New Partitions, New Electrical, Mechanical & Plumbing Systems, New Roof System & New Rear Deck & Balcony per Plans. 223 Center Street, Naperville Illinois 60540

R.T. ARCHITECT INC.

PROJECT ARCHITECT: PREPARED FOR: OVINER LOCATION: 223 Center Street Naperville, IL 60540 30B NUMBER: 223CS-07642023

P-01 SHEET No.:

SHEET Name: Plumbing Riser Diagrams



CITY OF NAPERVILLE

Transportation, Engineering & Development (TED) Business Group

<u>HISTORIC PRESERVATION COMMISSION CERTIFICATE OF APPROPRIATENESS</u> (COA) APPLICATION PACKET

An application for a Certificate of Appropriateness (COA) is either subject to an administrative review through the Fast Track Approval process or review by the Historic Preservation Commission at a public meeting. The Historic Preservation Commission is a nine-member board that typically meets every other month to review COA applications that are subject to Commission review. To find out about if your project is subject to administrative or Commission review, please refer to the attached informational sheet (Exhibit A). If your project is subject to administrative review, please fill out the Fast Track Application which can be found on the City's website. This application is only applicable for projects which require Commission review. To facilitate the review process, COA applicants are required to provide the information and documentation set forth below.

Step 1: Prepare Application Materials

Applicant shall fill out pages 3-9 of the attached Application form and prepare necessary application materials based on the requirements specified in the application packet. For first time applicants, it is strongly encouraged for the applicant to meet with staff prior to submitting the application to go over the process and determine the required submittals and the appropriate approval process. Please contact Assistant Planner, Brad lwicki at iwickib@naperville.il.us to schedule an appointment.

Step 2: Submit Application Materials

Please submit your application to Assistant Planner, Brad Iwicki at iwickib@naperville.il.us. Once submitted, City staff will review the application materials and provide the applicant with review comments, if any. The Applicant is encouraged to work with staff to address issues identified in the review comments prior to submission of the Application to the Historic Preservation Commission. Any outstanding issues will be forwarded to the Commission for discussion and review at the public meeting.

Once staff determines the application is complete, staff will work with the Applicant to schedule the case for a Historic Preservation Commission meeting, taking into consideration the public notification requirements (see step 3 below). There is no fee for the filling of the application.

Step 3: Send out Public Notification

NOTICE LETTER

Before the scheduled Historic Preservation Commission meeting, the applicant shall give written notice of the meeting to the current owners of all lots lying within three hundred feet (300') of the subject property, inclusive of public right-of-way. To obtain a list of property owners within 300', please contact your applicable township office. The written notice can be delivered personally or may be sent by first class mail no later than fifteen (15) days in advance of the public meeting. If notices are delivered personally, a log of signatures confirming the property owners received the notice must be submitted. A signature log template is included in Exhibit B. A sample notification letter is included in Exhibit C.

NOTICE SIGN

The applicant shall also post notice of the public meeting on a sign visible from the street (excluding alleys) upon the subject property, for a continuous period of not more than thirty (30) days and not less than fifteen (15) days in advance of the public meeting. The applicant can check out a standard notification sign from the city for use on the subject property with a \$100 deposit. The deposit will be refunded after the sign is returned to the city. If the applicant wishes to check out a notification sign, please complete the "Sign Deposit Acknowledgement" form contained in Exhibit D and request the sign from staff at the meeting to submit the application.

AFFIDAVIT THAT NOTICE HAS BEEN GIVEN

Prior to the public meeting, the applicant shall file a sworn (notarized) affidavit, including a copy of the notification letter, with the city showing the names and addresses of the persons to whom the written notices have been sent or delivered, and that such notices were sent or delivered no less than fifteen (15) days in advance of the public meeting. A sample affidavit is included in <u>Exhibit E</u>.

Step 4: Attend the Historic Preservation Commission Meeting

The applicant is required to attend the Historic Preservation Commission meeting to present the project and answer questions. The Commission will also hear public comments prior to voting on the project. The Commission may approve, approve with conditions, or deny the COA application at the end of the meeting. If approved, a signed copy of the COA will be issued and emailed to you following the meeting.

Step 5: Complete Your Improvement

Please note that the project may still require a separate building permit prior to any work commencing. Refer to the approved COA to find out whether you should apply for a building permit as the next step.

For improvements that do not require a building permit, a COA inspection needs to be scheduled at the time of the COA approval. You may call Inspection Dispatch at 630-420-6100 (press "1") to schedule or reschedule an inspection. Inspections for other improvements shall follow the building permit process.

For further information about COAs please contact:
Brad Iwicki, Assistant Planner
Iwickib@naperville.il.us
630.305.7021

COA#	£



CITY OF NAPERVILLE

TRANSPORTATION, ENGINEERING, & DEVELOPMENT (T.E.D.) BUSINESS GROUP

<u>HISTORIC PRESERVATION COMMISSION CERTIFICATE OF APPROPRIATENESS</u> (COA) <u>APPLICATION PACKET</u>

This application form is used for the Historic Preservation Commission's review of COA applications.

PLEASE TYPE OR PRINT CLEARLY. ****NO MAIL-IN APPLICATIONS WILL BE ACCEPTED****

1. OWNER/APPLICANT (REQUIRED INFORMATION)

Property Address:	223 center st
Applicant Name(s):	Mkjh Remodling IIc
Address/Zip:	60540
Telephone – Day/Evening:	708-372-5766
Fax (optional):	
Email:	mkhalil_915@yahoo.com
Property Owner Name(s):	Moses Khalil
Address/Zip:	223center street 60540
Telephone – Day/Evening	708-372-5766

COA	#							

2. <u>PICTURES OF EXISTING STRUCTURE OR PORTION OF STRUCTURE TO BE MODIFIED</u>

Provide color photos (clearly labeled) or a building elevation diagram to show the existing structure or portion of structure that would be affected by the proposed work.

3. PROPOSED WORK (Check all that apply)

A COA from the Historic Preservation Commission is required for the following works performed on the primary façade (street-facing façade) of the principal building, fences, driveways or attached garages. Please refer to Exhibit A for a list of improvements that are waived from the COA requirement or are eligible for fast track (staff level) approval.

	Improvement Type*	A COA from the Commission is required for the following:
•	Doors	New opening, a change in style or opening, or use of material that is not wood or original material
8	Windows	New opening, a change in style or opening, or use of material other than wood or aluminum clad wood
	Roofs	A change in height or pitch; or use of material other than asphalt or original material.
	Exterior Building Materials	A change in reveal or profile; or use of material other than wood, fiber cement board or original material.
	Porches	New enclosure, a change in size or style, or use of material that is not one of the following: 1. Replacement of porch columns with use of wood, plaster or cement materials; 2. Replacement of porch flooring with use of wood or composite decking materials; or 3. Replacement of other porch components with use of wood or original material.
B	Shutters and Awnings	A change in size, style or new addition
D	New Principal Structure	The primary façade of the new structure
0	Additions	The primary façade of the addition
	Modifications to the Primary Façade	Any modifications that will change the appearance of the original Improvement.
8	Demolition	Demolition of a principal structure in whole; removal without replacement of original architectural features contributing to the style of the principal building or structure
	Driveways	New or relocated street access that is more than five feet (5') from the existing street access.

COA#

G	Fences	Along the street: fences constructed of materials other than wood or iron open picket
	Attached Garage	New attached garages
0	Solar Panels and Skylights	Solar Panels and Skylights on Principal Structures

^{*}A building permit may also be required for the above improvements. Please contact the Development Services Department at 630-420-6100 (press "2") to confirm.

4.	DESCRIPTION OF PROPOSED WORK (attach a separate sheet as needed)
	A. If demolition is proposed, describe the scope of the demolition in detail, including a list of original features to be removed or replaced from the primary façade of the building.
	We will be demoing the roof line, the windows and the front door

B. Describe the proposed work in full detail, including materials, style and specifications of key items (e.g., windows and trim; siding and reveal, soffit, fascia, and gutters; porch rails, balustrades, pillars, decking, and ceiling; roofing; exposed foundation; fencing; etc.). If a portion of the residence is being removed or added, please describe the material and justification (e.g. in-kind replacement; aligns with the style of the residence; etc.).

The roof will be elevated and replace with shingles. Windows will be replaced and moved to a safer height as the current height is not safe. The front door is damaged and not repairable so will be replaced with a new wood door. New gutter, fascia, soffit and siding will be repaired and replaced with similar materials. Shutters will stay.

COA #_		

C. Describe how the proposed work will affect any external architectural features of the structure.

The only part of the home that will change architecturally is the roof line will be similar to the old roof line however just raised higher

- D. Attach drawings and specifications (not to exceed 11"X17" in size) to include:
 - Address of property
 - · Date of most recent revision
 - Site Plan to include:
 - i. Measurements of the lot
 - ii. Existing buildings
 - iii. Proposed modifications or additions with the distance from all lot lines labeled.
 - Demolition Plan to clearly identify any portion of the structure to be demolished, even if it
 will be replaced with a similar structure or building addition.
 - Building Elevations of proposed modifications or building additions. Please see <u>Exhibit F</u> for
 an example of a complete building elevation submittal. If the property is located on a corner
 lot and the proposed modifications can be seen from both the corner and front sides of the
 property line, elevations of the corner and front should be provided. The elevations should
 include:
 - i. A key that specifies the location of the façade and details of the proposed building materials and styles. All new materials must be clearly labeled on the elevations. Please note if the material is in-kind or aligns with the style of the residence. If the material is not in-kind or in the style of the residence, please explain why the material was chosen.
 - ii. On a separate sheet, please provide a written description of how each change to the façade complies with the existing structure's architectural style. If the change is not consistent with the architectural style, please explain why. This can be included on a separate sheet or on the elevations. Clarify whether the style can be found elsewhere existing on the structure or why the new style should be approved. For example, if the beams of the proposed new front porch are tapered
 - approved. For example, if the beams of the proposed new front porch are tapered at the top, please explain why this style was chosen and, if applicable, reference the Historic Building Design and Resource Manual.
 - iii. We recommend adding weight to the lines, showing the proposed changes in a thick weight and the existing structure in the standard weight.
 - iv. Height of any proposed building additions or new structures.
- 5. FACTORS FOR CONSIDERATION OF A CERTIFICATE OF APPROPRIATENESS APPLICATION RESPONSES (attach a separate sheet as needed)

COA	#					

Respond to the factors for consideration below that demonstrate the need and appropriateness of your request. Example responses to each factor can be found in Exhibit G. Your responses will be forwarded to the Historic Preservation Commission along with the staff memo. Before responding to the standards, review the Historic Building Design and Resource Manual (https://www.naperville.il.us/contentassets/7fed1bf2ba19496fa9a037f019616748/cdg-historic-building-design-and-resource-manual.pdf) against your proposed changes. If your proposed changes are not listed in the Historic Building Design and Resource Manual as "encouraged" or "acceptable" changes, please respond to 5.3 and 5.4. If the changes are considered "encouraged" or "acceptable" please write "N/A" for 5.3 and 5.4. Please provide thorough responses to each of the standards below.

Factors For Consideration Of A Certificate Of Appropriateness Application:

5.1. Compatibility With District Character: The Commission and Zoning Administrator shall consider the compatibility of the proposed improvement with the character of the historic district in terms of scale, style, exterior features, building placement and site access, as related to the primary facade(s), in rendering a decision to grant or deny a certificate of appropriateness. Explanation: Please describe how the proposed changes will be generally consistent with the overall character of the Historic District. With this factor, the Historic Preservation Commission seeks to confirm that the proposed changes will not conflict with the characteristics (i.e., building setback, height, materials, etc.) that are typically found in the district.

Response to 5.1:
Keeping the roof design of our home to blend in with the neighboring house as well as keeping the front door and windows made from the same materials as the original home will keep our home historical characteristics.

5.2. Compatibility With Architectural Style: The Commission and Zoning Administrator shall consider the compatibility of the proposed improvement with the historic architectural style of the building or structure to be modified by the certificate of appropriateness request. Explanation: As a structure in the Historic District, guidelines for appropriate maintenance, rehabilitation and new improvements to enhance and preserve the appearance of homes are outlined in the Historic Building Design and Resource Manual. The Manual also provides background information on each architectural style found in the Historic District. For this factor, please use the Historic Building Design and Resource Manual to identify the historic features of your home as well as if your proposed changes are "encouraged, acceptable or discouraged" in the manual. Please also reference the 2008 Architectural Survey (https://www.naperville.ii.us/about-naperville/historic-district/) and identify if any of the listed significant features of the home are being removed or changed.

Response to 5.2:

After reviewing the link above, I believe our home will not have any issues with compatibility of architectural style. We will keep all of key points to make sure our home still looks like mixture of American Foursquare/ Greek Revival

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5.3. Economic Reasonableness: The Commission and the Zoning Administrator shall consider the economic reasonableness of any recommended changes determined to be necessary to bring the application into conformity with the character of the historic district.

Explanation: If the proposed improvement is "discouraged" in the Historic Building Design and Resource Manual, this factor allows the applicant to explain if there is an economic benefit necessitating the requested improvement instead of an improvement that is considered "encouraged" or "accepted". The economic benefit must be reasonable. The explanation should compare the economic benefit in receiving the COA approval for the improvement, as requested, as opposed to the alternative improvement required if the COA was not approved.

Response to 5.3 (Only respond if y Resource Manual guidelines):	our proposed changes do	The most the Hatene banding i	Josigii ana
<i>g</i>	NA		
eministration in visit in the contract of the			

5.4. Energy Conservation Effect: In making its determinations, the Commission and Zoning Administrator shall consider the effect that any recommended changes may have on energy conservation.

Explanation: If the proposed improvement is "discouraged" in the Historic Building Design and Resource Manual, this factor allows the applicant to explain if there is an Energy Conservation benefit which is necessitating the requested improvement instead of an improvement that is considered "encouraged" or "accepted." Please describe which aspects of the proposed changes will impact the energy efficiency of the home, and if possible, include metrics that show the change in efficiency. The explanation should compare the efficiency benefit in receiving the COA approval for the improvement, as requested, as opposed to the alternative improvement required if the COA was not approved.

Response to 5.4 (Only respond if your proposed changes do not meet the Historic Building Design and Resource Manual guidelines):

By changing the windows, we will improve the energy use of the home. Also, a safer home by raisin the window to proper height to lower risk of a fall as the current window is very close to the floor.

5.6. The City's Historic Building Design and Resource Manual may be used as a resource in consideration of the above.

Explanation: The Historic Building Design and Resource Manual is a guiding document for the Historic Preservation Commission with educational resources to assist the members in making well-informed decisions to protect and maintain the Historic District. In this section, please list and describe all portions of the manual that apply to your proposed changes. Please note if the proposed changes align with what is "encouraged", "acceptable", or "discouraged" in the manual.

Response to 5.6:

We are keeping the GABLE, GABLE ROOF, FOUNDATION, EAVE and COLUMNS on the porch. By doing this, I would consider our home "Acceptable" because of the replacement of original building materials with substitute materials that match or approximate the original in appearance and texture. Our home will still retain the appearance and architectural styles of historic buildings and the overall character. of the neighborhood.

COA #
6. RELATED VARIANCE, CONDITIONAL USE OR REZONING REQUEST(S):
Please describe any zoning variance, conditional use, or rezoning requests that may be required to complete the proposed work. (note: a separate application must be filed with the Planning Services Team for these requests).
NA

Please note: If the COA is approved, any changes to the approved COA will require additional review by city staff or the Historic Preservation Commission. An approved COA is valid for three (3) years from the date of the issuance of the COA.
Required Signature: The undersigned certifies that the statements set forth in this application including all drawings and specifications submitted herewith are true and correct, and further agrees that the proposed improvements described in this application will be constructed in all respects in accordance with the

approved COA as specified in the application, drawings and specifications submitted herewith.

Signature of Owner (if different):______Date:____

Signature of Applicant:

EAST ELEVATION



South Elevation



West Elevation



North Elevation

