


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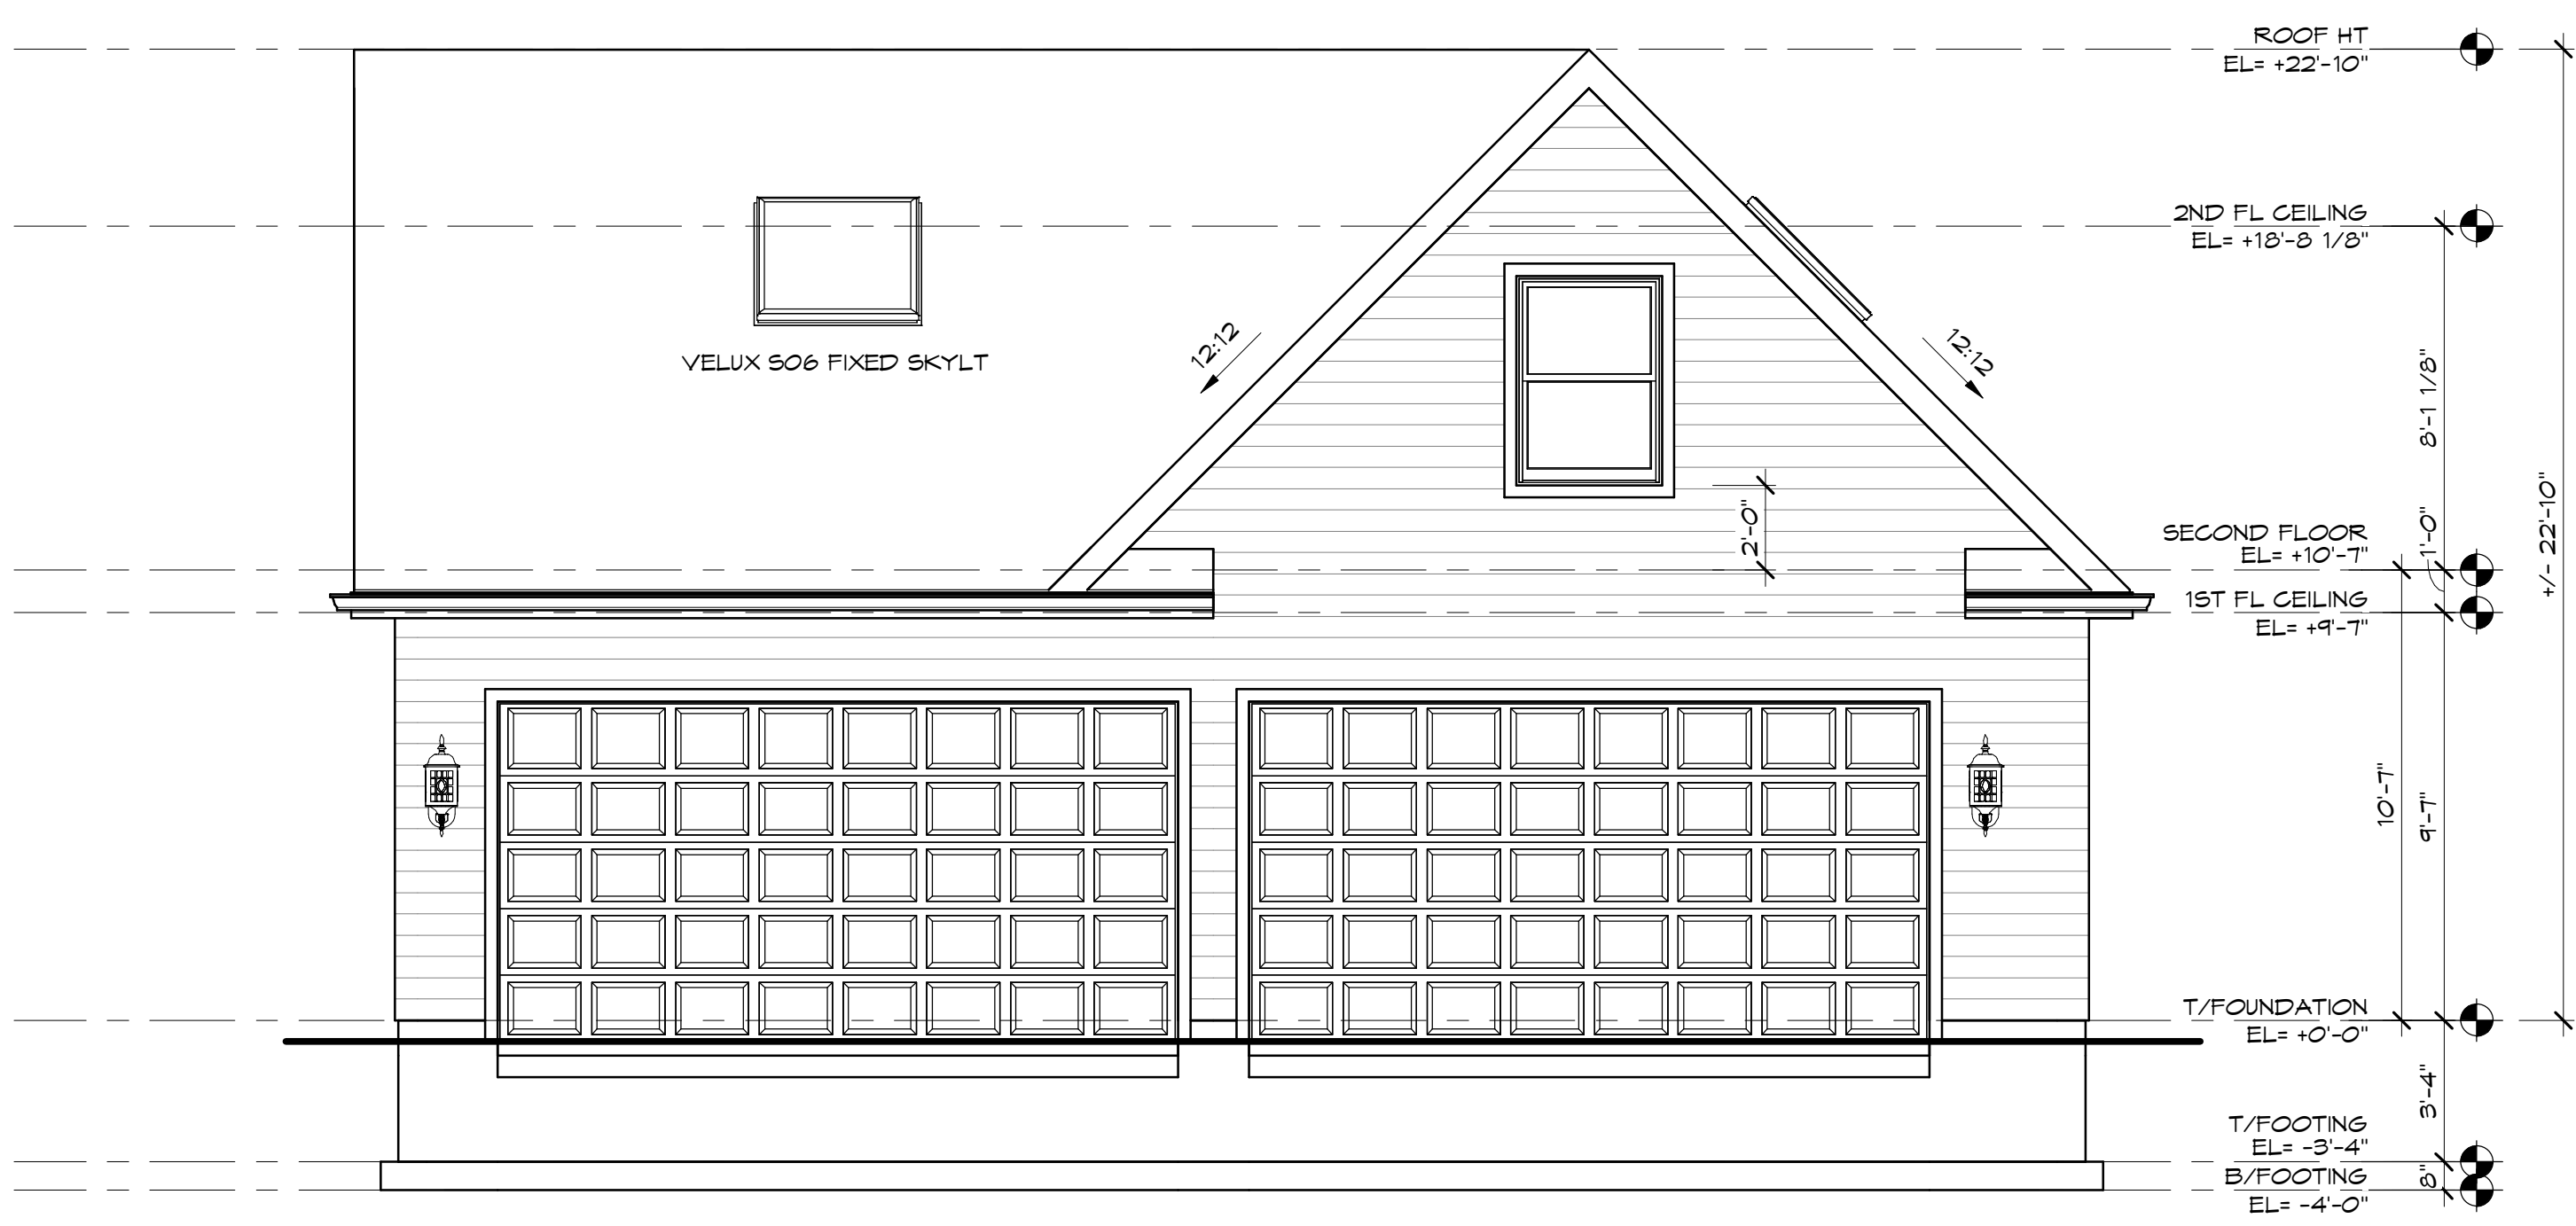


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 drawings A-1-A.3
 dated 10/23/2024
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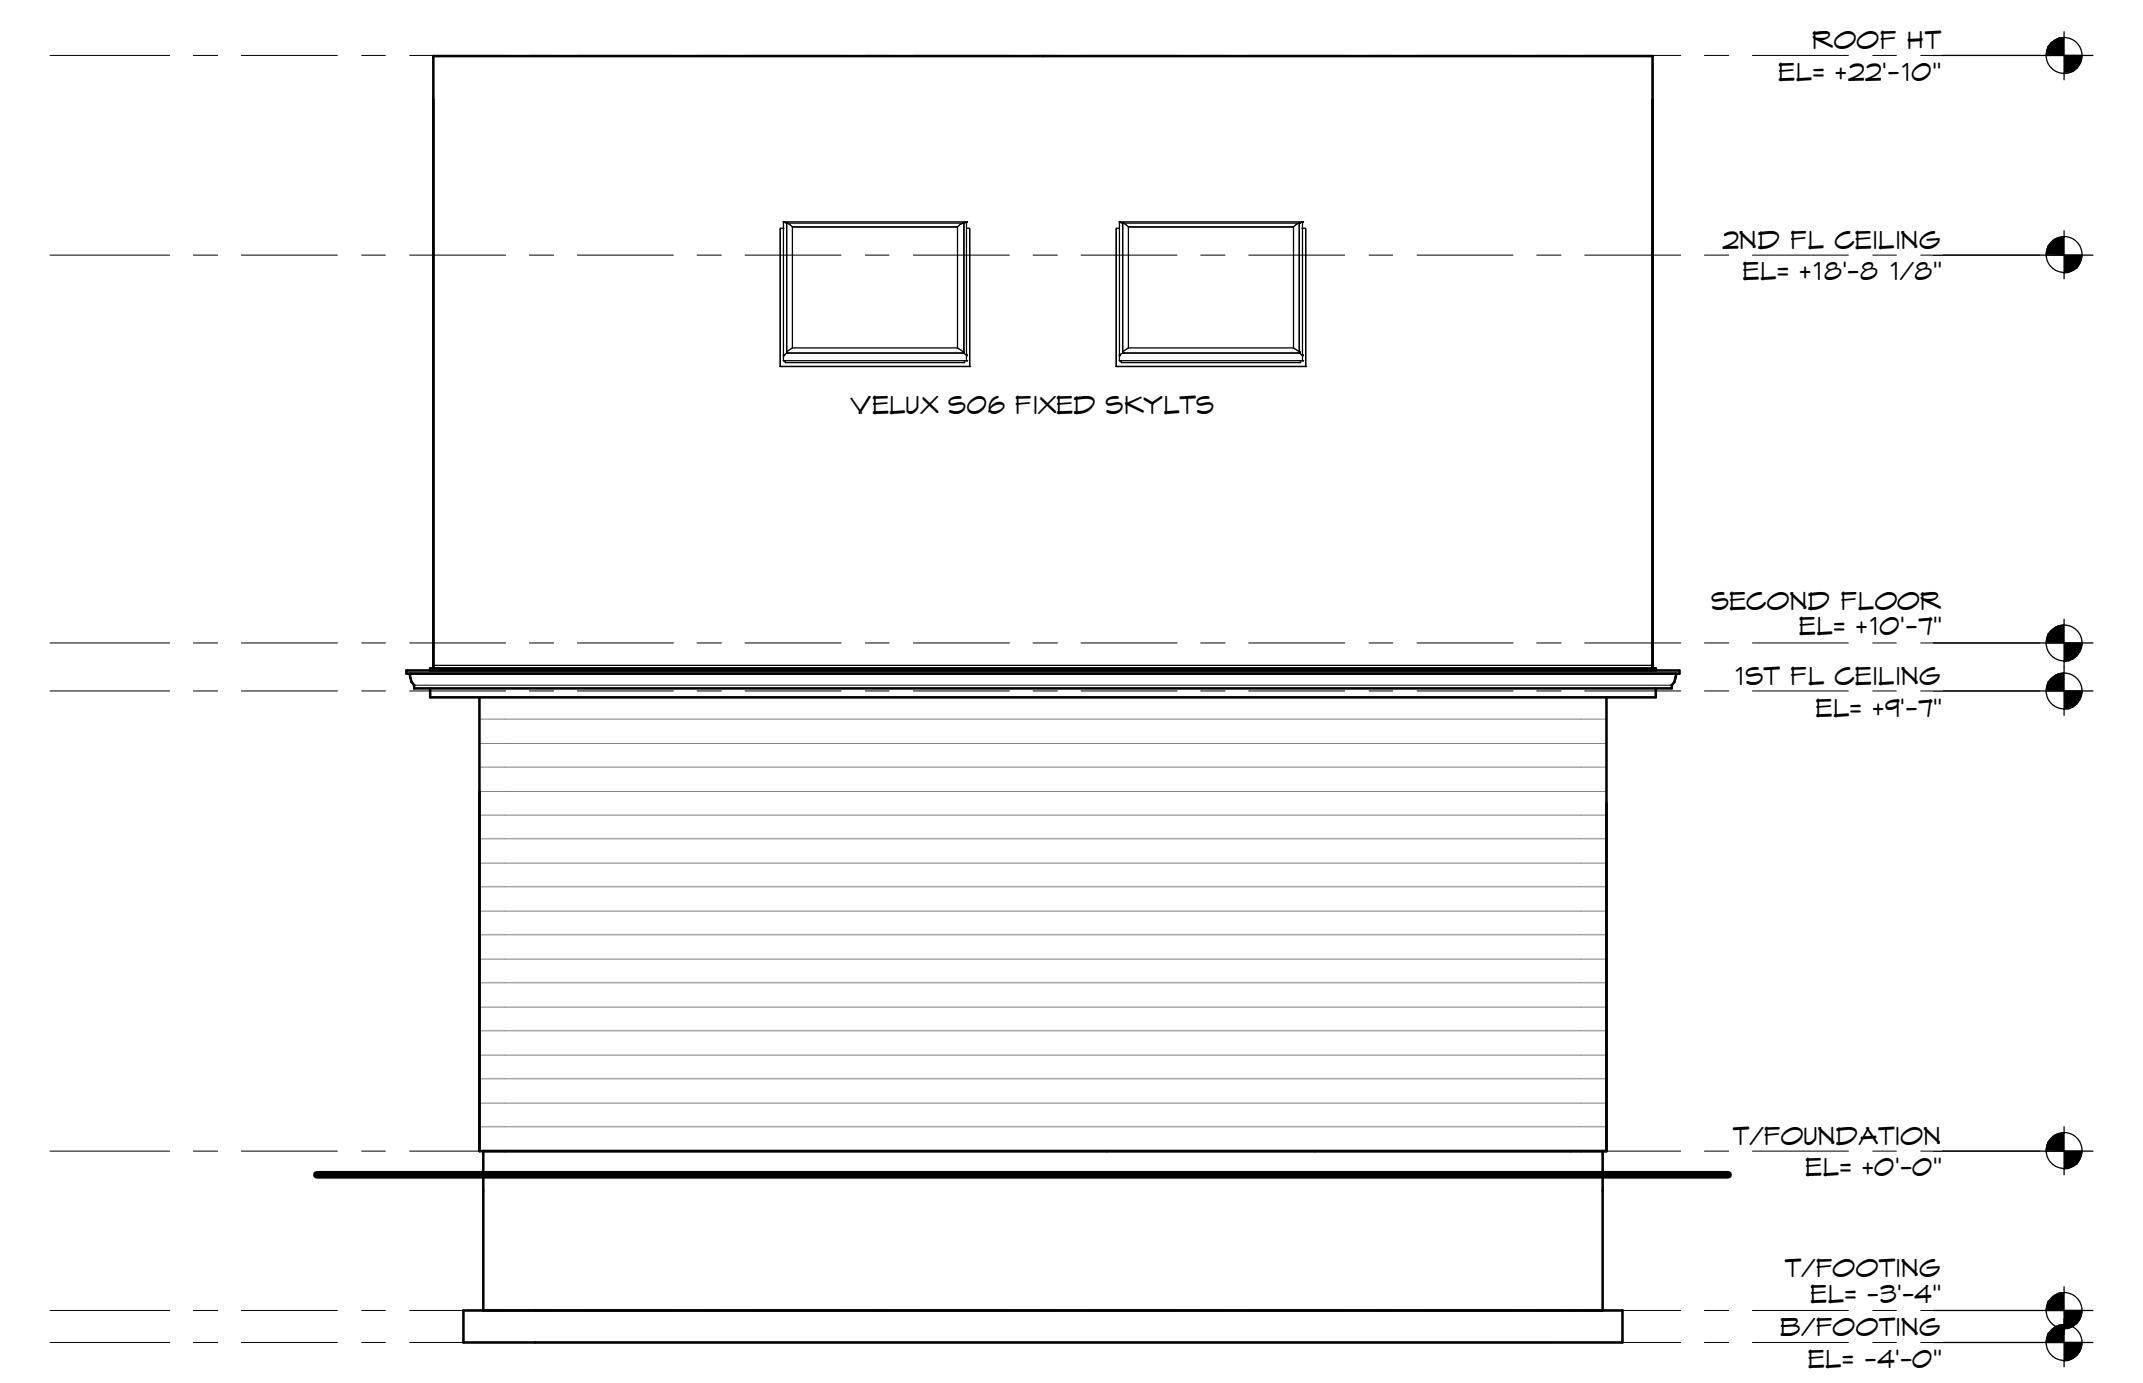
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REVISION SCHEDULE		
ID	DATE	DESCRIPTION
1	10.03.2024	PERMIT REVISION
3	10.21.2024	OWNER REVISION
4	10.23.2024	PERMIT REVISION


ISSUE DATE	10/23/2024
DRAWN BY	PRL
CHECKED BY	PRL
PROJECT NUMBER	24002
ELEVATIONS, SITE PLAN, NOTES	
A.1	

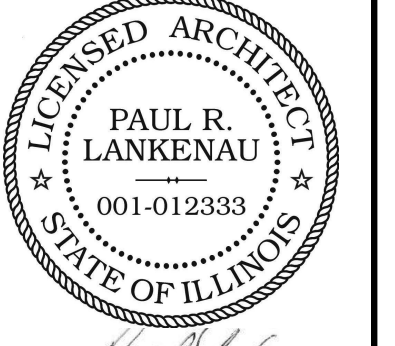


1 SOUTH ELEVATION
 1/4" = 1'-0"




2 EAST ELEVATION
 1/4" = 1'-0"

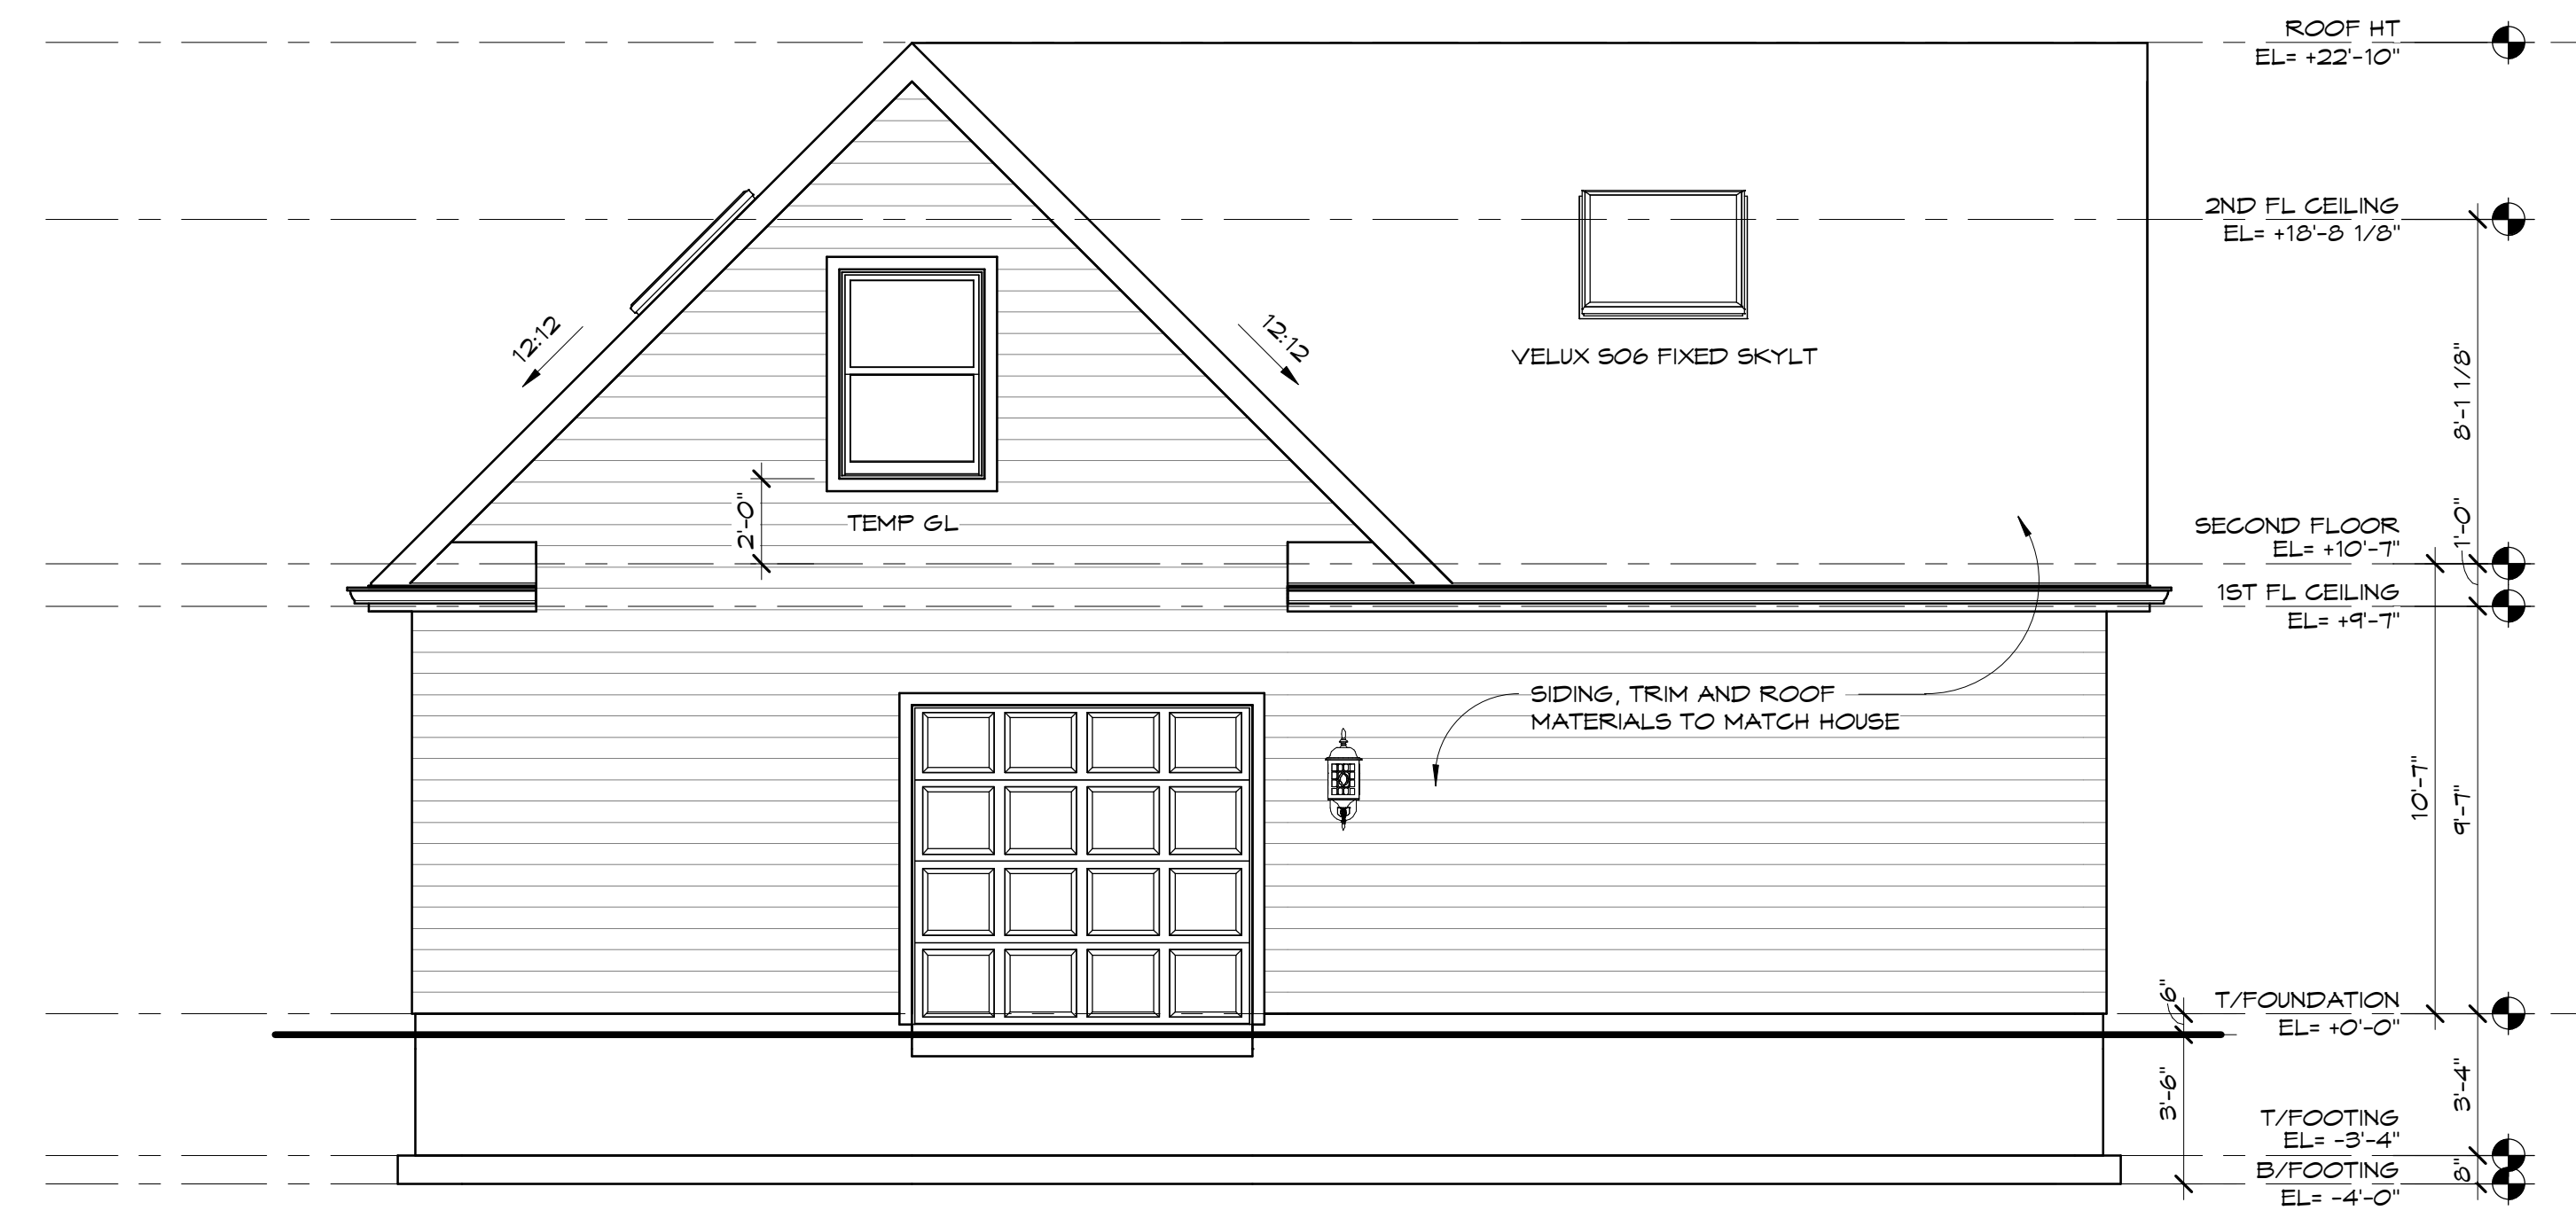

3 NORTH ELEVATION
 1/4" = 1'-0"

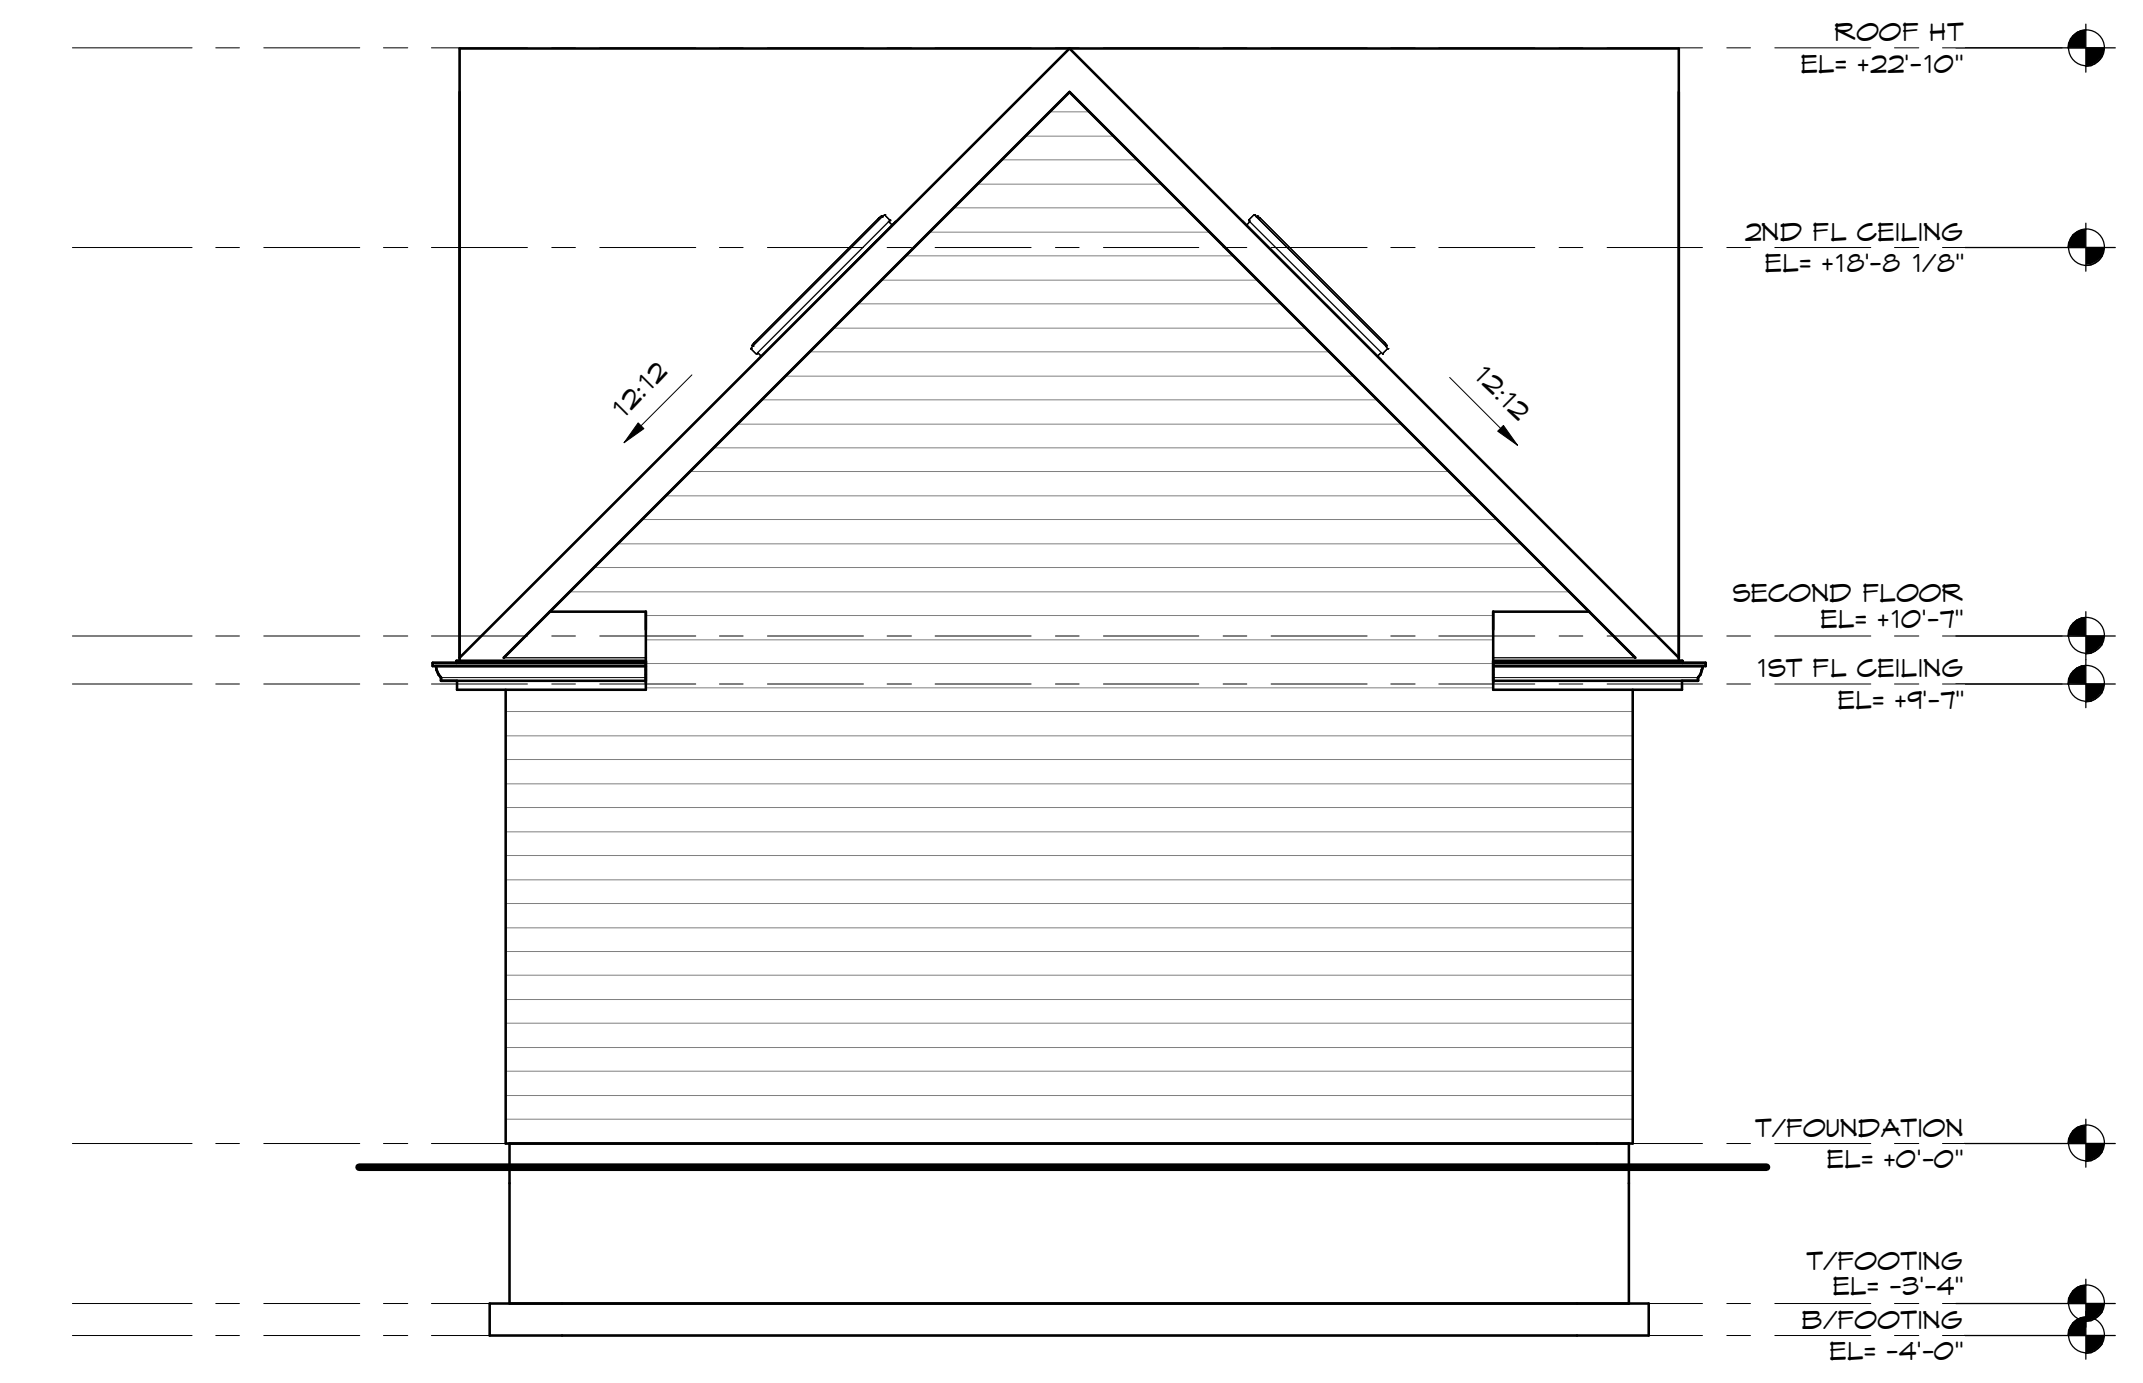

4 WEST ELEVATION
 1/4" = 1'-0"

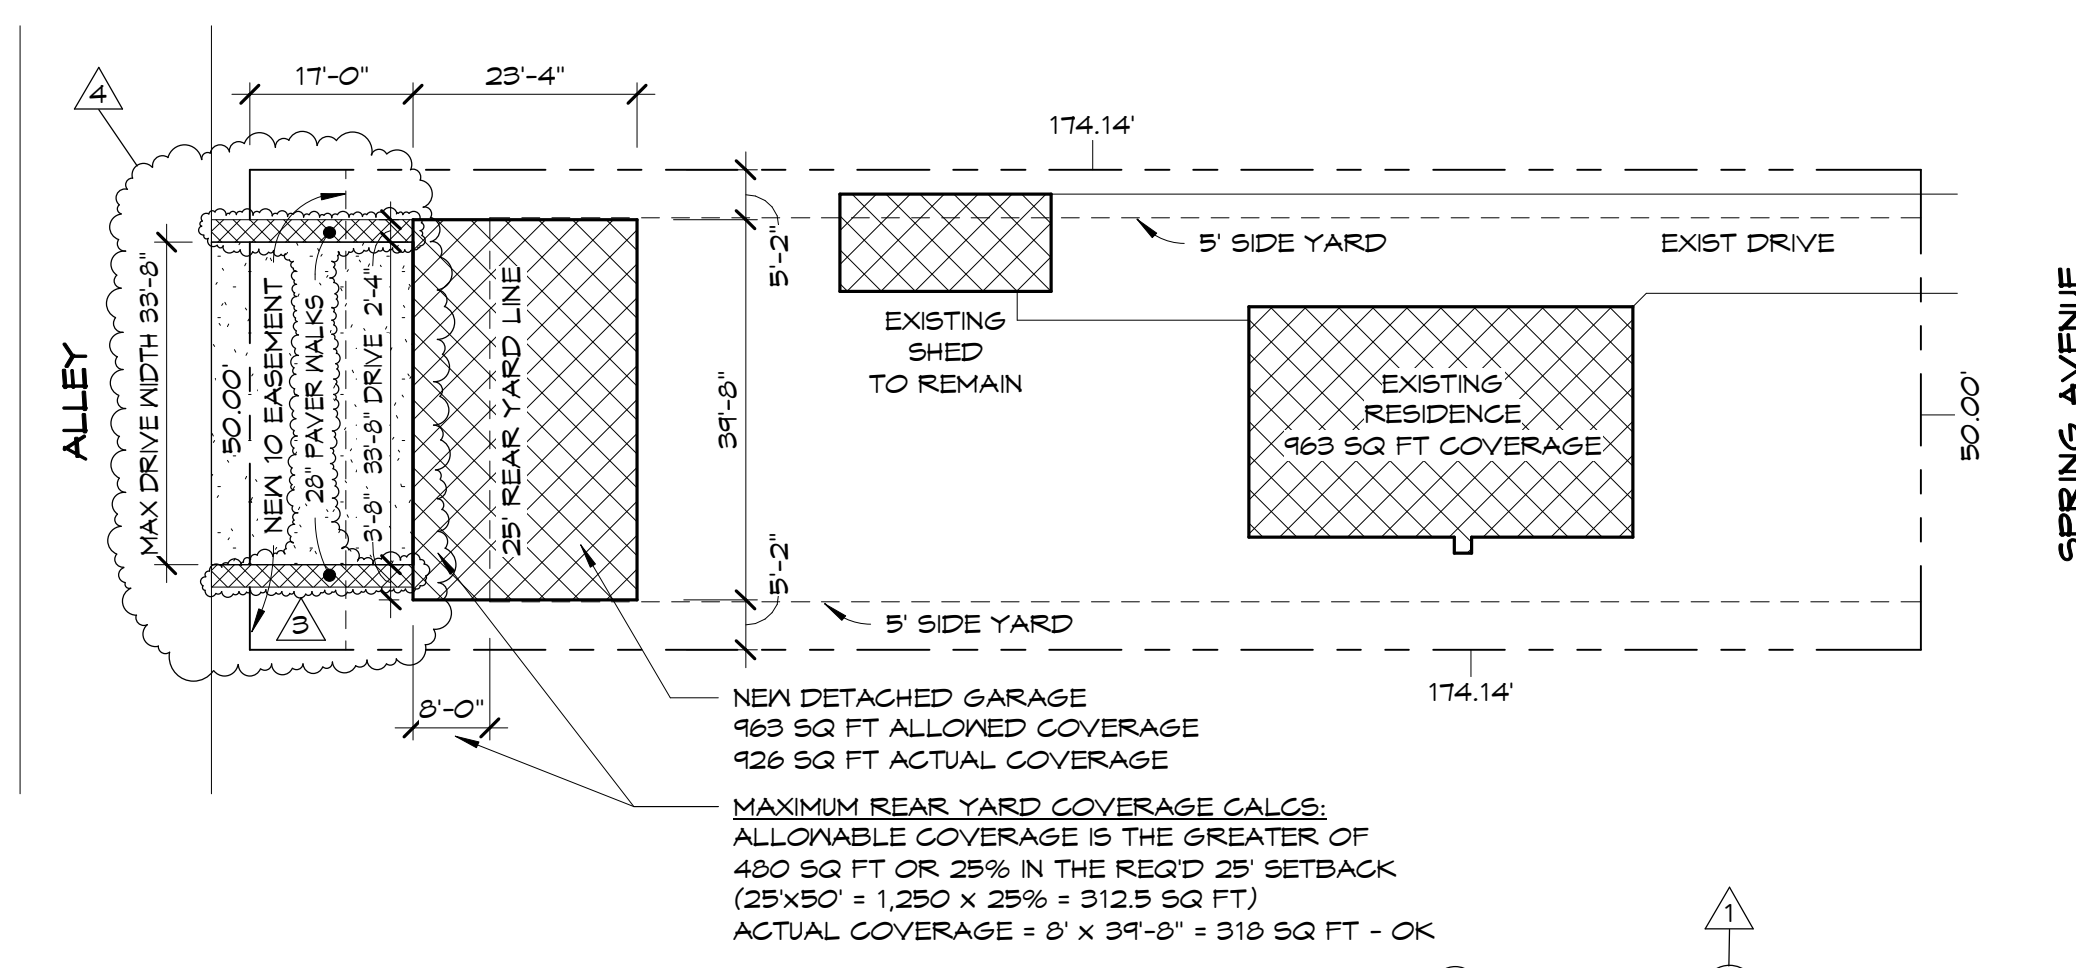


5 SITE PLAN
 1" = 20'-0"
 MOVED TO THIS SHEET


STRUCTURAL DESIGN LOADS:
 SOIL BEARING CAPACITY = 1,500 PSF MINIMUM
 FLOORS AND STAIRS = 40 PSF LL + 10 PSF DL
 ATTIC STORAGE FLOOR = 40 PSF LL + 10 PSF DL
 WALL LOAD = 15 PSF EXTERIOR FRAME WALLS, 10 PSF INTERIOR
 ROOF LOAD = 30 PSF SNOW LOAD + 15 PSF DL
 GUARDRAILS AND HANDRAILS = 200 LB LOAD AT ANY POINT ALONG THE TOP (50 LB LOAD AT ANY POINT ON INFILL COMPONENTS)

EXHIBIT C


DRAWING SHEET LIST	
SHEET	SHEET NAME
A.1	ELEVATIONS, SITE PLAN, NOTES
A.2	FLOOR PLANS, FRAMING DETAIL AND SECTIONS
A.3	SECTIONS, FOUNDATION & ELECTRICAL PLANS

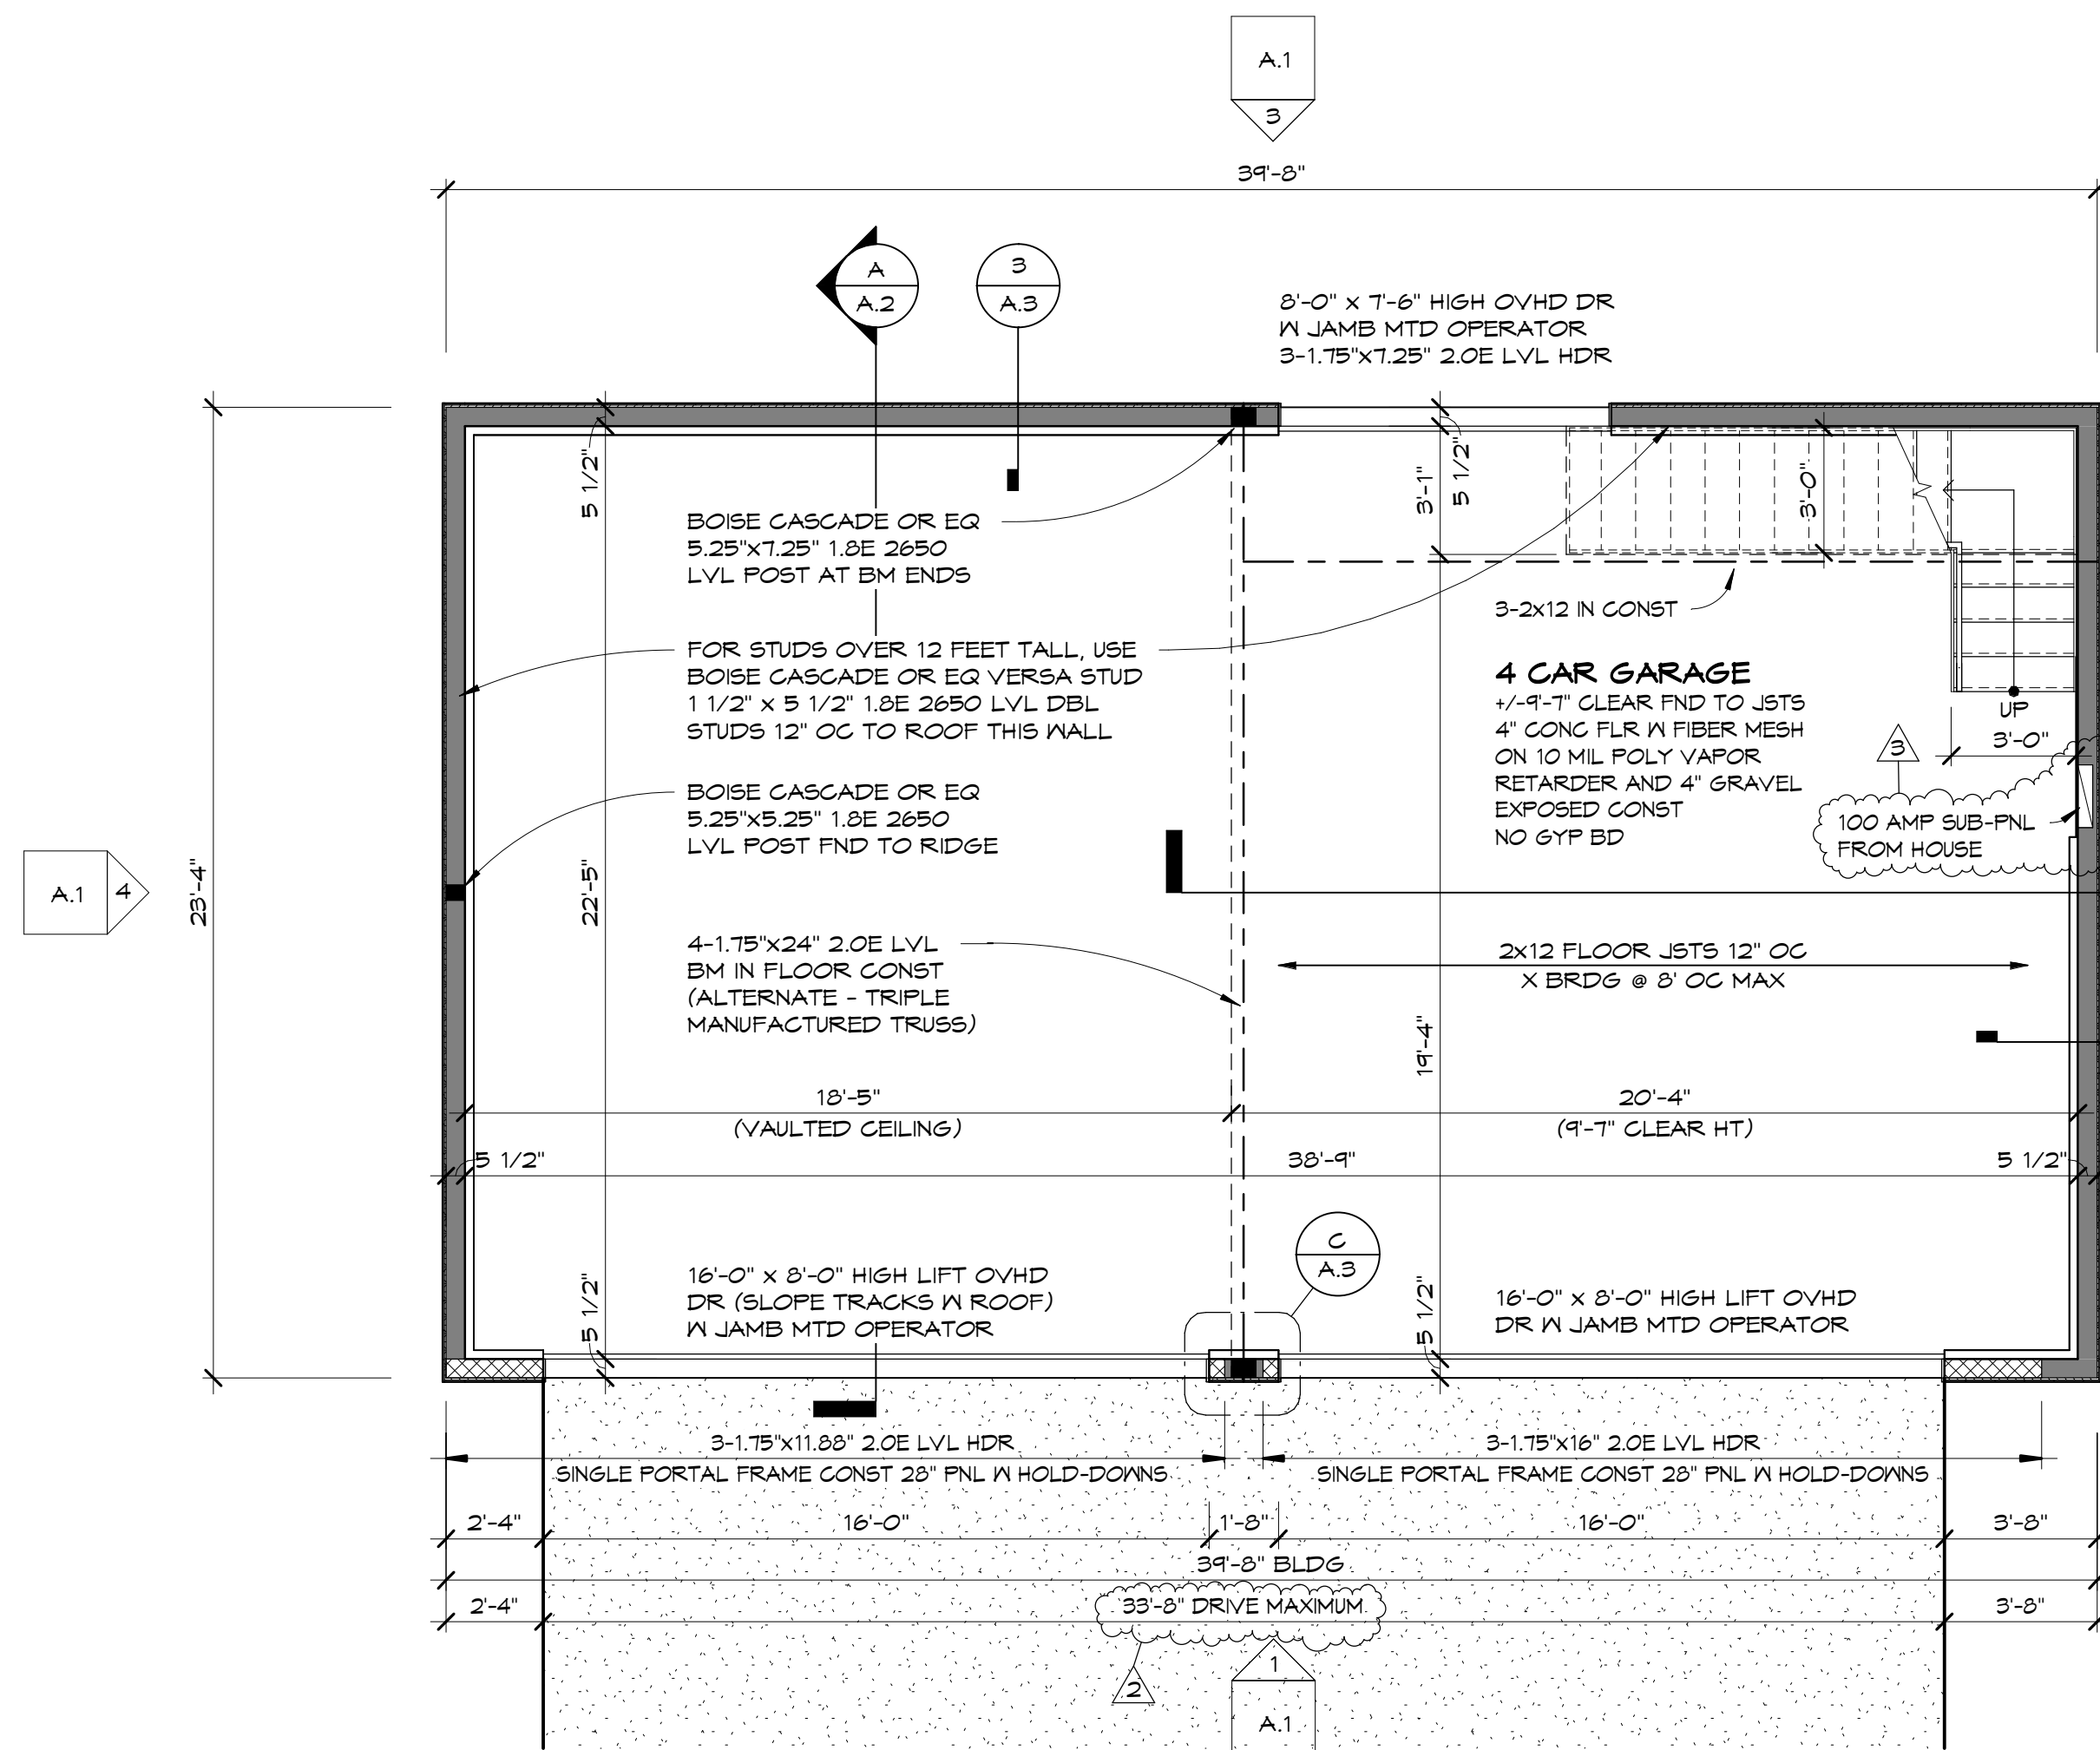


1 FIRST FLOOR PLAN
1/4" = 1'-0"

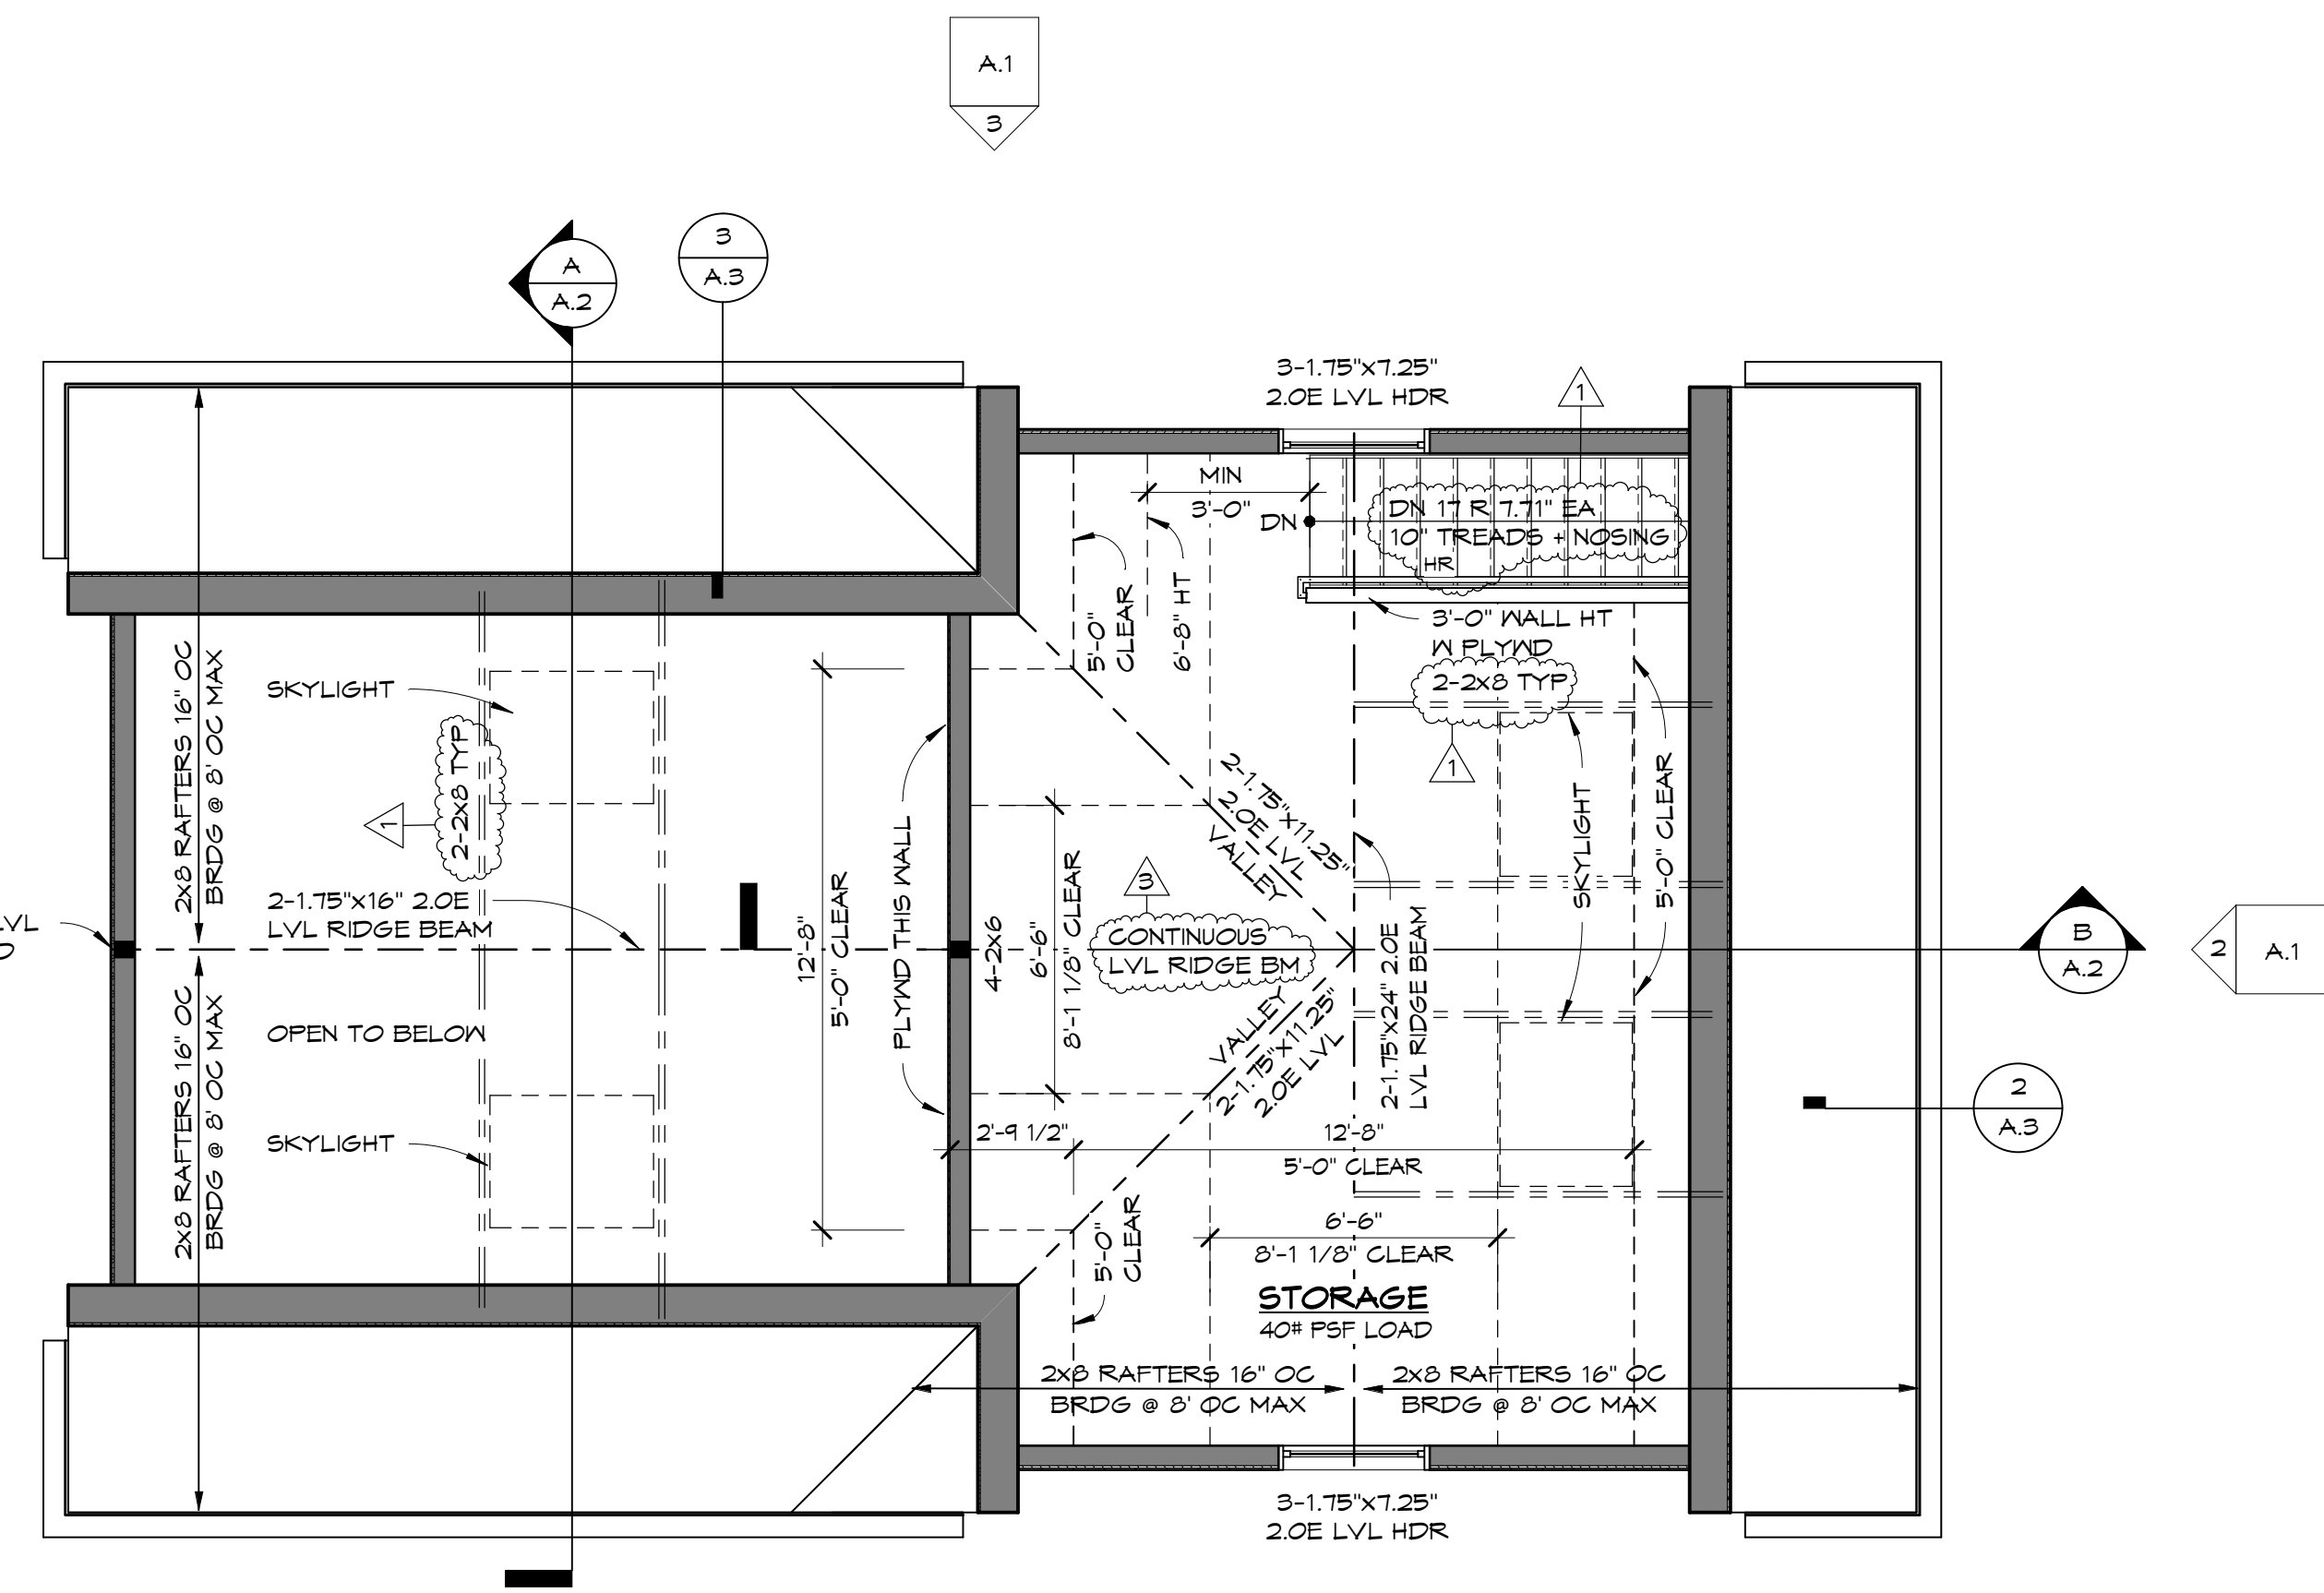


2 SECOND FLOOR PLAN
1/4" = 1'-0"

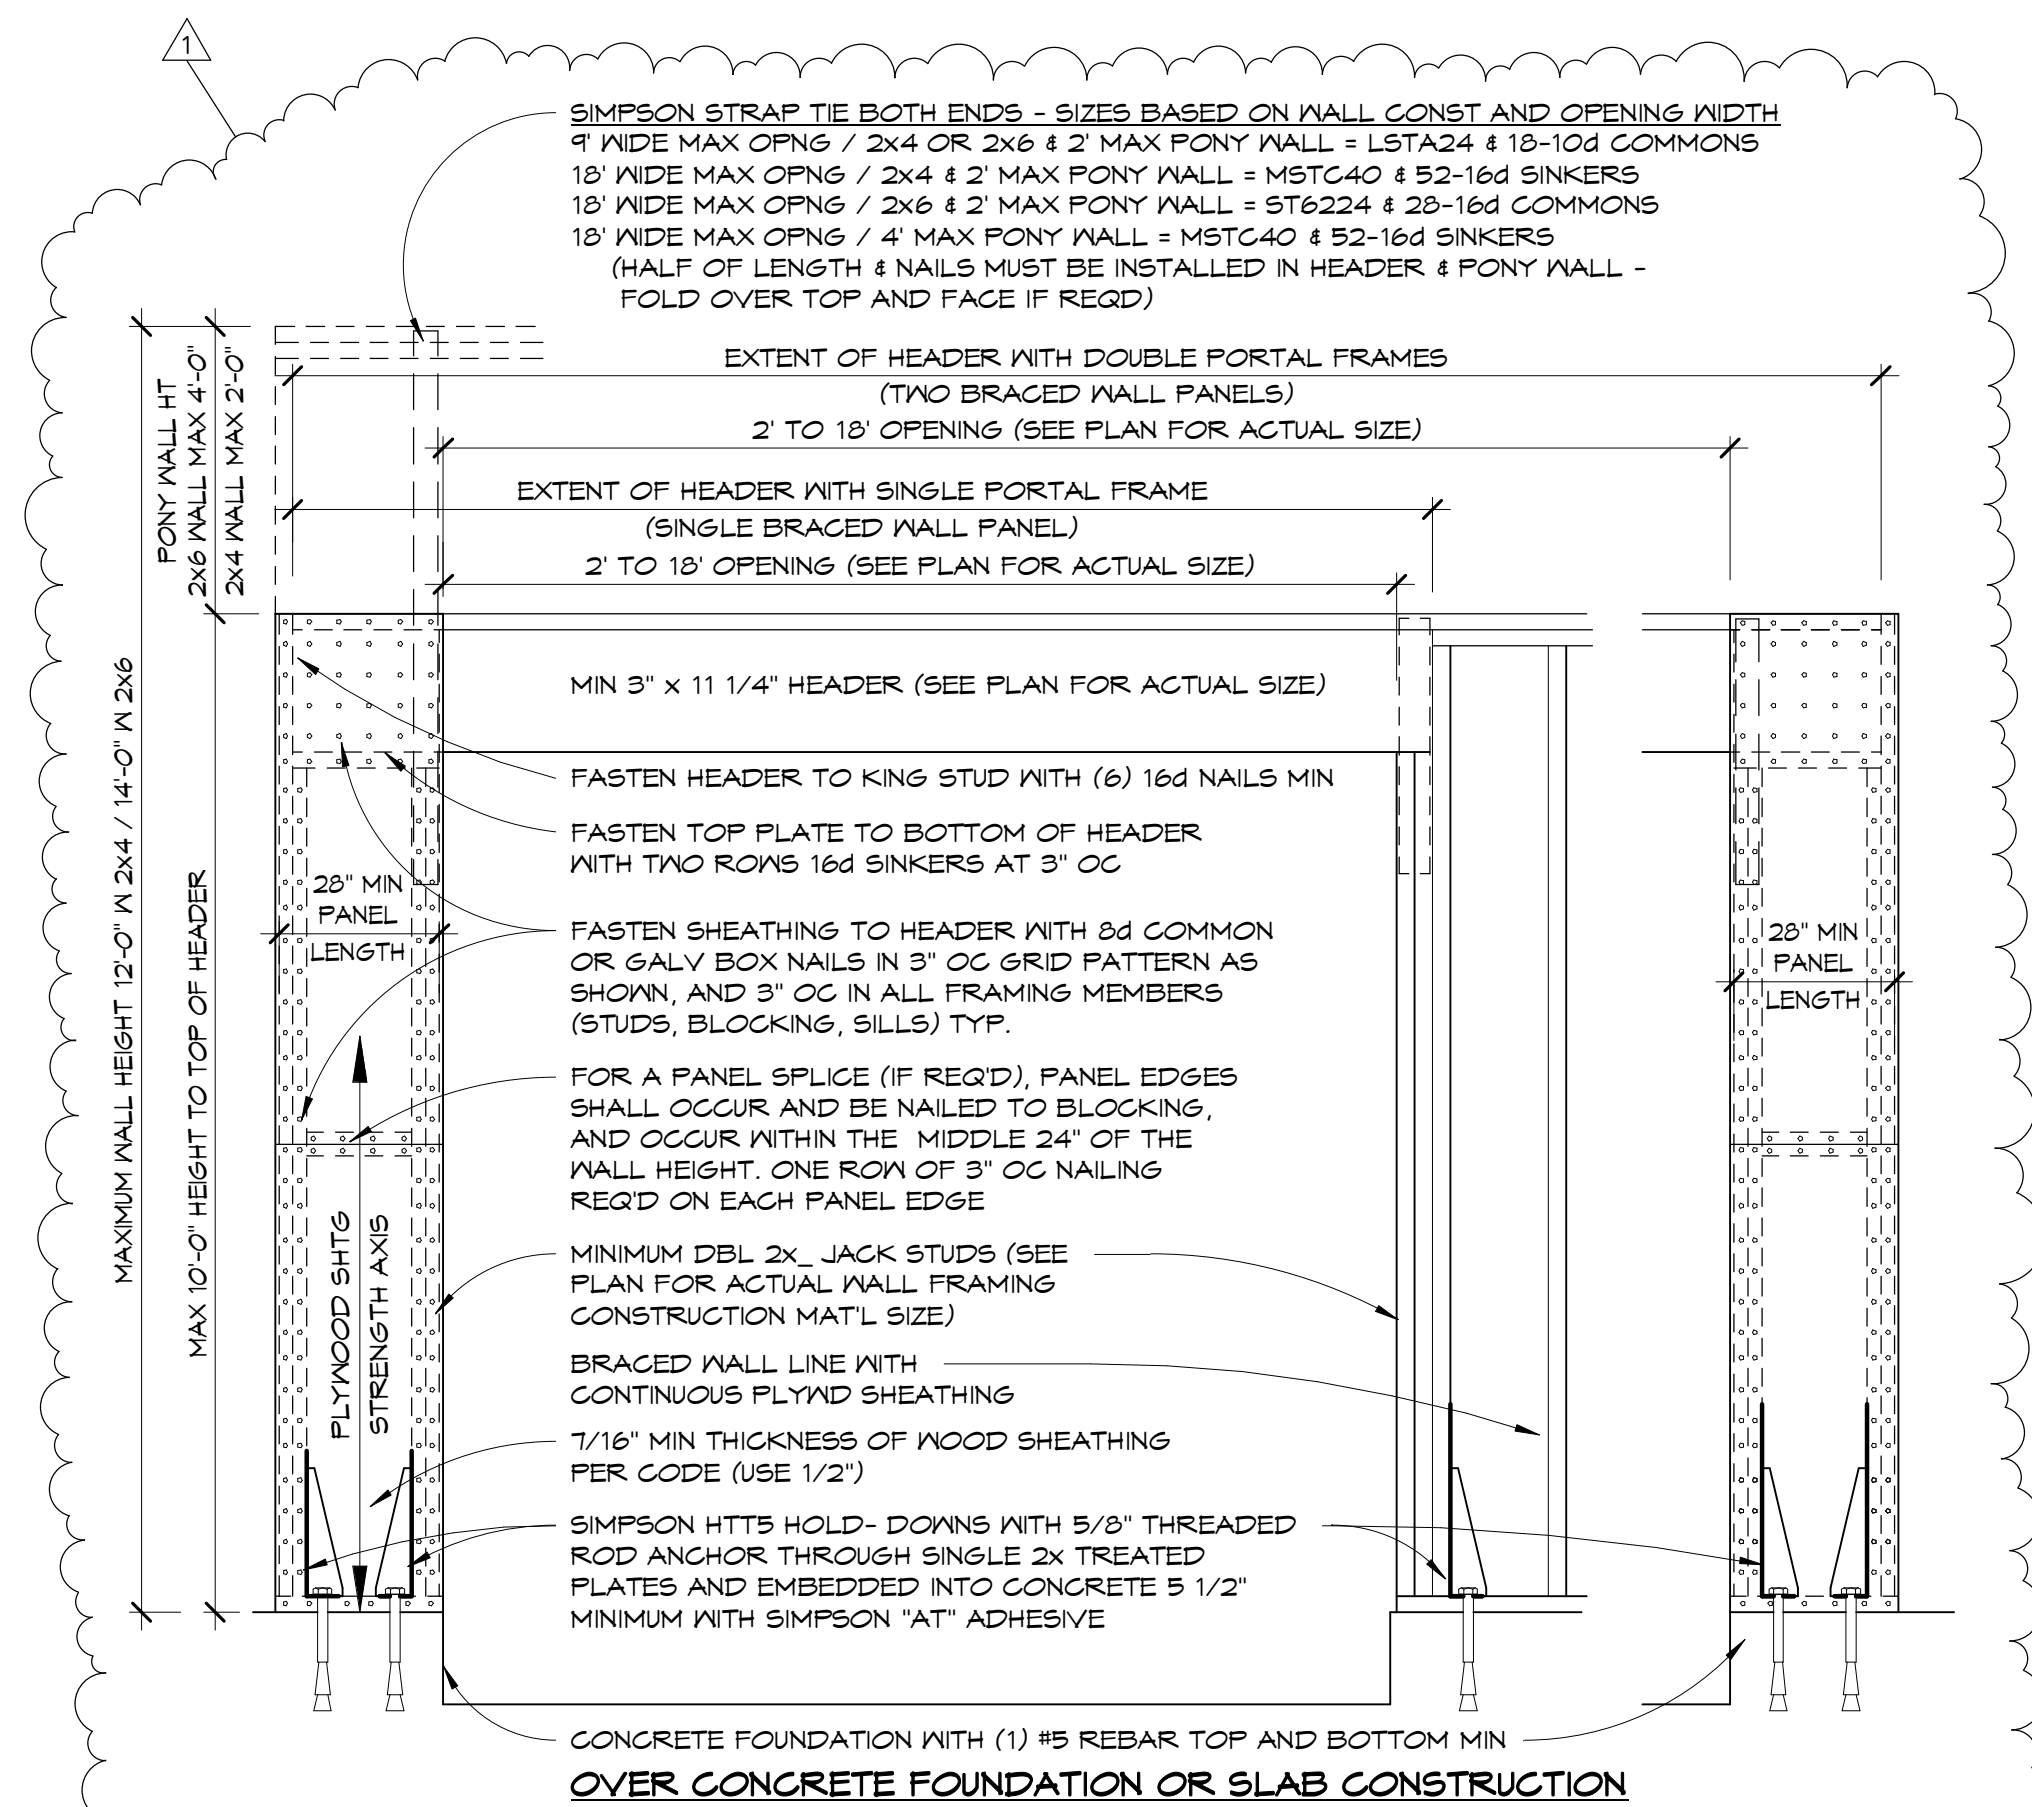

3 PORTAL FRAME DETAIL - CONT SHTG
1" = 1'-0"

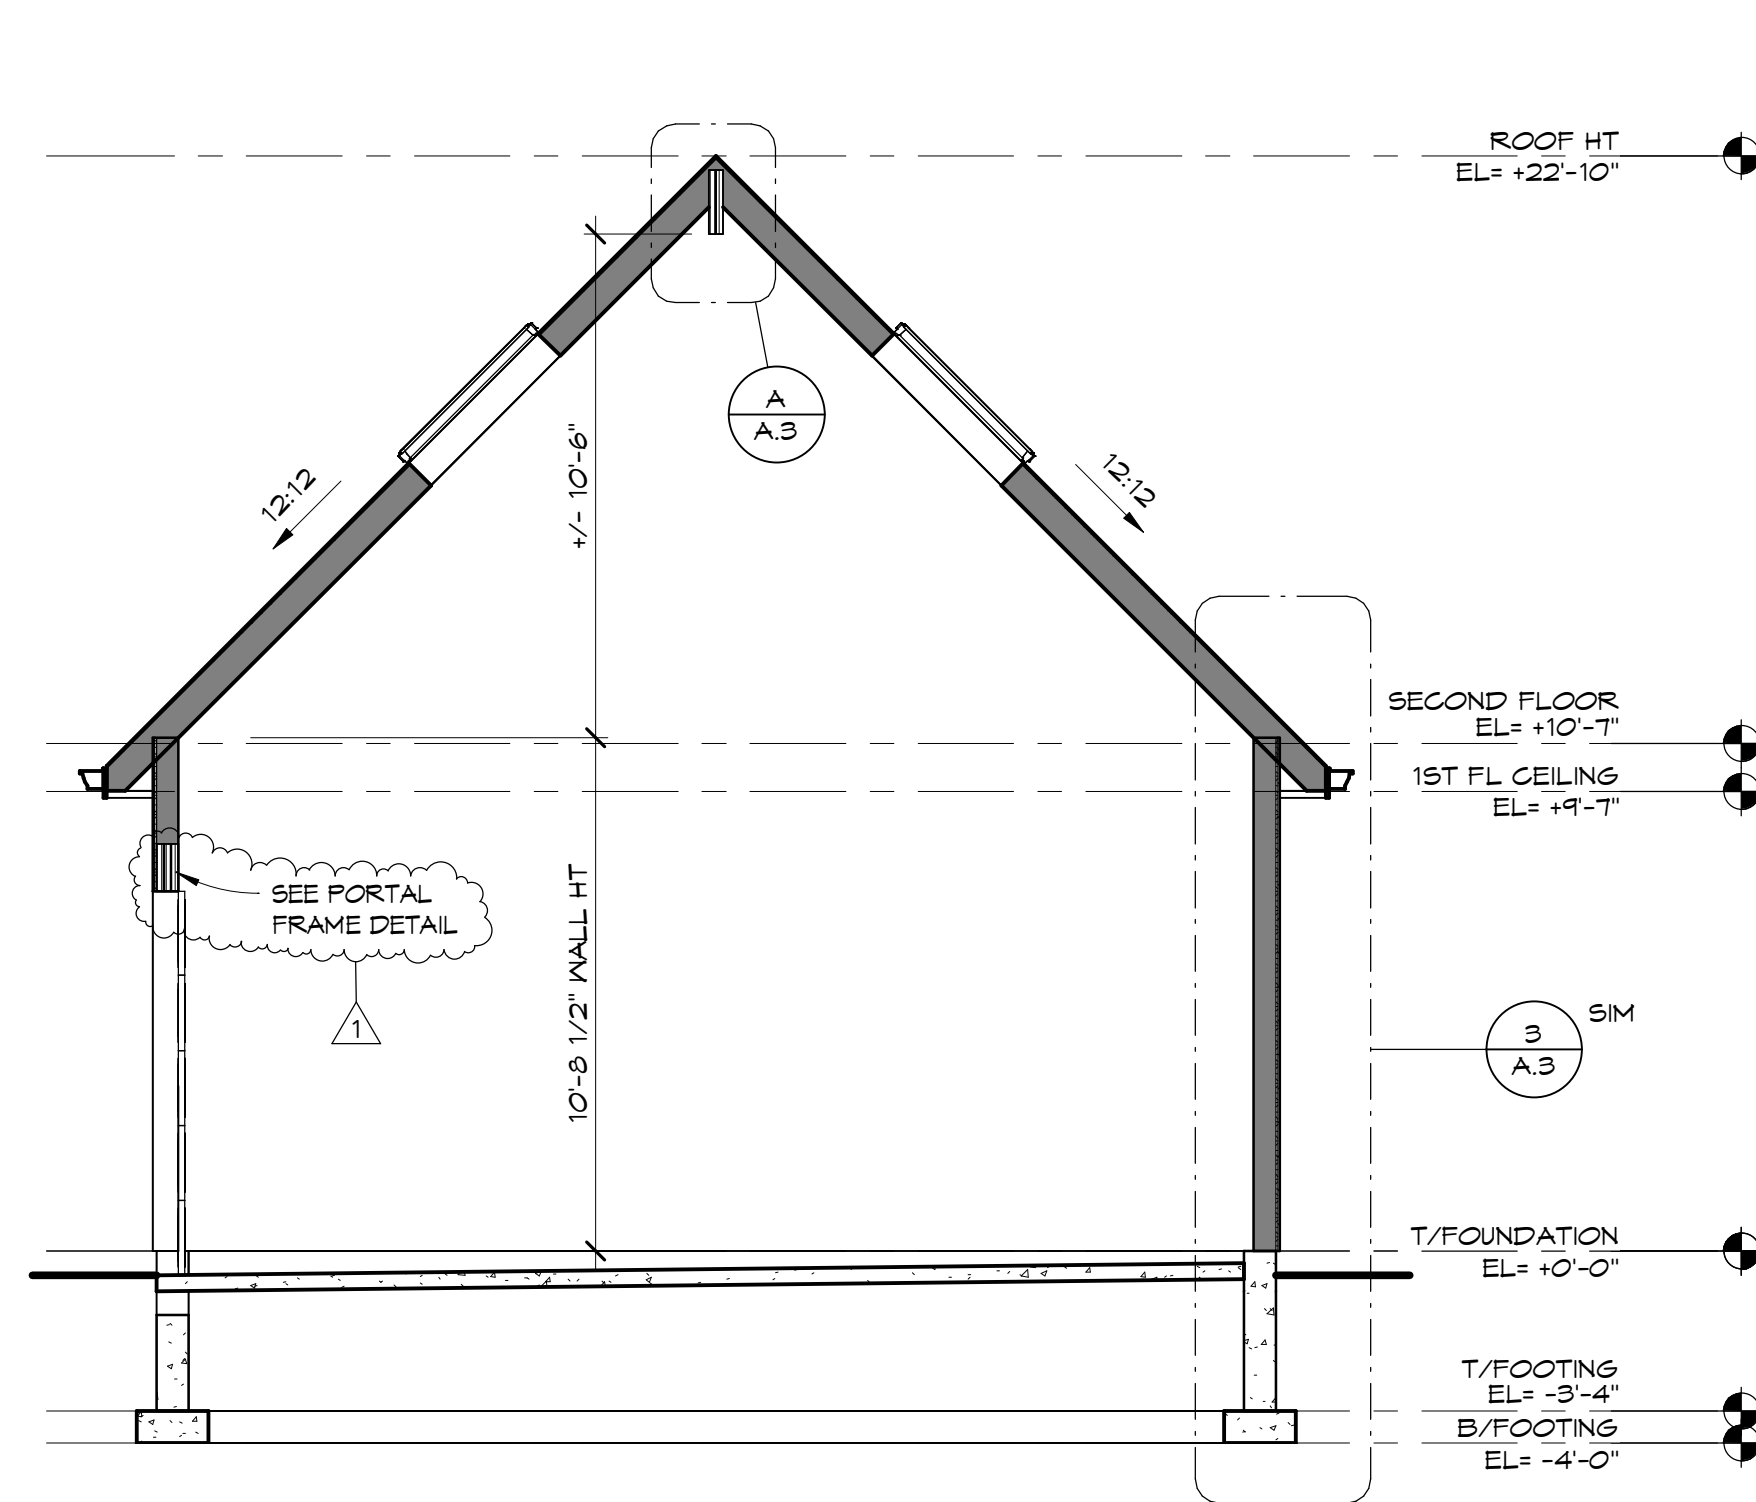

A CROSS SECTION A
1/4" = 1'-0"

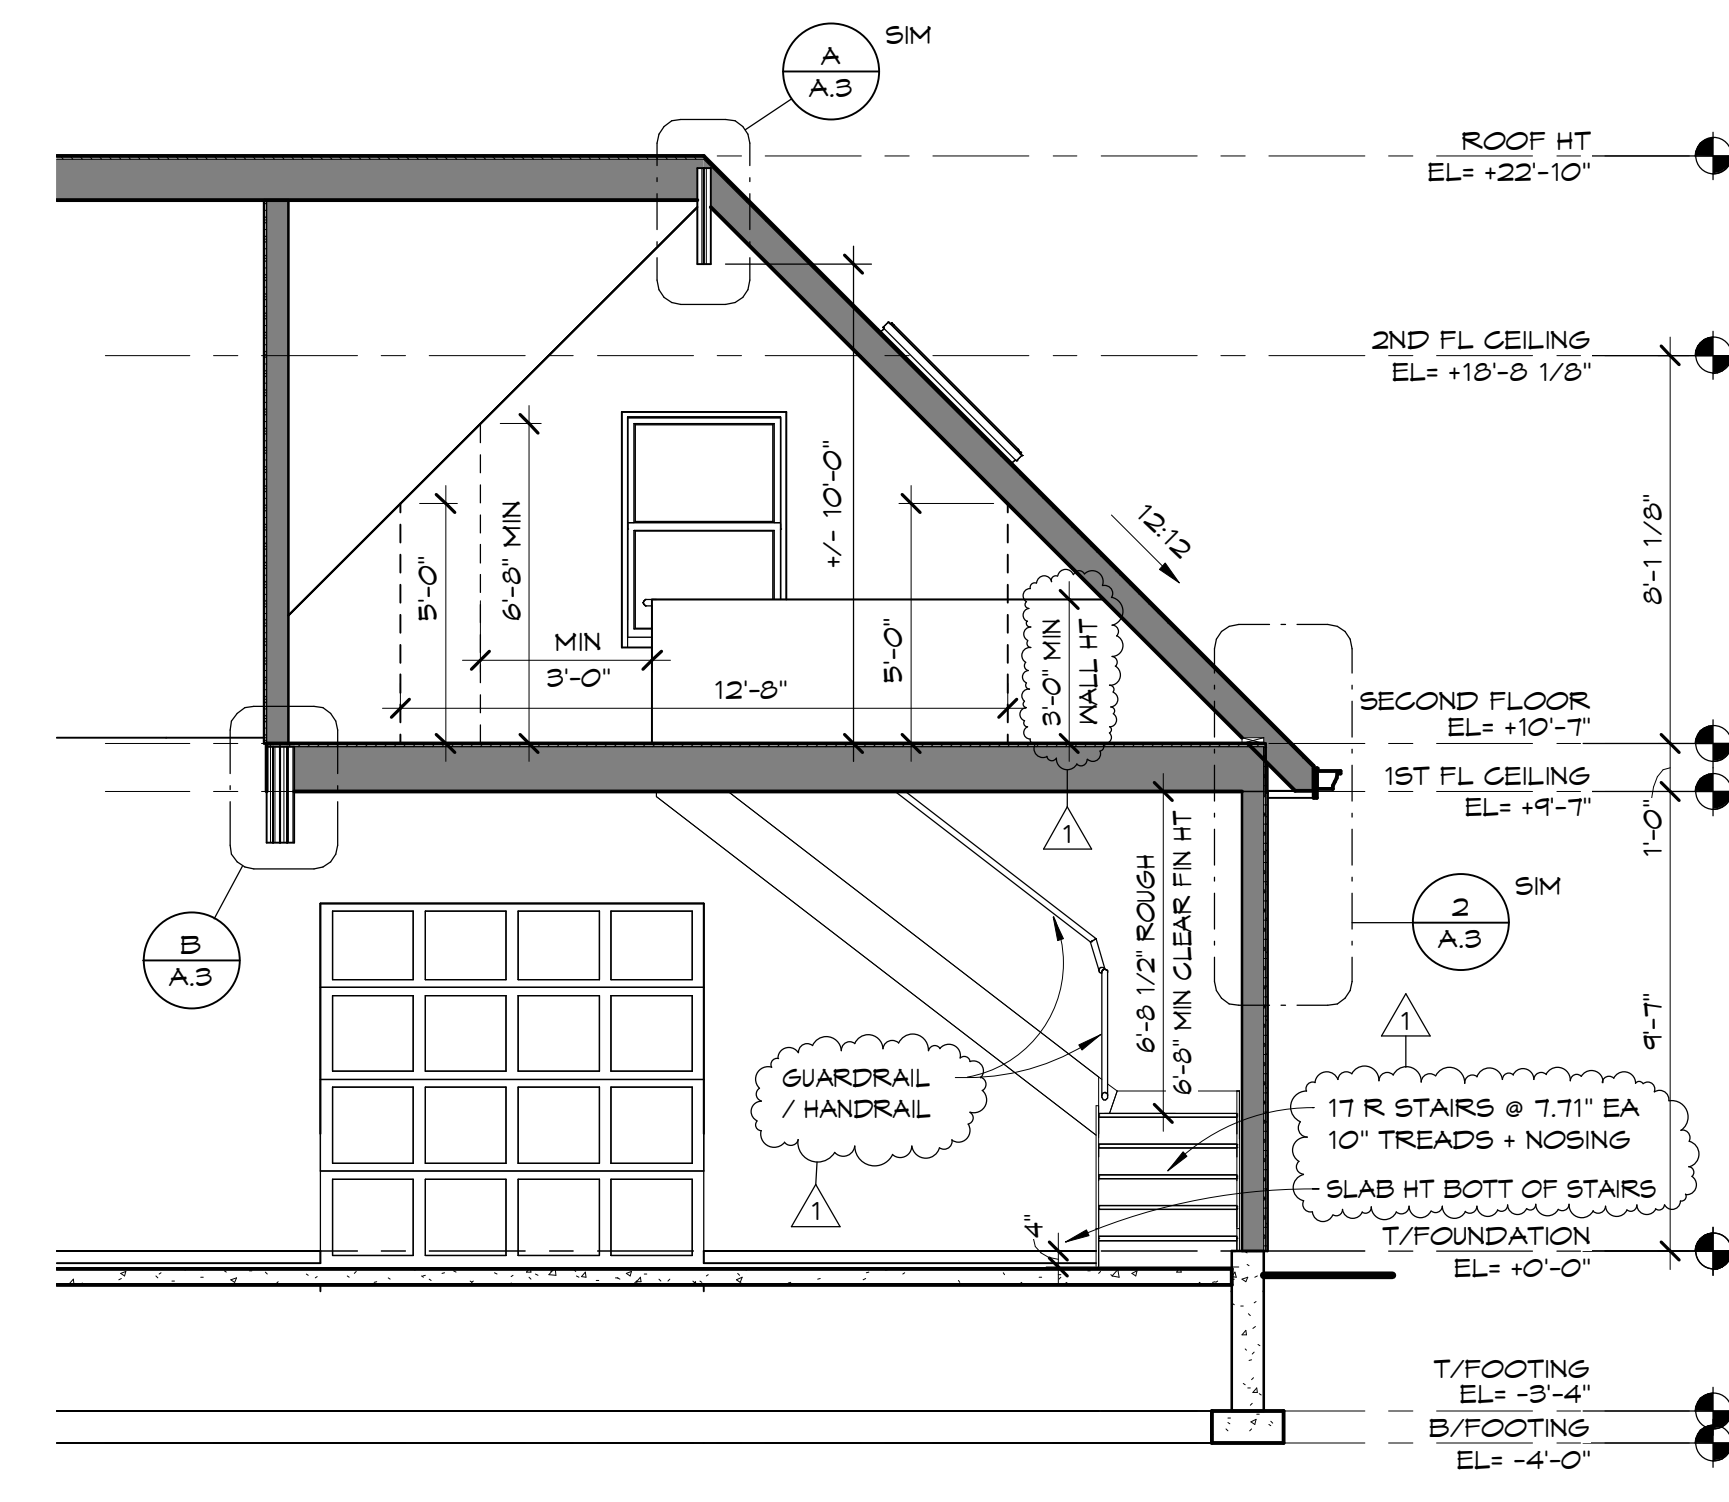

B CROSS SECTION B
1/4" = 1'-0"

EXHIBIT C

LANKENAU
ARCHITECTURE P.C.
Creative designs that endure
1121 CHESHIRE AVENUE
NAPERVILLE, ILLINOIS 60540
630-202-8261
www.lankenau-architecture.com

A DETACHED GARAGE FOR
PAUL AND CLAIRE MERRYWEATHER
516 SPRING AVENUE
NAPERVILLE, ILLINOIS 60540

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REVISION SCHEDULE		
ID	DATE	DESCRIPTION
1	10.03.2024	PERMIT REVISION
2	10.09.2024	PERMIT REVISION
3	10.21.2024	OWNER REVISION

ISSUE DATE 10/23/2024
DRAWN BY PRL
CHECKED BY PRL
PROJECT NUMBER 24002
FLOOR PLANS, FRAMING DETAIL AND SECTIONS

A.2

ISSUED FOR PERMIT REVIEW

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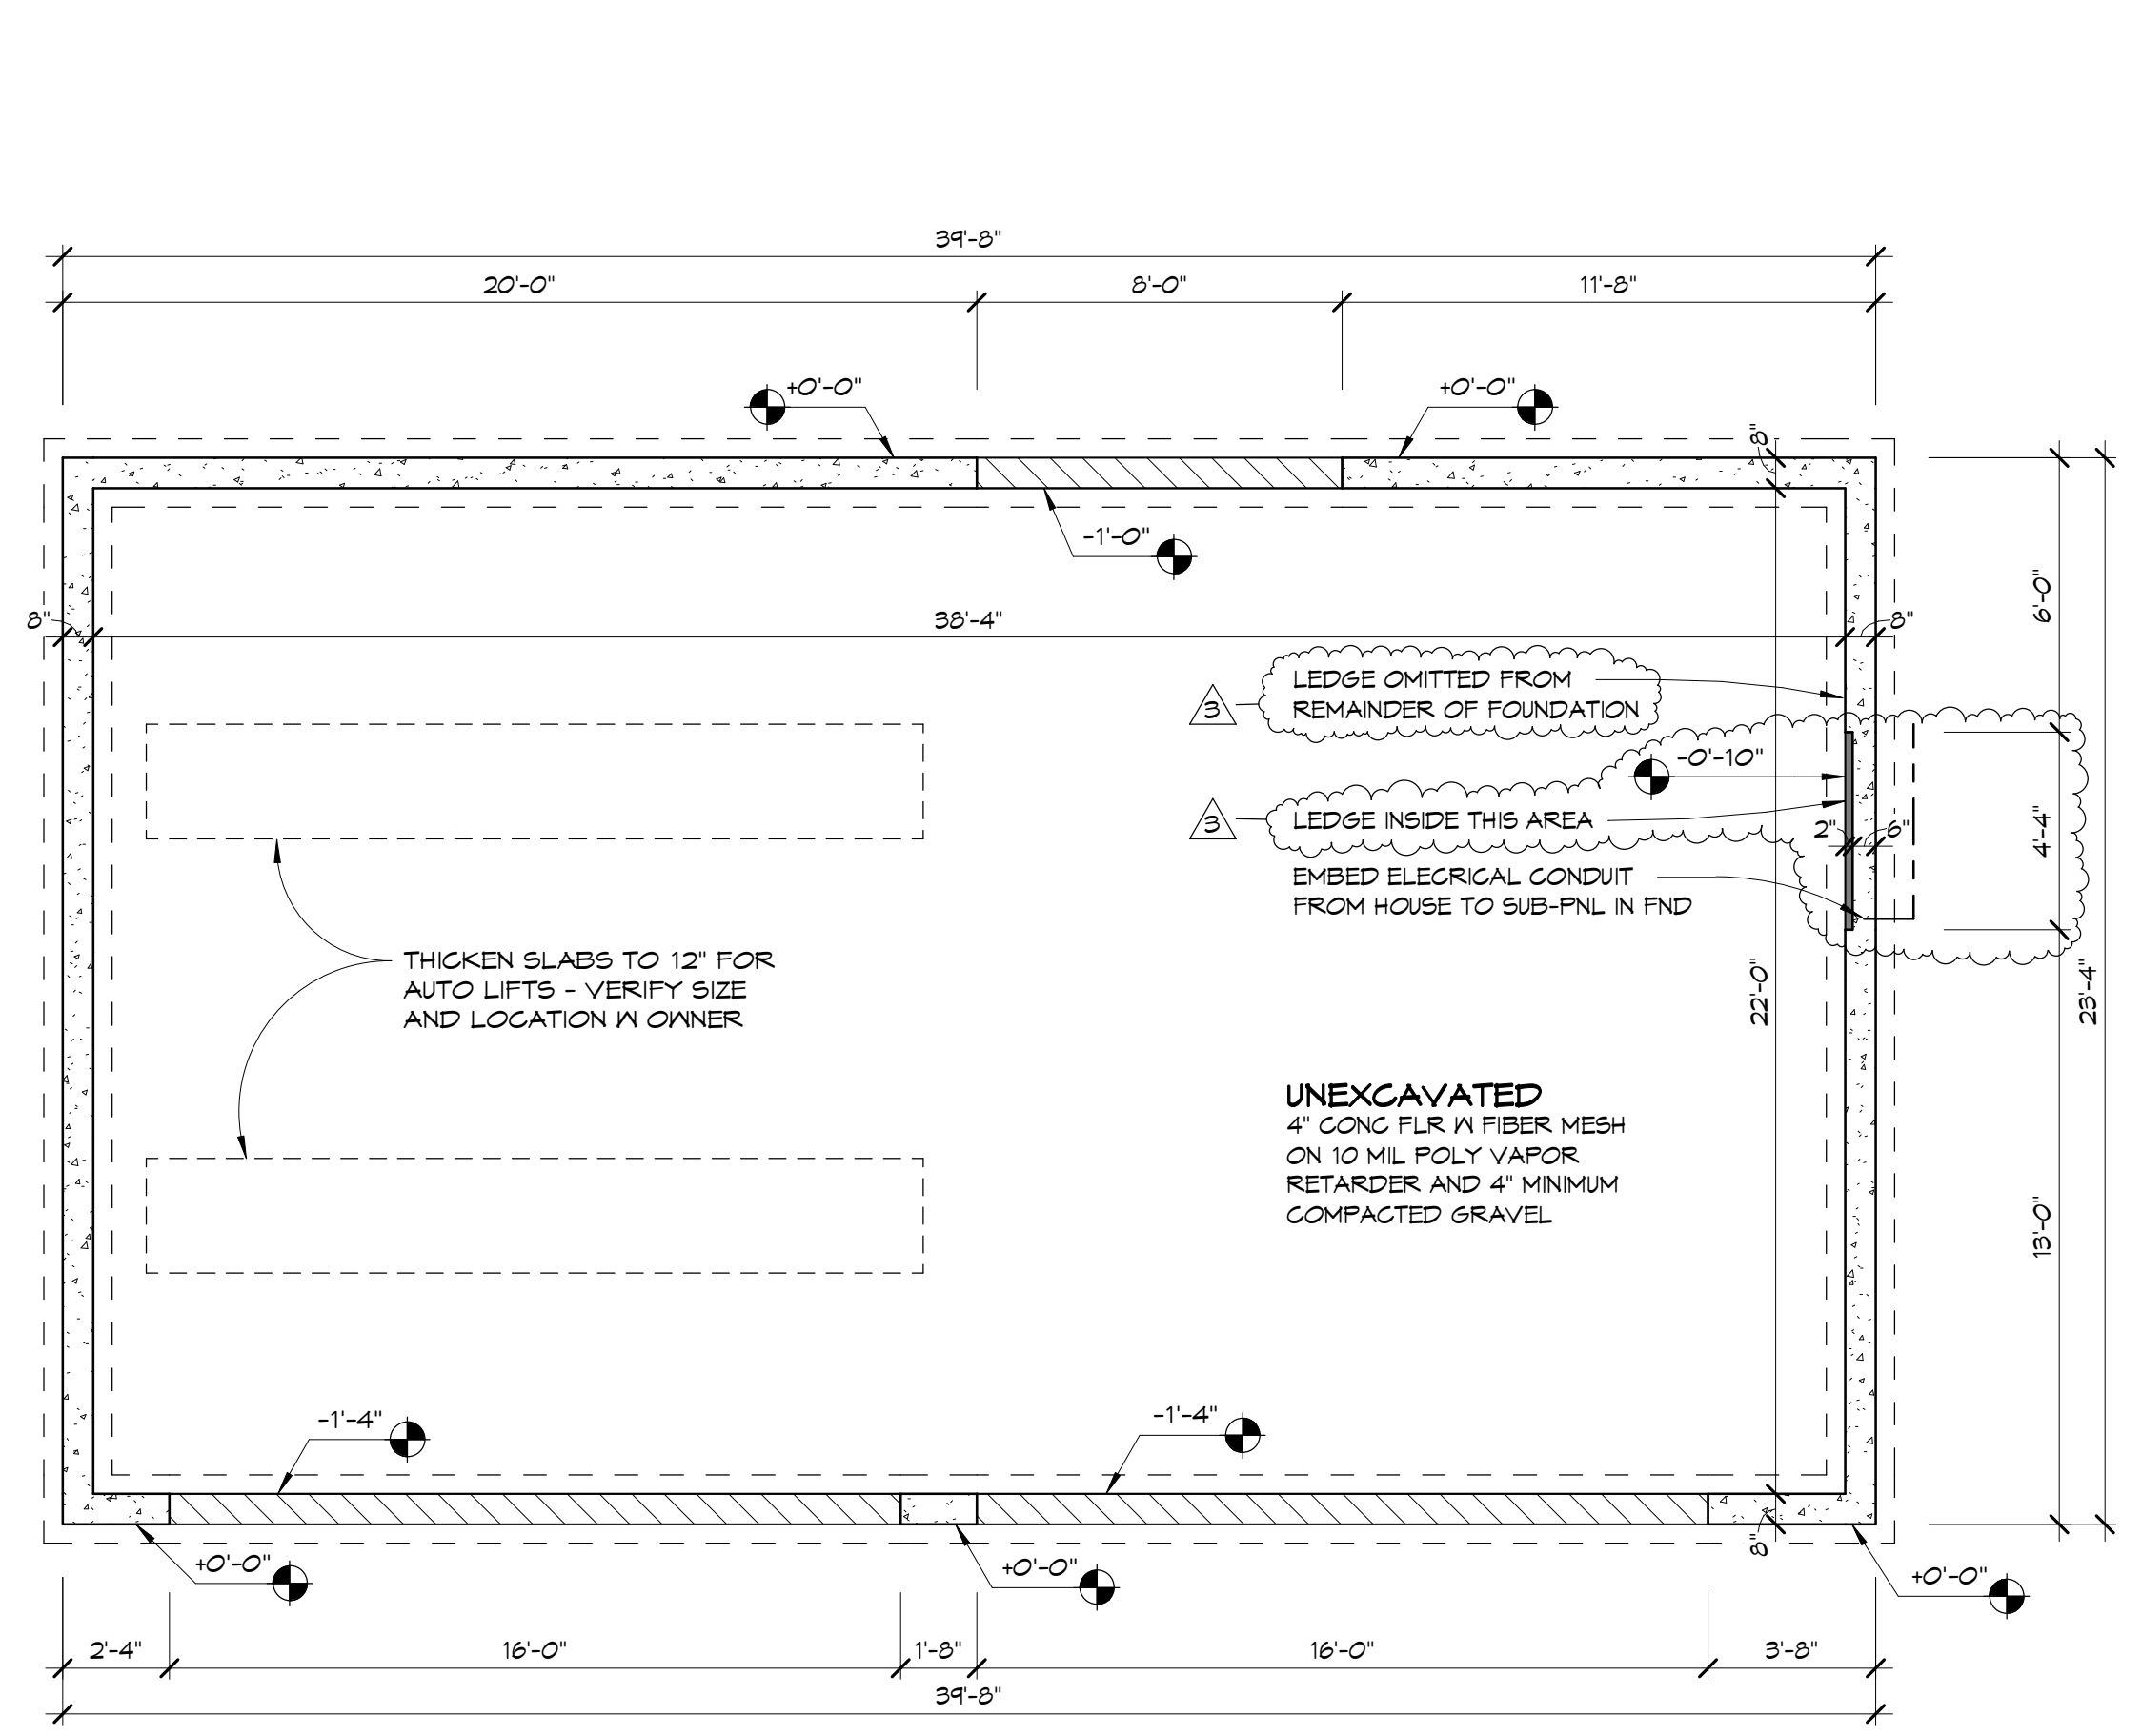


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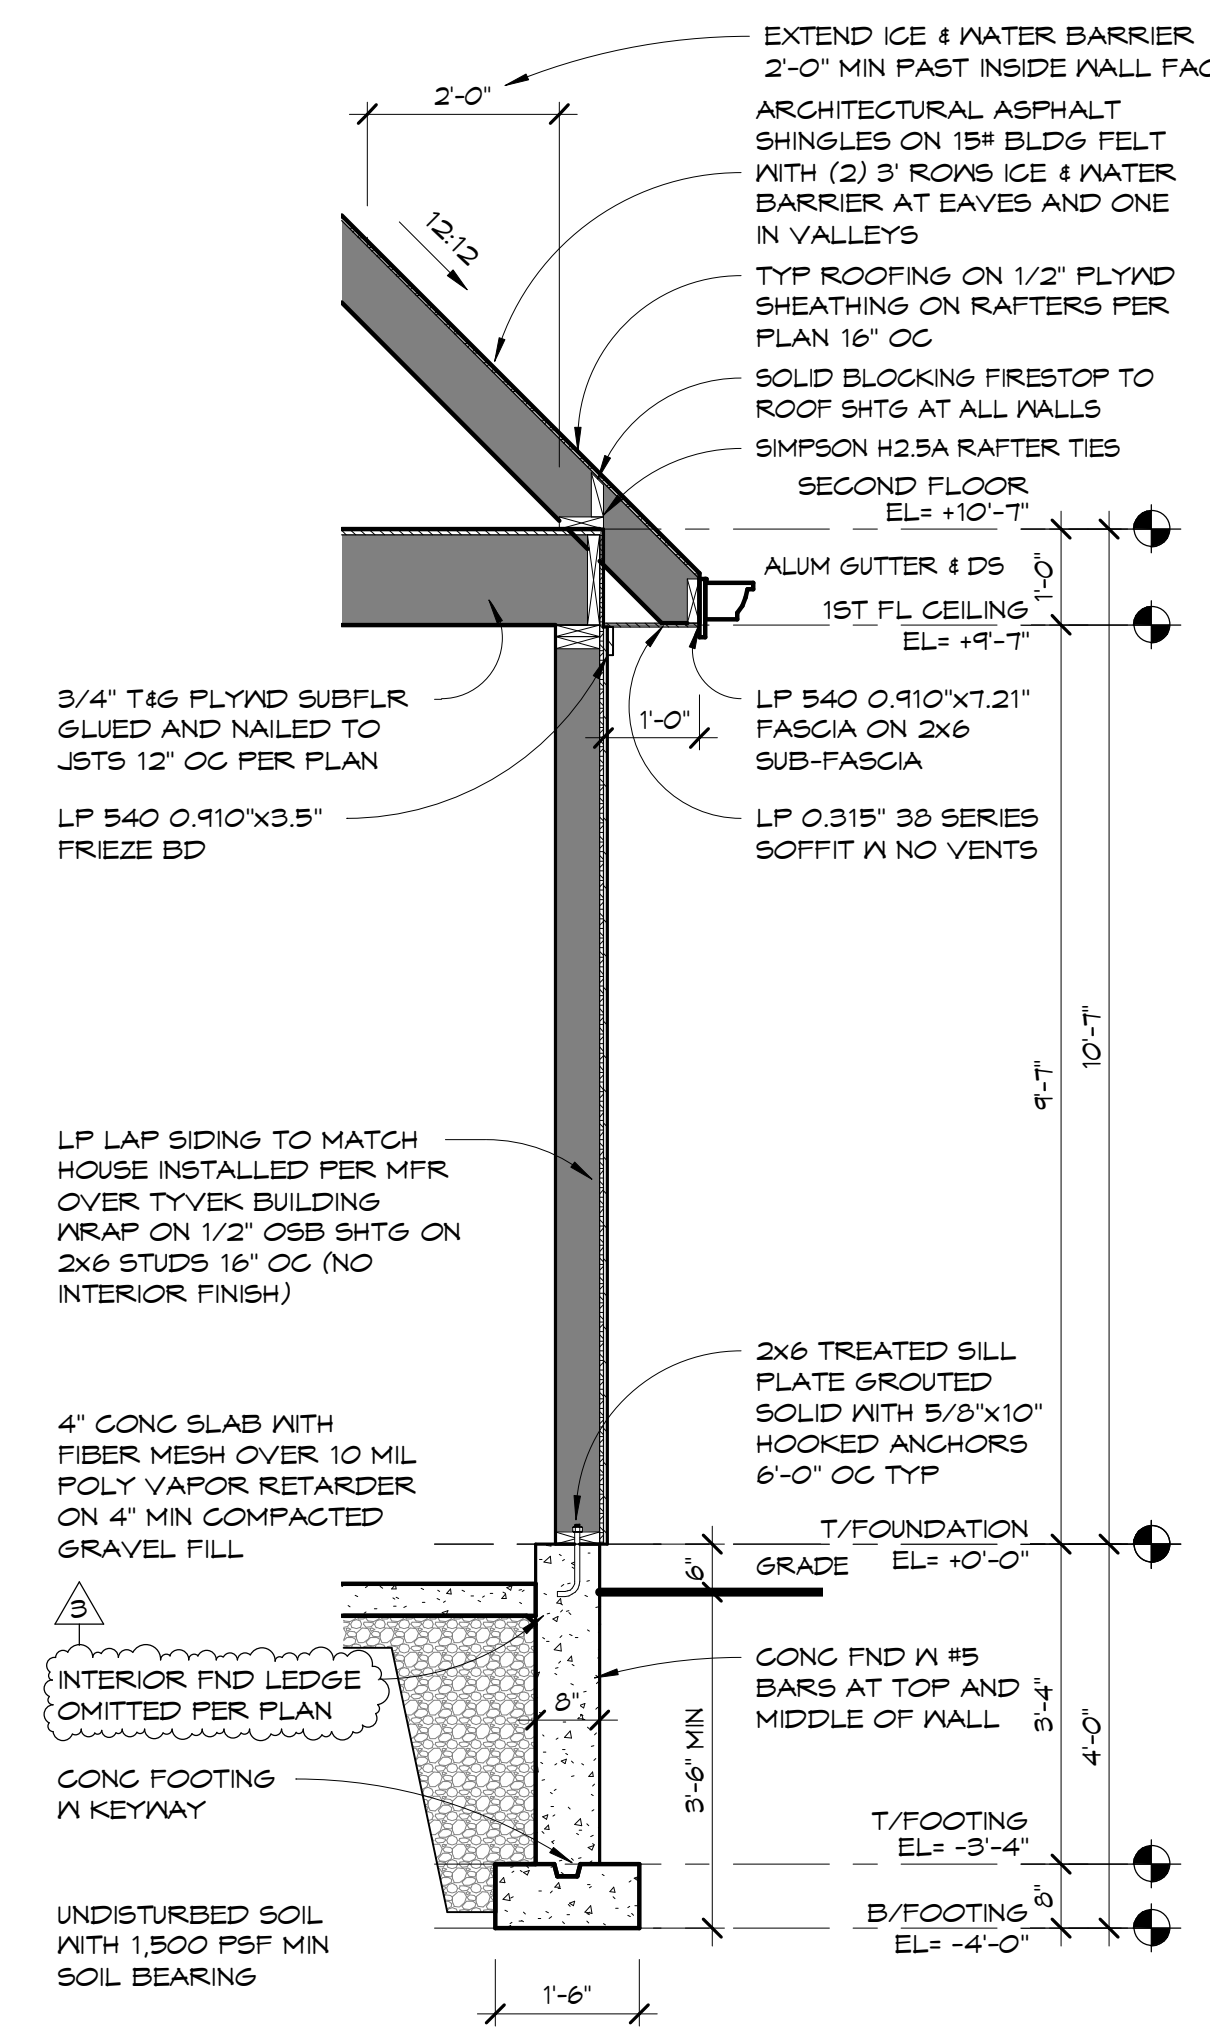
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REVISION SCHEDULE		
ID	DATE	DESCRIPTION
1	10.03.2024	PERMIT REVISION
3	10.21.2024	OWNER REVISION


ISSUE DATE	10/23/2024
DRAWN BY	PRL
CHECKED BY	PRL
PROJECT NUMBER	24002
SECTIONS, FOUNDATION & ELECTRICAL PLANS	
A.3	



1 FOUNDATION PLAN
 1/4" = 1'-0"




2 TYPICAL WALL SECTION
 1/2" = 1'-0"

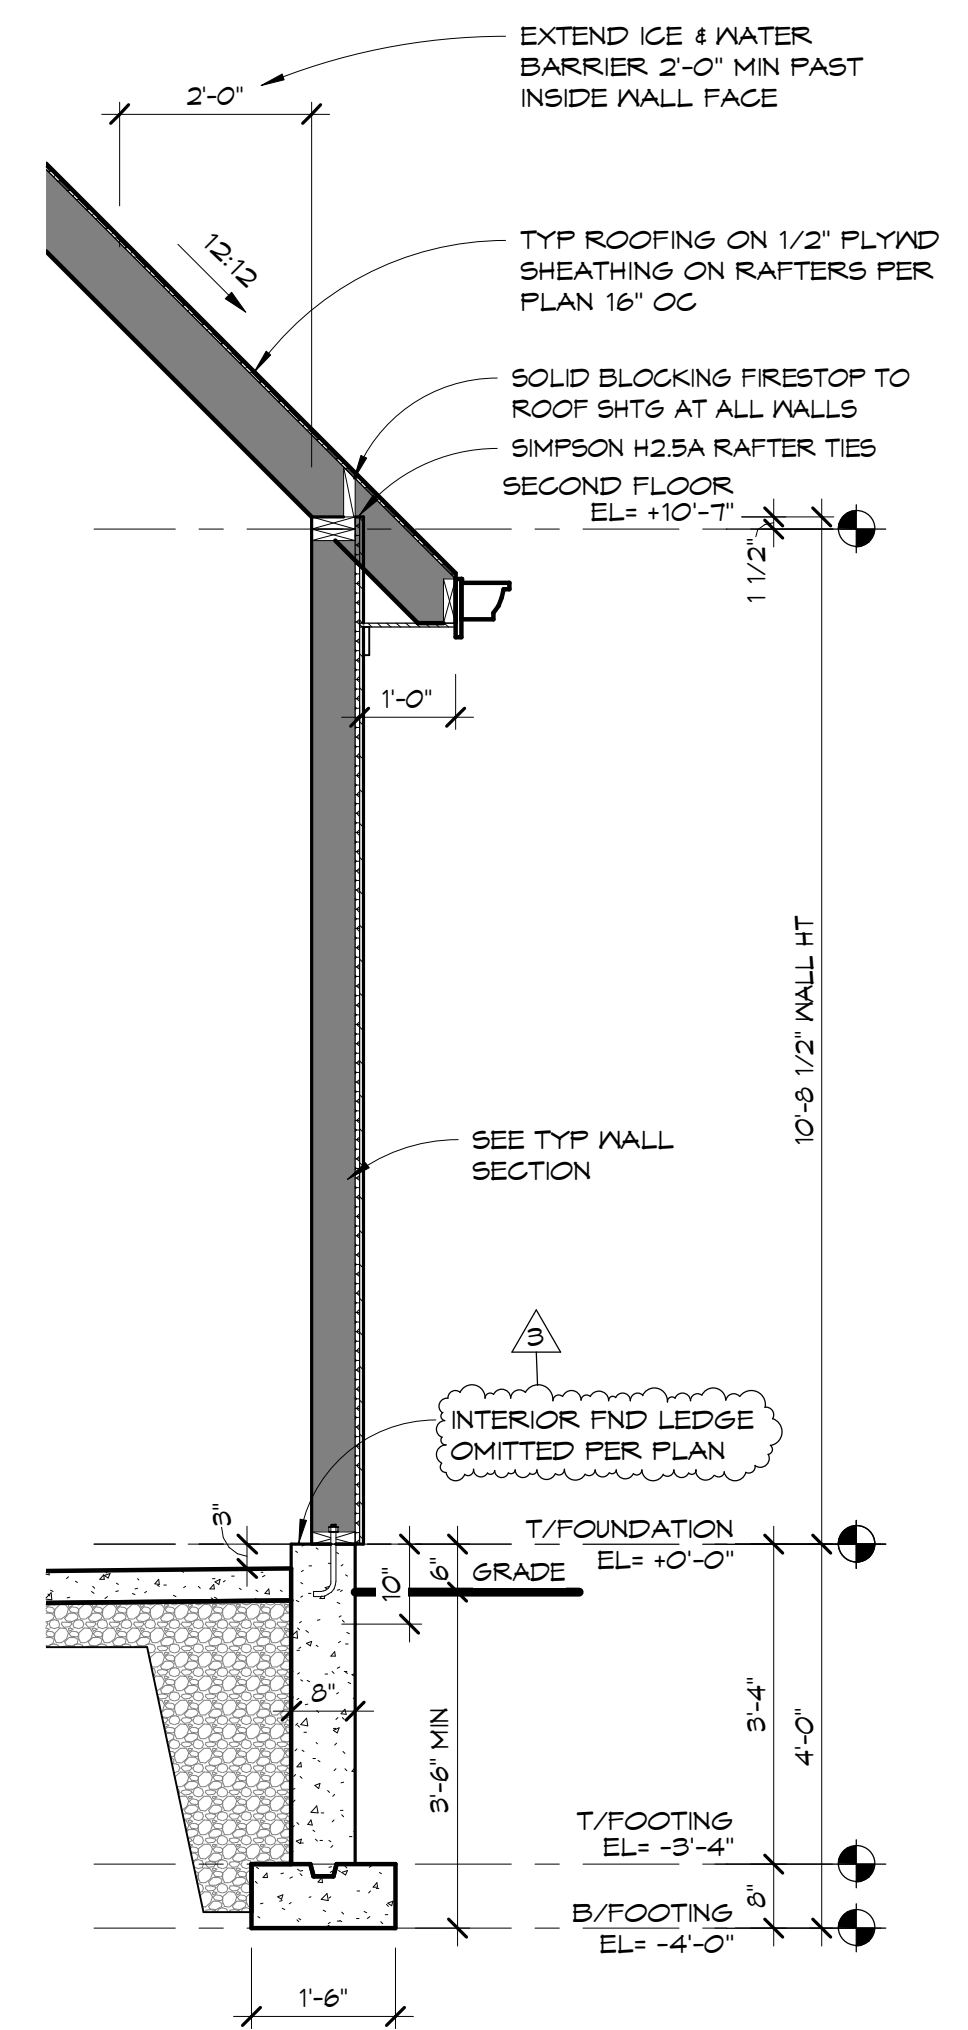


3 WALL AT VAULTED CEIL
 1/2" = 1'-0"


A RIDGE DETAIL
 3/4" = 1'-0"

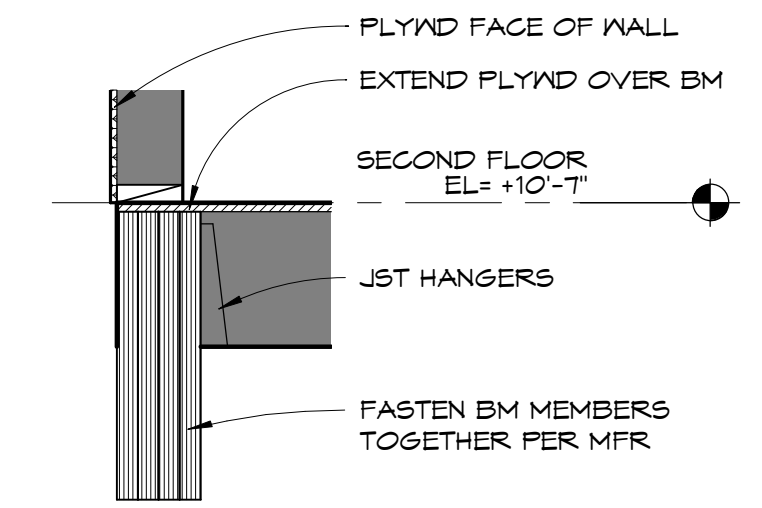


B BEAM DETAIL
 3/4" = 1'-0"

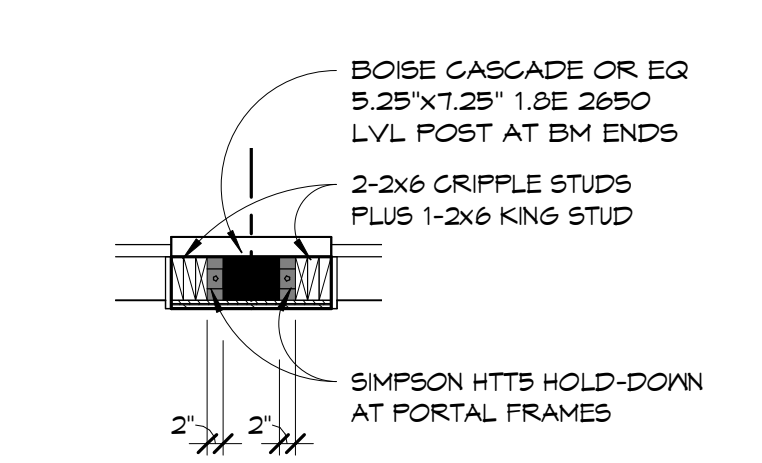

C PLAN DETAIL
 1/2" = 1'-0"

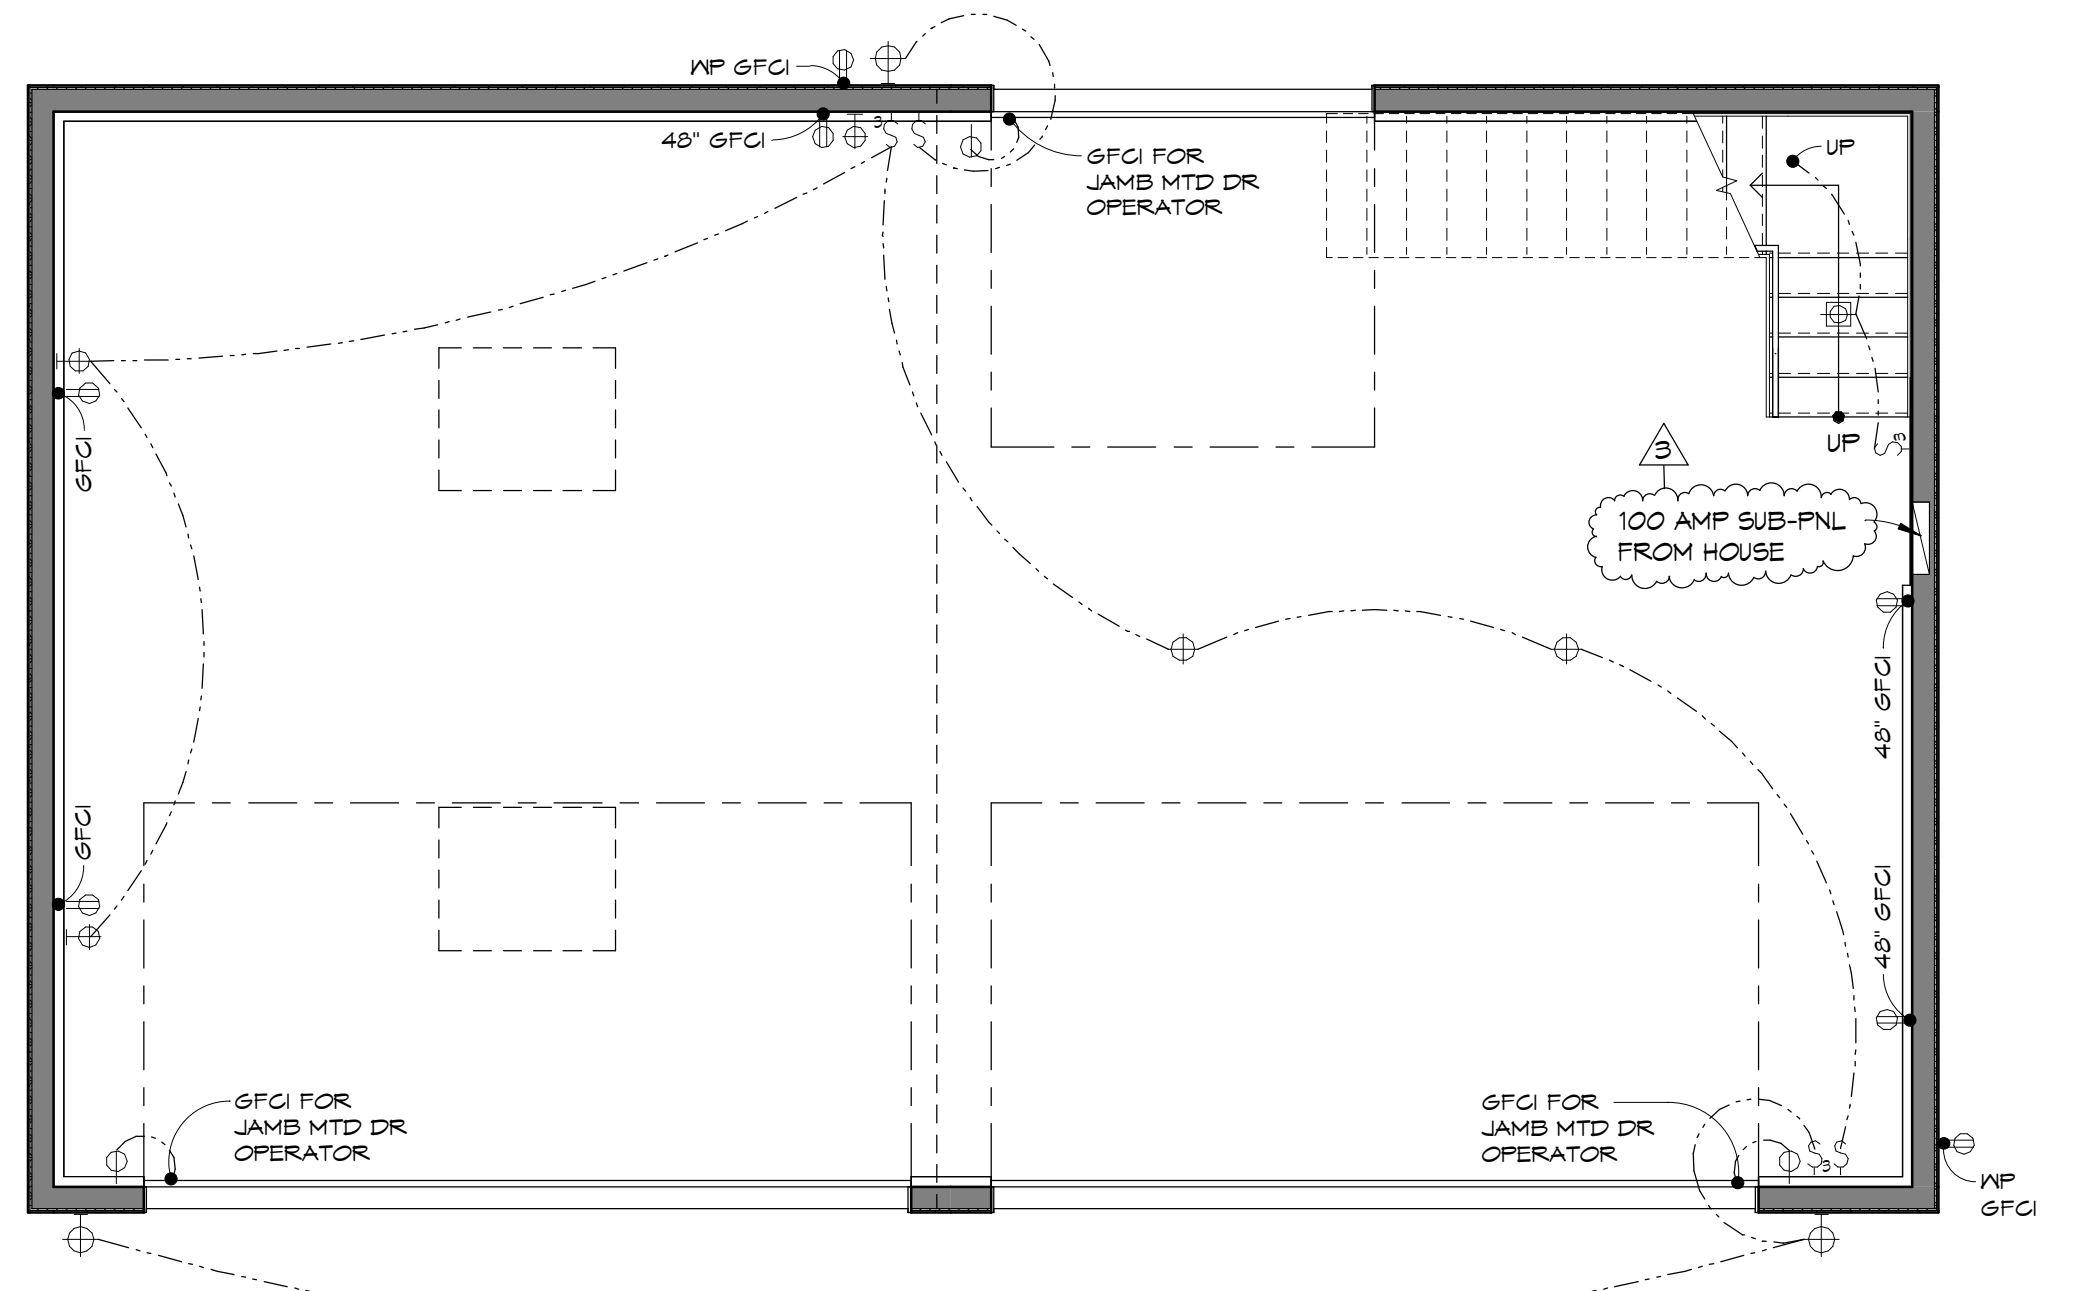

4 FIRST FLOOR ELECTRICAL PLAN
 1/4" = 1'-0"

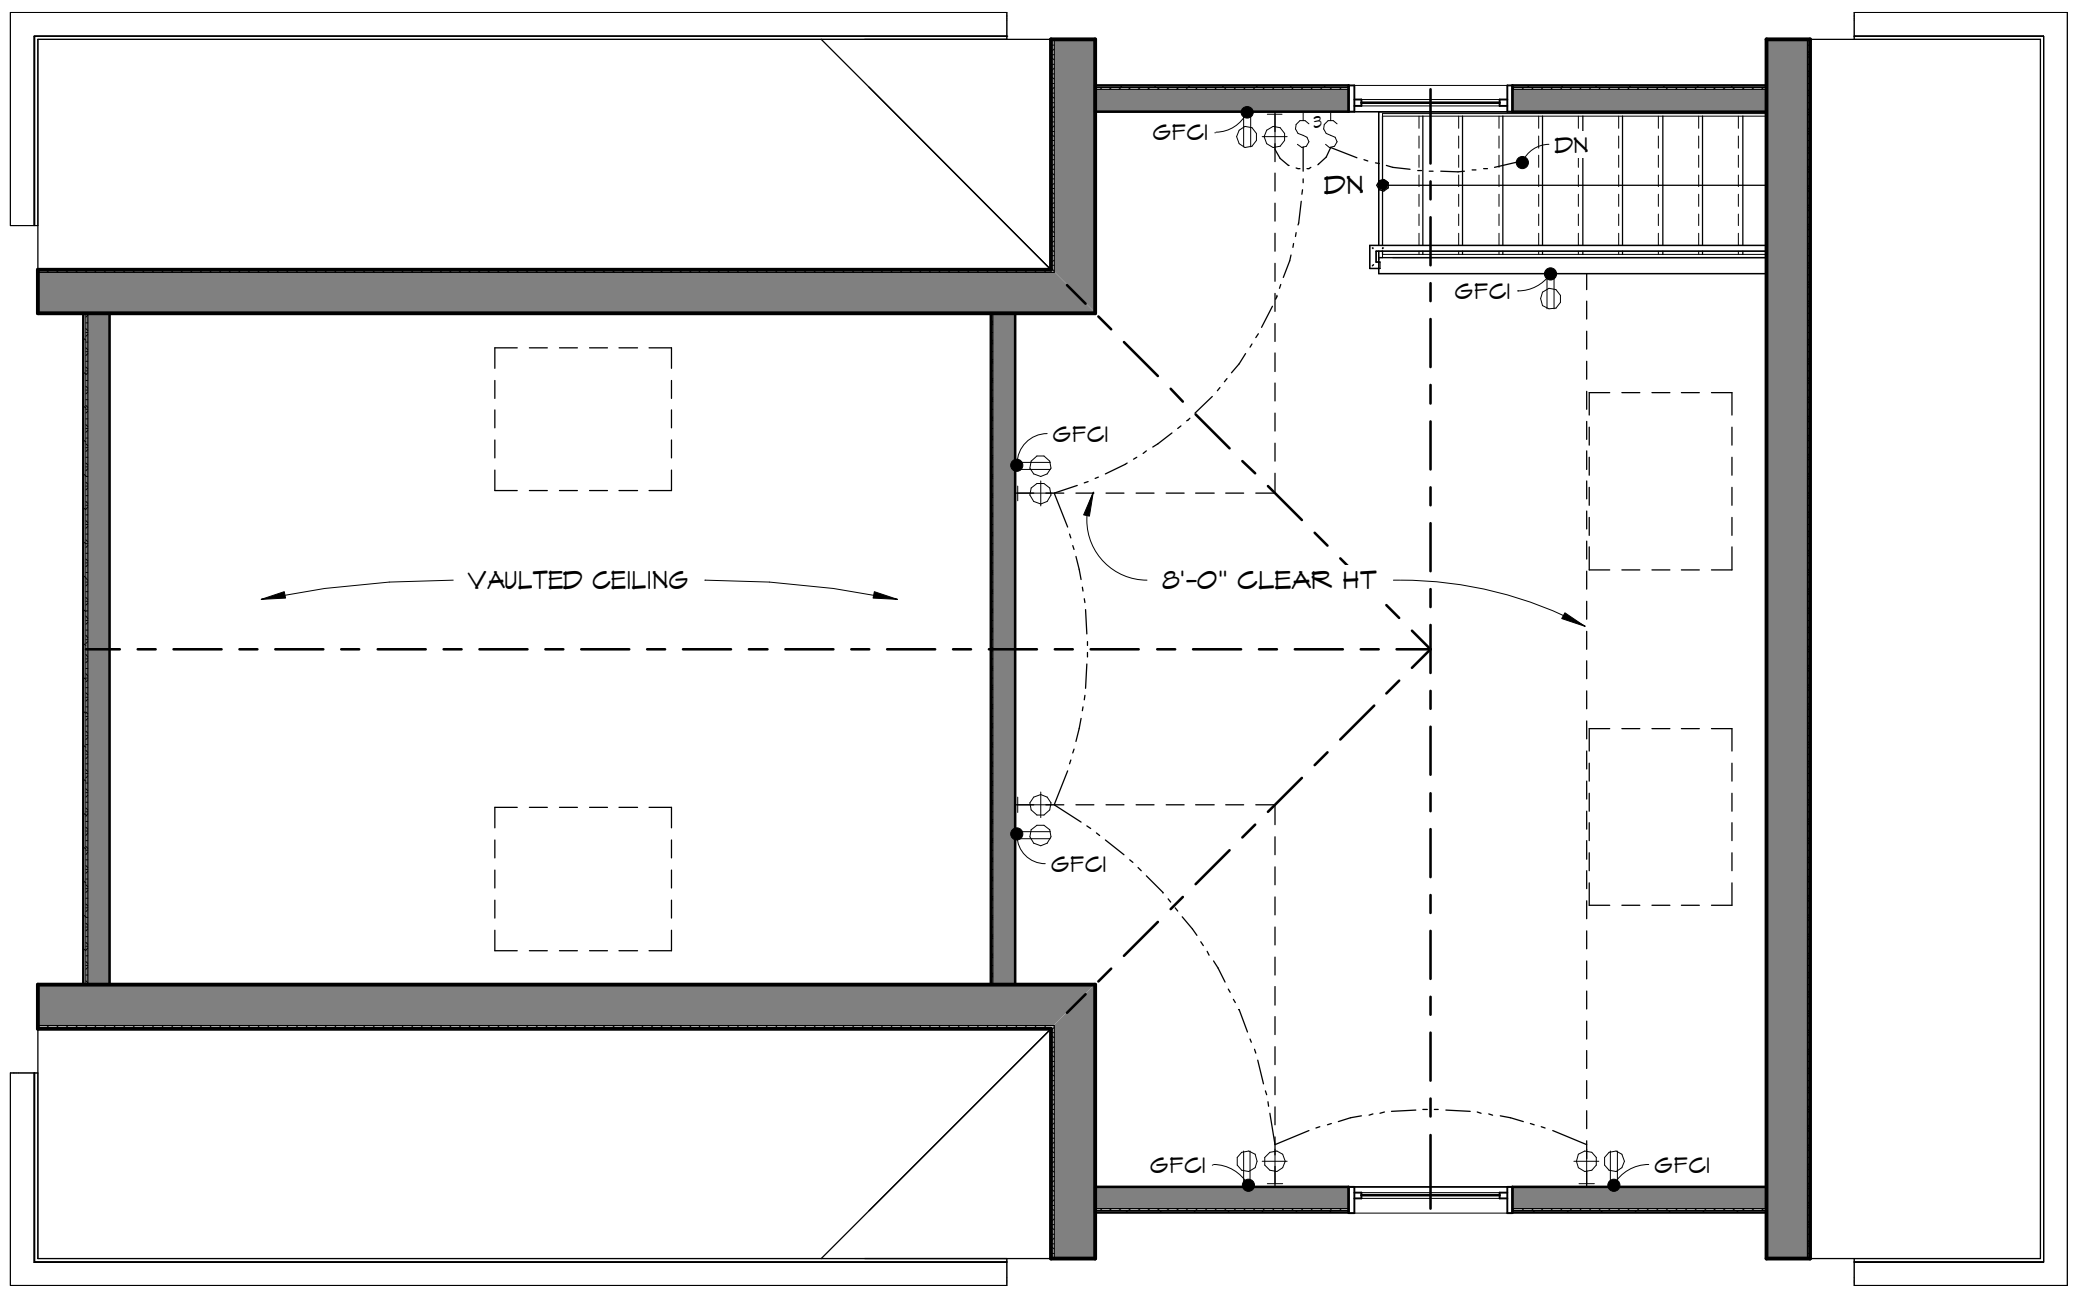

5 SECOND FLOOR ELECTRICAL PLAN
 1/4" = 1'-0"

- ELECTRICAL NOTES:**
- GROUND-FAULT CIRCUIT-INTERRUPTER (GFCI) PROTECTION SHALL BE INSTALLED ON ALL OUTLETS AT KITCHEN, LAUNDRY AND BAR COUNTERS, IN BATHROOMS, AT SPAS OR WHIRLPOOL TUBS, UNFINISHED BASEMENT AREAS, CRAWL SPACES, GARAGES, ELECTRICALLY HEATED FLOORS, AND EXPOSED TO THE EXTERIOR, AND ALL EXTERIOR OUTLETS SHALL INCLUDE IN-USE WATERPROOF COVERS.
 - ARC-FAULT CIRCUIT-INTERRUPTERS (AFCI) SHALL BE INSTALLED ON ALL CIRCUITS WITH 120V OUTLETS IN FAMILY ROOMS, DINING ROOMS, LIVING ROOMS, PARLORS, LIBRARIES, DEN, STUDY, BEDROOMS, SUNROOMS, RECREATION ROOMS, CLOSETS, HALLS, AND SIMILAR ROOMS OR AREAS.
 - TAMPER-RESISTANT LISTED NON-LOCKING 15 AND 20 AMP, 125 AND 250 VOLT RECEPTACLES TO BE USED IN ALL AREAS SPECIFIED IN 409.12(1) THRU (8) IN DWELLING UNITS INCLUDING ATTACHED GARAGES.
 - 100% OF ALL PERMANENTLY INSTALLED LIGHTING FIXTURES SHALL UTILIZE HIGH EFFICACY LAMPS PER THE 2021 IECC ENERGY CODE.
 - LICENSED ELECTRICAL CONTRACTOR TO BE RESPONSIBLE FOR LOAD CALCULATION, CIRCUITING, WIRE SIZING, LOAD BALANCING AND GROUNDING TO MEET CODE. ALL WIRING TO BE COPPER IN THIN-WALL METAL CONDUIT. ALL GARAGE CIRCUITS TO BE 20 AMP CIRCUITS.

ELECTRICAL SYMBOL LEGEND

	ELEC PANEL (RECESS IN FRAME WALLS)
	SWITCH
	SWITCH THREE-WAY
	DUPLEX OUTLET (MAY BE GFCI OR AFCI PROTECTED)
	DUPLEX OUTLET SWITCHED ON ONE SIDE
	220V OUTLET
	DEDICATED EQUIPMENT OUTLET
	DUPLEX CEILING OUTLET
	DUPLEX FLOOR OUTLET
	CEILING OPENING FOR DECORATIVE FIXTURE
	CEILING OPENING FOR DECORATIVE FAN
	FULL CHAIN PORCELAIN CEILING FIXTURE
	RECESSED CEILING FIXTURE
	WALL OPENING FOR DECORATIVE FIXTURE

EXHIBIT C

ENTIRE SHEET ADDED