

Insite RE, Inc. 1s660 Midwest Road Suite 140 Oakbrook Terrace, IL 60181

April 7, 2017

Via electronic transmittal schatzm@naperville.il.us wilder@naperville.il.us

Mr. Doug A. Krieger Naperville City Manager 400 S. Eagle Street Naperville, IL 60540

RE: Verizon Small Cell license agreement for City pole located at 485 Diehl Road

Dear Mr. Krieger,

Chicago SMSA L.P., aka Verizon Wireless ("Applicant") requests to address the city council regarding a license agreement on a city owned light pole referenced above for the installation of a Verizon Small Cell. Small cells in the ROW are not new to Naperville. The city currently has small cell license agreements in place with both Verizon and AT&T and has issued permits to both carriers to collocate on existing ComED wood poles for small cell placement.

The City Council recently approved seven (7) similar Verizon Small Cell license agreements at the August 16th, 2016 meeting. Those seven (7) sites are:

- 1) Route 59 Metra Station light pole
- 2) Washington & Hobson (DT_3_SC_2)
- 3) 1001 S. Washington Ave (DT 1 SC 6)
- 4) 500 S. Charles (DT 1 SC 3)
- 5) Benedetti & Ogden (DT 3 SC 3)
- 6) 1932 W. Jefferson
- 7) Aurora & River (DT 1 SC 4)

This site (485 Diehl Road) we are requesting today has also been reviewed and approved by the city building and zoning departments. Once the agreement is approved, the permit will be issued.

As I explained in our 2016 proposal, Small Cell technology is new, but one Verizon is embracing. Small Cells are meant to complement the existing Macro sites, not replace them. Due to the low height and small amount of equipment, they are meant to cover a much smaller area. They are placed in precise locations to address current or anticipated capacity coverage issues. That means during certain times of the day when the wireless traffic is so high, the small cells will help take the load off the existing Macro site sector in the area. See link below with a short, but great video clip explaining the benefit to Naperville as well as the map below to help illustrate the concept:

https://www.youtube.com/watch?v=VQYQAaeyzFs&feature=youtu.be

Verizon is proposing a license agreement with the following terms:

- 5-year term with 4/5 year renewals.
- Annual payments of \$3,000 increasing by 1% annually. \$3,275 increasing by 3% annually after year 2.
- 180 day-notice right to terminate for either party.
- City has 60-day notice right to terminate if the site is needed for city services.
- \$4,750 upfront payment due within 90 days of full execution. (\$4,775)
- \$7,500 escrow deposit to guarantee maintenance and removal of sites.
- Verizon is required to provide an independent 3rd party radio frequency study for each site to show the site is FCC compliant.

We have been working very hard with the city staff to review and design these sites over the last year. We've had several staff meetings reviewing each site and changing them to meet their design criteria. Right now, Verizon does not know how many more they will need, but they are certain this new technology is a creative way to meet the demand for seamless wireless coverage in Naperville. Nobody wants more "towers" in or near residential. This will help avoid that necessity.

We look forward to discussing this proposal and thank you for providing Verizon the opportunity to address the City Council.

Sincerely,

Ray Shinkle

Ray Shinkle Insite RE, Inc. Authorized agent for Verizon Wireless

Enclosures

CONSULTANT TEAM

PROJECT TERRA CONSULTING GROUP, LTD. CONSULTANT: 600 BUSSE HIGHWAY

PARK RIDGE, IL 60068 (847) 698-6400

STRUCTURAL: HUTTER TRANKINA ENGINEERING

32 W 273 ARMY TRAIL RD, SUITE 100 WAYNE. IL 60184

(630) 513-6711

SURVEY: MERIDIAN SURVEYING, LLC

N8774 FIRELANE 1 MENASHA, WI 54952 (920) 993-0881

POLE DESIGN: VALMONT INDUSTRIES, INC

20805 EATON AVE. FARMINGTON, MI 55024 (651) 463-8990

PROJECT TYPE

PROPOSED VERIZON WIRELESS ANTENNA ON PROPOSED LIGHT POLE AND PROPOSED SMALL CELL EQUIPMENT ADJACENT TO POLE. POWER TO BE DELIVERED VIA CONDUIT FROM PROPOSED LESSEE METER NEAR EXISTING POWER SOURCE. FIBER TO BE DELIVERED VIA CONDUIT (BY OTHERS).

SITE COORDINATES:

LATITUDE: 41° 48' 10.96" N (1A CERTIFICATON) LONGITUDE: 88° 08' 25.16" W (1A CERTIFICATON)

ELEVATION: ±751' (1A CERTIFICATON)

APPROVALS

REAL ESTATE:


RF:

CONSTRUCTION:

OPERATIONS:

EQUIPMENT ENGINEERING:



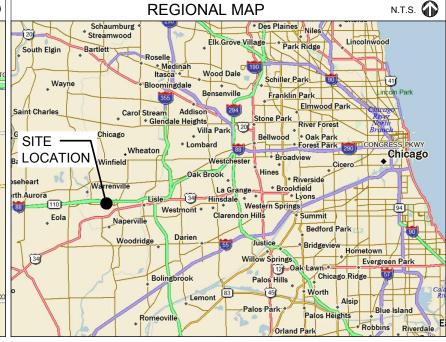

PROJECT INFORMATION

PROJECT #: 20151233064 APPLICATION #: 16-00001596

UTILITIES: POWER: CITY OF NAPERVILLE FIBER: WOW

MARCOS VALENCIA BILL SCHENK (630) 420-6653 (630) 536-3123

000) 420

POLE #: 025083

JURISDICTION: CITY OF NAPERVILLE

OCCUPANCY: UNINHABITED

ZONING: -

CONSTRUCTION TYPE: CO-LOCATION ON PROPOSED LIGHT POLE

PROPERTY OWNER:

APPLICANT: CHICAGO SMSA

limited partnership d/b/a Verizon Wireless 1515 WOODFIELD ROAD SCHAUMBURG, IL 60173

CONSTRUCTION MANAGER: JASON EISELEIN (847) 706-7118
REAL ESTATE MANAGER: KATHY COGSWELL (847) 619-4270

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CHICAGO SMSA


limited partnership

CHICAGO SMSA LIMITED PARTNERSHIP d/b/a VERIZON WIRELESS 1515 WOODFIELD ROAD, SUITE 1400 SCHAUMBURG, ILLINOIS 60173 PHONE: (847) 619-5397 FAX: (847) 706-7415

LOCATION NUMBER: 383996

SITE NAME: NAPHOLIN 3 SC 1

485 DIEHL RD NAPERVILLE, IL 60563

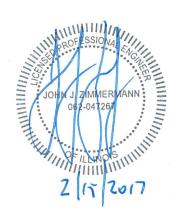

SMSA SMFF SMFF SMSA



	ВУ	MPC	EW	MPC	LRB	MPC	MPC	MPC
	DATE	03/03/16	04/11/16	08/02/16	10/04/16	12/09/16	01/20/17	02/15/17
REVISIONS	DESCRIPTION	UPDATED WITH FIBER PLAN	UPDATED LIGHT POLE AND FIBER ROUTE	REVISED FIBER HANDHOLE LOCATION	UPDATED ANTENNA CONFIGURATION	ISSUED FOR FINAL	CHARLES CABINET SHIFTED 2' NORTH	CHARLES CABINET RELOCATED TO EDGE OF R.O.W. 02/15/17
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LOC# 383996 NAPHOLIN_3_ SC 1

485 DIEHL RD NAPERVILLE, IL 60563


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DATE:	05/20/15
PROJECT #:	88-058


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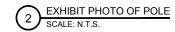
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CHICAGO SMSA Iimited partnership



	REVISIONS		
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ш	REVISED FIBER HANDHOLE LOCATION	08/02/16	MPC
ŋ	UPDATED ANTENNA CONFIGURATION	10/04/16	LRB
0	ISSUED FOR FINAL	12/09/16	MPC
-	CHARLES CABINET SHIFTED 2' NORTH	01/20/17	MPC
2	CHARLES CABINET RELOCATED TO EDGE OF R.O.W. 02/15/17	02/15/17	MPC

LOC# 383996 NAPHOLIN_3_ SC_1

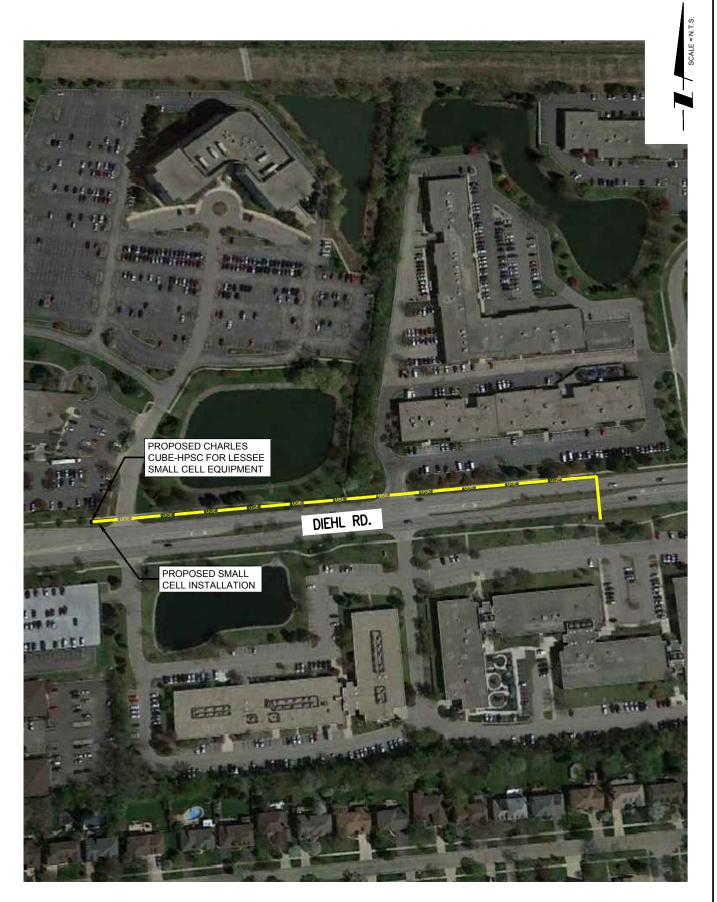485 DIEHL RD NAPERVILLE, IL 60563
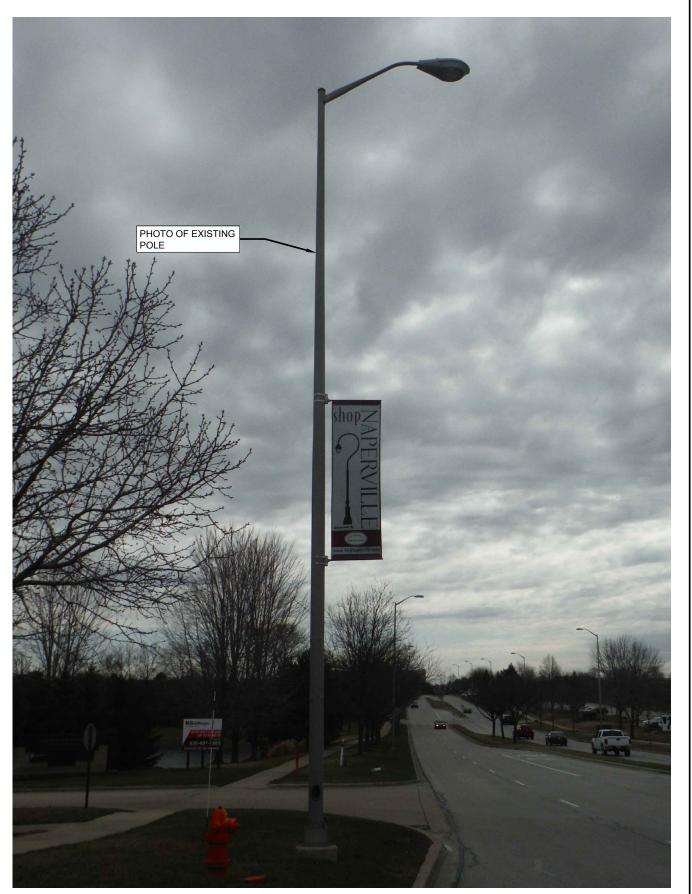
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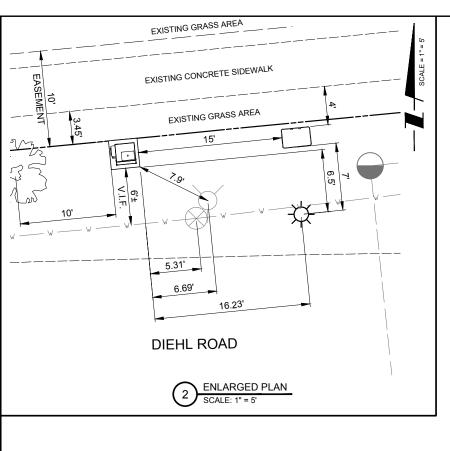
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AERIAL LOCATION & EXHIBIT PHOTO


SHEET NUMBER

LP-1





EXISTING LEGEND ● = 1" IRON PIPE FOUND ◎ = GAS VALVE ● = MANHOLE ◎ = WATER VALVE ■ FIBER OPTIC VAULT ■ FIBER OPTIC PEDESTAL □ LIGHT POLE ■ ELECTRIC TRANSFORMER = EXISTING POWER POLE = EXISTING GUY ANCHOR → EXISTING GUY ANCHOR AND POLE → = TRAFFIC SIGNAL ■ = ELECTRIC MANHOLE/SIGNAL MANHOLE ¶ = GAS MARKER ⊕ = STORM INLET (ROUND) ■ = CURB STORM INLET -OHE = OVERHEAD ELECTRIC = EXISTING TREE All utilities as shown are approximate locations derived from actual measurements and available records. They should not be interpreted to be in exact location nor should it be assumed that they are the only utilities in the area.

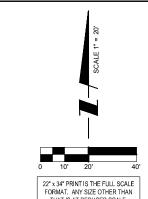

PROPOSED LESSEE STAND ALONE METER PEDESTAL WITH MAIN DISCONNECT. SERVICE DISCONNECT MUST BE VISIBLE

THAT IS AT REDUCED SCALE.



limited partnership

CHICAGO SMSA

	ВУ	MPC	EW	MPC	LRB	MPC	MPC	MPC
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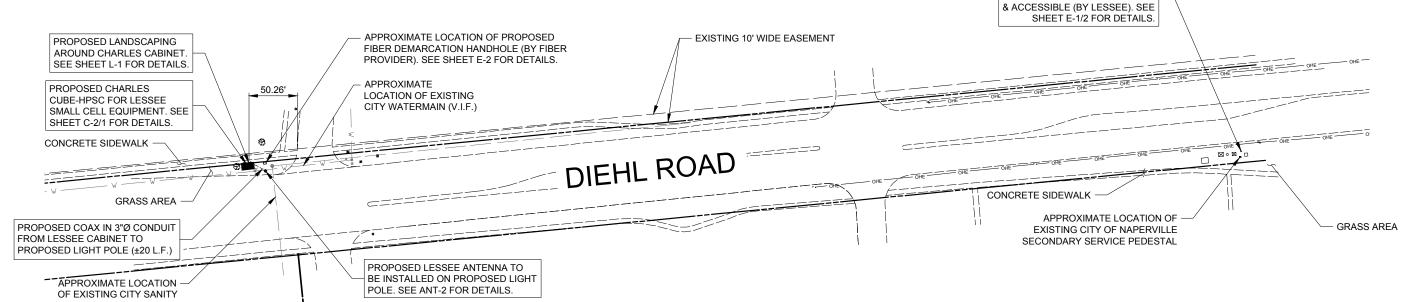
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485 DIEHL RD NAPERVILLE, IL 60563

DRAWN BY:	BTE
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SHEET TITLE SITE PLAN

SHEET NUMBER



OVERALL SITE PLAN

SCALE: 1" = 20'


OPERATES 24 HOURS A DAY 365 DAYS A YEAR


SEWER (V.I.F.)

ILLINOIS ONE CALL SYSTEM CALL JULIE TOLL FREE 1(800) 892-0123 48 HOURS BEFORE

OVERALL SITE PLAN PARTIALLY CREATED OFF OF AERIAL IMAGE AS BOUNDARY SURVEY DID NOT INCORPORATE THE SECONDARY POWER SOURCE

POLE. SEE ANT-2 FOR DETAILS.

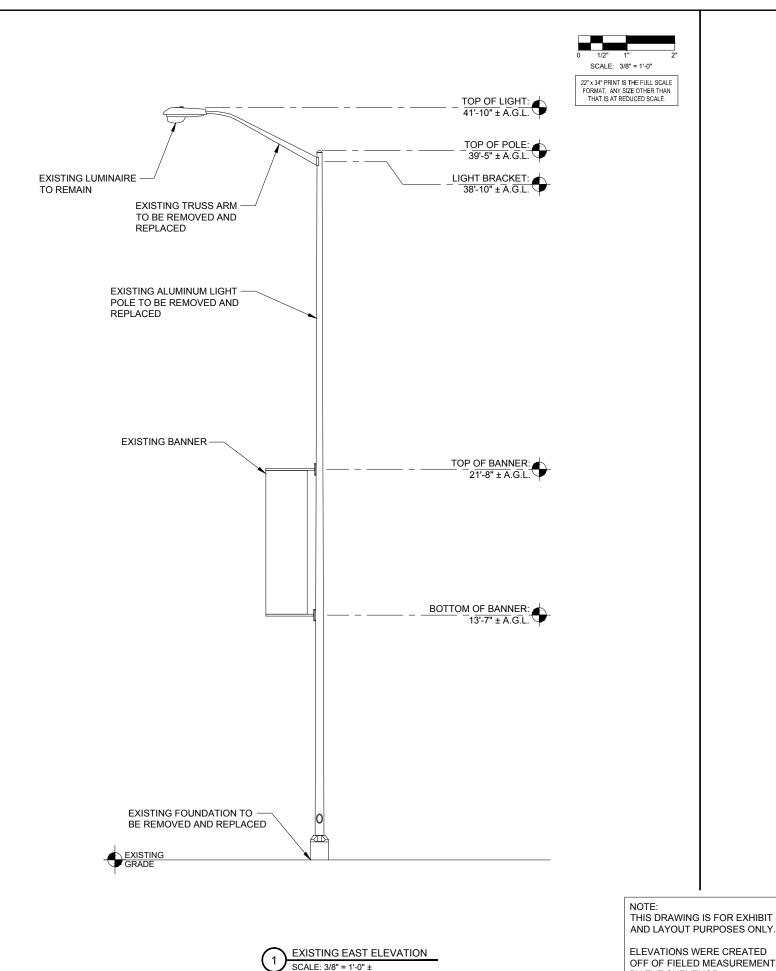

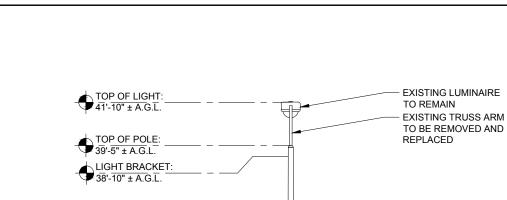

TOP OF BANNER: 21'-8" ± A.G.L.

BOTTOM OF BANNER:

22" x 34" PRINT IS THE FULL SCALE FORMAT. ANY SIZE OTHER THAN THAT IS AT REDUCED SCALE.

EXISTING ALUMINUM LIGHT POLE TO BE REMOVED AND

- EXISTING FOUNDATION TO BE REMOVED AND REPLACED

REPLACED

limited partnership CHICAGO SMSA



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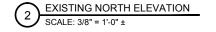
LOC# 383996 NAPHOLIN_3_ SC_1


485 DIEHL RD NAPERVILLE, IL 60563

DRAWN BY:	BTE
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EXISTING SITE ELEVATIONS

ELEVATIONS WERE CREATED OFF OF FIELED MEASUREMENTS BY THE SURVEYOR



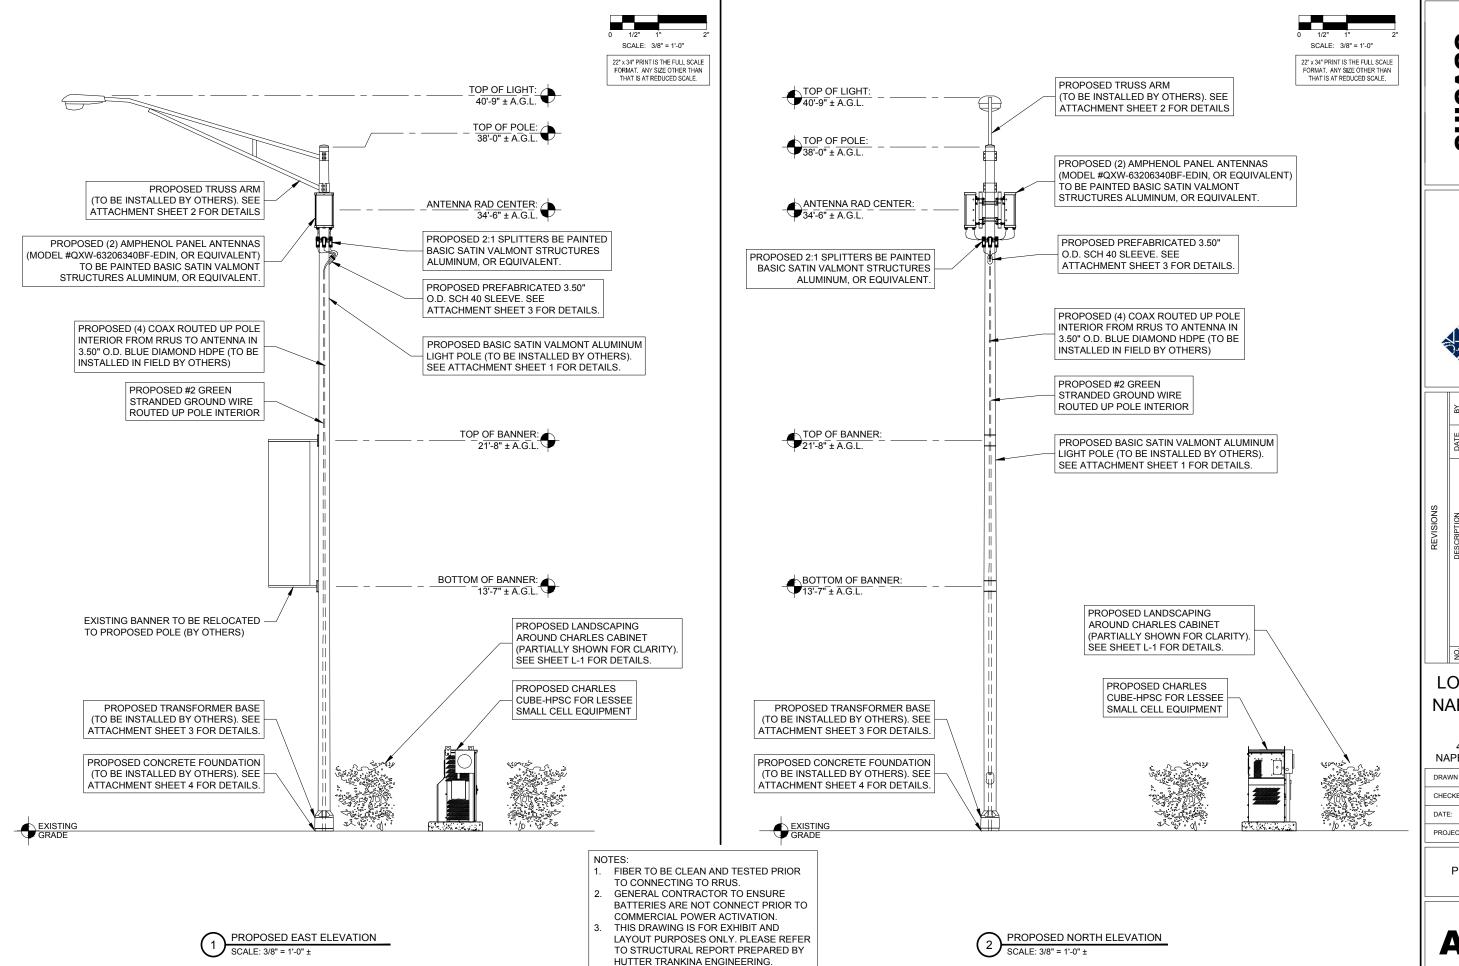

CHICAGO
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	ВУ	MPC	EW	MPC	LRB	MPC	MPC	MPC
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I	DRAWN BY:	BTE
l	CHECKED BY:	TAZ
l	DATE:	05/20/15
l	PROJECT #:	88-058

SHEET TITLE

PROPOSED SITE ELEVATIONS

SHEET NUMBER

ANT-2