

TREE RATING NOTES:

Tree Survey and Rating Assignment Limitations/Definitions:

1. Unless otherwise stated all trees are surveyed from ground level using non-invasive visual observation. The disclosure of hidden crown and stem defects, in particular where they may be above a reachable height or covered in ivy or in areas of ground vegetation, or deep snow cannot therefore be expected. The absence of foliage due to fall/winter weather or storm damage may limit the available information.

then said land is not accessed and our inspection is therefore restricted to what can reasonably be seen from within the site. Stem diameters of trees located on such land are estimated.

3. Where poison ivy is attached to the tree trunk, stem diameters will be

4. Diameter measurements are made at 4.5 feet above the ground (DBH) unless local ordinance requirements dictate different procedures.

Explanation of Tree Ratings:

Good (G) The tree is typical of the species and may have 1 or 2 minor problems that are not imminently lethal to the tree, and no significant decay or structural problems. The tree may need care in order to minimize the impact of future stress and to ensure continued health. Invasive species will not be graded Good, regardless of their current health or structure

> The tree is not typical of the species and/or is an invasive species and/or has significant problems such as ≥ 20 percent deadwood in the crown, serious decay or structural defect, insects, disease or other problems that can be imminently lethal to the tree or create a hazardous tree if not corrected in a short period of time or if the tree is subjected to additional stress.

Poor (P) The tree is not typical of the species and/or has over 50 percent deadwood in the crown, major decay or structural problems, is hazardous or is severely involved with insects, disease, or other problems that even if aggressively corrected would not result in the long term survival.

The tree is 90 percent or more dead. A scratch test of under bark areas might be performed where branches can be reached. Stumps with live sprouts up to 3" diameter are graded Dead or not included on the mapping.

Trees were inventoried on 11/02/2022 by Heath Wright, arborist license: IL-9435A

PROJECT

Jet Brite Car Wash

Route 59 and 83rd Street Naperville, Illinois 60564

PROJECT TEAM



uplandDesign Itd

Park Planning and Landscape Architecture 1229 N North Branch St, Chicago, Illinois 60642 24042 Lockport St, Plainfield, Illinois 60544 815-254-0091 www.uplanddesign.com

SHEET TITLE

Tree Preservation Plan

02MAR2023

12JULY2023

W /	W / REVISION			
Ν	Resubmittal	14DEC2022		
?	Resubmittal	18JAN2023		
3	Resubmittal	07FEB2023		

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TREE SURVEY CHART:

ag #	Diameter Inch	•	Common Name	Condition	Removal	Reason for Removal
2	5.1, 10.1 Dead	Pyrus calleryana	Callery Pear	Fair Dead	X	Undesirable Species Dead
3	Dead	-		Dead	X	Dead Dead
4	Dead	-		Dead	Х	Dead
5	Dead	-	NA .:	Dead	X	Dead
6	23.5	Morus alba	Mulberry	Fair Fair	X	Undesirable Species
7 8	15.2 11.8, 10.2	Acer negundo Acer negundo	Boxelder Boxelder	Fair	X	Located in Development Located in Development
9	5.4	Morus alba	Mulberry	Poor	X	Located in Development
10	10.0	Celtis occidentalis	Hackberry	Excellent	Х	Located in Development
11	11.6	-	Boxelder	Good	Х	Located in Development
12	8.6	Morus alba	Mulberry	Good	X	Located in Development
13 14	Dead 8.3, 7.6	- Acer sacchariunum	Dead Silver Maple	Dead Good	X	Dead Located in Development
15	17.3	Celtis occidentalis	Hackberry	Excellent	^	Located in Development
16	Dead	-	Dead	Dead	Х	Dead
17	12.2	Morus alba	Mulberry	Excellent	Х	Undesirable Species
18	12.4	Morus alba	Mulberry	Excellent		
19	11.4 Dead	Morus alba	Mulberry Dead	Good Dead	X	Undesirable Species Dead
20	32.7	Acer platanoides	Norway Maple	Excellent	^	Deau
22	20.3	Morus alba	Mulberry	Good	Х	Undesirable Species
23	30.0	Acer sacchariunum	Silver Maple	Excellent		
24	Dead	-	Dead	Dead	X	Dead
25	23.8	Acer sacchariunum	Silver Maple	Excellent		Undesirable Species/Poo
26	9.7	Morus alba	Mulberry	Poor	X	Condition
	40.5	Morris alla		Poor		Undesirable Species/Poo Condition
27 28	12.5 Dead	Morus alba -	Mulberry Dead	Dead	X	Dead
29	7.5	Fraxinus spp	Ash	Poor	X	Poor Condition
30	12.9	Juglans nigra	Black Walnut	Excellent		
31	17.2	Morus alba	Mulberry	Fair	X	Undesirable Species
32	15.8	Morus alba	Mulberry	Fair	X	Undesirable Species
33	5.7	Fraxinus spp	Ash	Poor	X	Poor Condition Undesirable Species/Poo
34	14.2, 13.6	Morus alba	Mulberry	Poor	Х	Condition
35	14.0	Morus alba	Mulberry	Excellent	X	Undesirable Species
36	9.8, 10.5	Morus alba	Mulberry	Good	X	Undesirable Species
37 38	5.4 9.5	Acer negundo Picea pungens	Boxelder Colorado Spruce	Good Poor	X	Undesirable Species Poor Condition
39	8.5.	Picea pungens	Colorado Spruce	Poor	X	Poor Condition
40	10.6	Picea pungens	Colorado Spruce	Poor	Х	Poor Condition
41	8.5	Picea pungens	Colorado Spruce	Poor	X	Poor Condition
42	9.4	Picea pungens	Colorado Spruce	Poor	X	Poor Condition
43	9.1	Picea pungens Morus alba	Colorado Spruce	Poor Poor	X	Poor Condition Poor Condition
44 45	10.3	Picea pungens	Mulberry Colorado Spruce	Poor	X	Poor Condition
46	6.3	Picea pungens	Colorado Spruce	Poor	X	Poor Condition
47	Dead	-	Dead	Dead	Х	Dead
48	Dead	-	Dead	Dead	X	Dead
49	10.2	Morus alba	Mulberry	Good Dead	X	Undesirable Species
50 51	Dead 6.2	Picea pungens	Dead Colorado Spruce	Poor	X	Dead Poor Condition
52	5.1	Picea pungens	Colorado Spruce	Poor	X	Poor Condition
53	8.0	Picea abies	Norway Spruce	Good		
54	8.5	Picea abies	Norway Spruce	Good		
55	9.1	Pinus nigra	Austrian Pine	Poor Fair	X	Poor Condition
56 57	8.7 21.0	Pinus nigra Ulmus pumila	Austrian Pine Siberian Elm	Fair	X	Undesirable Species
58	25.4	Celtis occidentalis	Hackberry	Excellent	X	Ondeditable opened
59	17.8	Morus alba	Mulberry	Poor		
60	18.2	Juglans nigra	Black Walnut	Excellent	Х	Located in Development
61	Dead	-	Dead	Dead	X	Dead
62 63	6.7 Dead	Morus alba	Mulberry Dead	Good Dead	X	Located in Development Dead
63	Dead	-	Dead	Dead	X	Dead Dead
65	Dead	-	Dead	Dead	X	Dead
66	Dead	-	Dead	Dead	Х	Dead
67	8.9	Celtis cccidentalis	Hackberry	Excellent	X	Located in Development
68	Dead	-	Dead	Dead Dead	X	Dead
69 70	Dead 13.9	- Morus alba	Dead Mulberry	Good	X	Dead Located in Development
71	14.7, 9.0	Juglans nigra	Black Walnut	Good	X	Located in Development
72	13.9	Celtis cccidentalis	Hackberry	Excellent	X	Located in Development
73	7.8	Juglans nigra	Black Walnut	Excellent	X	Located in Development
74	9.8	Celtis occidentalis	Hackberry	Excellent	X	Located in Development
75 76	Dead 13.4	Juglans nigra	Dead Black Walnut	Dead Excellent	X	Dead Located in Development
76 77	13.4	Jugians nigra Jugians nigra	Black Walnut	Excellent	^	Located in Development
78	13.3	Juglans nigra	Black Walnut	Good		
79	7.3	Celtis occidentalis	Hackberry	Excellent		
80	8.4	Celtis occidentalis	Hackberry	Excellent		
81	Dead	· · · · · ·	Dead	Dead	X	Dead
82 83	7.1	Celtis occidentalis Juglans nigra	Hackberry Black Walnut	Good Excellent	X	Located in Development Located in Development
83	9.6	Celtis occidentalis	Hackberry	Excellent	X	Located in Development
85	13.4	Juglans nigra	Black Walnut	Excellent	X	Located in Development
86	Dead	-	Dead	Dead	X	Dead
87	8.0	Morus alba	Mulberry	Fair	X	Located in Development
88	Dead	-	Dead	Dead	X	Dead
89	6.8	Juglans nigra	Black Walnut	Excellent Good	X	Located in Development
90	9.3	Juglans nigra Juglans nigra	Black Walnut Black Walnut	Excellent	X	Located in Development Located in Development
92	11.9, 6.3	Catalpa spp	Catalpa	Good	X	Located in Development
	9.0	Juglans nigra	Black Walnut	Excellent	X	Located in Development
93	9.0	ougiano mgra	Diack Vvairiat	Excononi		

		1		1		
Tag #	Diameter Inch	•	Common Name	Condition	Removal	Reason for Removal
96	7.2 Dead	Juglans nigra	Black Walnut	Excellent Dead	X	Located in Development Dead
97 98	Dead	-	Dead Dead	Dead	X	Dead
99	Dead	-	Dead	Dead	X	Dead
100	Dead	-	Dead	Dead	X	Dead
101	7.8	Morus alba	Mulberry	Good	Χ	Located in Development
102	0.0	no tree (tag not used)	no tree (tag not used)	GONE	Χ	Located in Development
103	8.7	Morus alba	Mulberry	Good	X	Located in Development
104	8.2	Morus alba	Mulberry	Good	X	Located in Development
105	Dead	- Liller va a varida	Dead	Dead	X	Located in Development
106 107	7.5, 8.1, 14.8	Ulmus pumila Juglans nigra	Siberian Elm Black Walnut	Good Excellent	X	Located in Development Located in Development
107	Dead	-	Dead Dead	Dead	X	Dead
109	Dead	-	Dead	Dead	X	Dead
110	12.5	Juglans nigra	Black Walnut	Excellent	Х	Located in Development
111	16.4	Juglans nigra	Black Walnut	Excellent	Χ	Located in Development
112	11.2	Morus alba	Mulberry	Fair	Χ	Located in Development
113	11.1	Morus alba	Mulberry	Good	X	Located in Development
114	8.1	Morus alba	Mulberry	Poor	X	Located in Development
115	13.0	Juglans nigra	Black Walnut	Excellent	X	Located in Development
116 117	12.9 10.1	Juglans nigra Morus alba	Black Walnut Mulberry	Excellent Poor	X	Located in Development Located in Development
117	Dead	-	Dead	Dead	X	Dead
119	7.9	Morus alba	Mulberry	Excellent	X	Located in Development
120	8.0	Morus alba	Mulberry	Fair	X	Located in Development
121	Dead	-	Dead	Dead	Х	Dead
122	7.5, 9.7	Morus alba	Mulberry	Fair	Χ	Located in Development
123	8.4	Juglans nigra	Black Walnut	Excellent	Х	Located in Development
124	9.3	Juglans nigra	Black Walnut	Excellent	X	Located in Development
125	8.2	Celtis occidentalis	Hackberry	Excellent	X	Located in Development
126	8.5	Juglans nigra	Black Walnut	Excellent	X	Located in Development
127	8.7 7.2	Morus alba Morus alba	Mulberry Mulberry	Fair Excellent	X	Located in Development Located in Development
128 129	7.2 Dead	เพเบเนอ สเมส	Mulberry Dead	Dead	X	Located in Development Dead
130	10.1	Juglans nigra	Black Walnut	Excellent	X	Located in Development
131	12.5	Juglans nigra	Black Walnut	Excellent	X	Located in Development
132	Dead	-	Dead	Dead	Х	Dead
133	10.1	Morus alba	Mulberry	Good	Х	Located in Development
134	12.5	Morus alba	Mulberry	Good	Х	Located in Development
135	Dead		Dead	Dead	X	Located in Development
136	7.7	Juglans nigra	Black Walnut	Excellent	X	Located in Development
137	11.8	Juglans nigra	Black Walnut	Excellent	X	Located in Development
138	6.7 12.6	Morus alba	Mulberry Black Walnut	Excellent Good	X	Located in Development
139 140	Dead	Juglans nigra -	Dead	Dead	X	Located in Development Dead
141	10.2	Morus alba	Mulberry	Poor	X	Located in Development
142	7.0	Morus alba	Mulberry	Poor	X	Located in Development
143	Dead	-	Dead	Dead	Χ	Dead
144	Dead	-	Dead	Dead	Х	Dead
145	Dead	-	Dead	Dead	X	Dead
146	8.5	Juglans nigra	Black Walnut	Excellent	X	Located in Development
147	6.7	Morus alba	Mulberry	Good	X	Located in Development
148	Dead		Dead	Dead Good	X	Dead
149 150	7.2	Morus alba Morus alba	Mulberry Mulberry	Excellent	X	Located in Development Located in Development
151	7.3	Celtis occidentalis	Hackberry	Excellent	X	Located in Development
152	12.6	Juglans nigra	Black Walnut	Excellent	X	Located in Development
153	7.4	Juglans nigra	Black Walnut	Good	X	Located in Development
154	7.3	Ulmus americana	American Elm	Excellent	Χ	Located in Development
155	9.3, 8.3	Juglans nigra	Black Walnut	Good	Χ	Located in Development
156	7.5	Acer negundo	Box Elder	Good	X	Located in Development
157	6.5	Juglans nigra	Black Walnut	Excellent	X	Located in Development
158	18.2	Juglans nigra	Black Walnut	Excellent	X	Located in Development
159 160	11.9 10.8,11.0,14.0	Celtis occidentalis Acer sacchariunum	Hackberry Silver Maple	Excellent Poor	X	Located in Development Located in Development
161	18.0	Acer negundo	Box Elder	Poor	X	Located in Development
162	18.3	Juglans nigra	Black Walnut	Excellent	X	Located in Development
163	10.7	Celtis occidentalis	Hackberry	Excellent	X	Located in Development
164	Dead	-	Dead	Dead	Χ	Dead
165	7.4	Morus alba	Mulberry	Poor	X	Located in Development
166	9.6	Morus alba	Mulberry	Poor	X	Located in Development
167	7.1	Juglans nigra	Black Walnut	Excellent	X	Located in Development
168 169	Dead 8.3	Juglans nigra	Dead Black Walnut	Dead Good	X	Dead Located in Development
169	7.1	Jugians nigra Jugians nigra	Black Walnut	Excellent	X	Located in Development Located in Development
171	7.7,15.1	Morus alba	Mulberry	Fair	X	Located in Development
172	8.7	Morus alba	Mulberry	Poor	X	Located in Development
173	Dead	-	Dead	Dead	X	Dead
174	13.2	Acer negundo	Boxelder	Poor	Х	Located in Development
175	8.3	Morus alba	Mulberry	Poor	X	Located in Development
176	7.3	Ulmus spp	Elm species	Excellent	X	Located in Development
177	13.5	Juglans nigra	Black Walnut	Excellent Good	X	Located in Development
178 179	5.7 5.4	Morus alba Morus alba	Mulberry Mulberry	Excellent	X	Located in Development Located in Development
179	4.8	Morus alba	Mulberry	Good	X	Located in Development Located in Development
181	6.2	Morus alba	Mulberry	Excellent	X	Located in Development
182	6.2	Morus alba	Mulberry	Fair	X	Located in Development
183	6.4	Morus alba	Mulberry	Good	X	Located in Development
184	7.0	Morus alba	Mulberry	Poor	Х	Located in Development
185	6.0	Morus alba	Mulberry	Good	X	Located in Development
186	6.1	Morus alba	Mulberry	Excellent	X	Located in Development
187	13.2	Morus alba	Mulberry	Fair Poor	X	Located in Development
188 189	9.8 7.0	Acer negundo Celtis occidentalis	Boxelder Hackberry	Excellent	X	Located in Development Located in Development
189	5.7	Morus alba	Mulberry	Poor	X	Located in Development Located in Development
191	Dead	-	Dead	Dead	X	Dead
				•		

Tag #	Diameter Inch		Common Name Box Elder	Condition	Removal X	Reason for Removal Located in Development
192 193	6.3	Acer negundo Morus alba	Mulberry	Poor	X	Located in Development
194	6.0	Acer negundo	Box Elder	Good	X	Located in Development
195	10.8	Acer negundo	Box Elder	Good	Х	Located in Development
196	7.3	Juglans nigra	Black Walnut	Excellent	X	Located in Development
197	15.8	Acer negundo	Box Elder	Good	Х	Located in Development
198	Dead	-	Dead	Dead	X	Located in Development
199 200	Dead 9.0	Juglans nigra	Dead Black Walnut	Dead Good	X	Located in Development Located in Development
301	10.1	Morus alba	Mulberry	Poor	X	Located in Development
302	10.4	Fraxinus spp	Ash	Poor	X	Located in Development
303 304	Dead Dead	-	Dead Dead	Dead Dead	X	Dead Dead
305	7.1	Acer negundo	Box Elder	Poor	X	Located in Development
306	17,23.8,25.5	Juglans nigra	Black Walnut	Good	X	Located in Development
307 308	12.2 12.6	Acer negundo Acer negundo	Box Elder Box Elder	Poor Poor	X	Located in Development Located in Development
309	Dead	-	Dead	Dead	X	Dead
310	10.6	Acer negundo	Box Elder	Fair	X	Located in Development
311 312	Dead 7.2	- Acer negundo	Dead Box Elder	Dead Poor	X	Dead Located in Development
313	Dead	-	Dead	Dead	X	Dead
314	7.2	Juglans nigra	Black Walnut	Excellent	X	Located in Development
315 316	Dead 8.6	- Celtis occidentalis	Dead Hackberry	Dead Good	X	Dead Located in Development
317	13.4	Acer negundo	Box Elder	Poor	X	Located in Development
318	6.1	Acer negundo	Box Elder	Poor	X	Located in Development
319 320	7.6 Dead	Acer negundo -	Box Elder Dead	Poor Dead	X	Located in Development Dead
321	Dead	-	Dead	Dead	X	Dead
322	12.0	Acer negundo	Box Elder	Fair	X	Located in Development
323 324	Dead 5.0	Acer negundo	Dead Box Elder	Dead Poor	X	Dead Poor Condition
325	Dead	-	Dead	Dead	Х	Dead
326	5.8	Morus alba	Mulberry	Good	X	Located in Development
327 328	21.0 6.8	Morus alba Celtis occidentalis	Mulberry Hackberry	Poor Excellent	X	Located in Development Located in Development
329	13.3	Morus alba	Mulberry	Good	Х	Undesirable Species
330	19.3	Morus alba	Mulberry	Poor	X	Located in Development
331 332	19.9 15.2	Morus alba Morus alba	Mulberry Mulberry	Good Fair	X	Located in Development Undesirable Species
333	4.8	Morus alba	Mulberry	Fair	Х	Undesirable Species
334	7.6	Morus alba	Mulberry	Good	X	Undesirable Species
335 336	Dead 6.2	- Morus alba	Dead Mulberry	Dead Good	X	Undesirable Species Undesirable Species
337	7.9	Celtis occidentalis	Hackberry	Excellent		
338	6.9	Morus alba	Mulberry	Good	X	Undesirable Species
339 340	6.1	Morus alba Morus alba	Mulberry Mulberry	Good Fair	X	Located in Development Located in Development
341	6.4	Morus alba	Mulberry	Good	Х	Located in Development
342	5.4	Morus alba	Mulberry	Fair	X	Located in Development
343 344	16.5 8.5	Acer platanoides Juglans nigra	Norway Maple Black Walnut	Good Excellent	X	Located in Development Located in Development
345	9.7	Juglans nigra	Black Walnut	Excellent	Х	Located in Development
346	5.8	Fraxinus spp	Ash	Poor	X	Poor Condition
347 348	7.5 13.5	Populus deltoides Populus deltoides	Cottonwood Cottonwood	Fair Good	X	Located in Development Located in Development
349	7.7	Populus deltoides	Cottonwood	Poor	Х	Located in Development
350	9.4	Salix spp	Willow	Poor	X	Located in Development
351 352	6.0,5.3	Fraxinus spp Acer negundo	Ash Box Elder	Poor Poor	X	Located in Development Poor Condition
353	12.0	Morus alba	Mulberry	Good	Х	Undesirable Species
354	6.9	Juglans nigra	Black Walnut	Good	X	Located in Development
355 356	10.5 6.4	Acer negundo Acer negundo	Box Elder Box Elder	Fair Good	X	Undesirable Species Undesirable Species
357	8.0	Juglans nigra	Black Walnut	Good	Х	Located in Development
358	10.8	Acer negundo	Box Elder	Good	X	Undesirable Species
359 A	Dead 4.8	Morus alba	Dead Mulberry	Dead Excellent	X	Dead Undesirable Species
В	7.1	Celtis occidentalis	Hackberry	Excellent	X	Located in Development
С	5.7	Celtis occidentalis	Hackberry	Excellent		Located in Develop
D E	5.0 4.0	Fraxinus spp Fraxinus spp	Ash Ash	Poor Poor	X	Located in Development Located in Development
F	4.7	Fraxinus spp	Ash	Poor	Х	Poor Condition
G	4.9 4.2	Fraxinus spp Morus alba	Ash	Poor	X	Poor Condition
H I	6.4	Morus alba Morus alba	Mulberry Mulberry	Good Good	X	Undesirable Species Located in Development
j	4.9	Prunus serotina	Black Cherry	Good		·
K	15.6	Morus alba	Mulberry	Poor	X	Located in Development
L M	6.4	Morus alba Morus alba	Mulberry Mulberry	Poor Poor	X	Poor Condition Poor Condition
N	6.7	Juglans nigra	Black Walnut	Excellent	Х	Located in Development
O	4.5 5.5	Celtis occidentalis	Hackberry Black Walnut	Good Good	X	Located in Development Located in Development
P Q	6.8	Juglans nigra Juglans nigra	Black Walnut	Excellent	X	Located in Development Located in Development
R	6.0	Celtis occidentalis	Hackberry	Excellent	Х	Located in Development
S T	16.5 9.0	Morus alba Juglans nigra	Mulberry Black Walnut	Poor Excellent	X	Located in Development Located in Development
U	5.3	Morus alba	Mulberry	Good	X	Located in Development
V	7.2	Celtis occidentalis	Hackberry	Excellent	Х	Located in Development
W X	8.5 5.8	Morus alba Celtis occidentalis	Mulberry Hackberry	Fair Good	X	Located in Development Located in Development
<u>х</u> Ү	6.6	Celtis occidentalis	Hackberry	Good	X	Located in Development
Z	6.2, 5.8, 4.4	Celtis occidentalis	Hackberry	Good	Х	Located in Development
AA AR	6.0 14.1	Celtis occidentalis	Hackberry Black Walnut	Good	X	Located in Development
AB AC	14.1 6.7	Juglans nigra Juglans nigra	Black Walnut Black Walnut	Excellent Excellent	X	Located in Development
AD	6.7	Juglans nigra	Black Walnut	Excellent	Х	Located in Development
AE	14.1	Juglans nigra	Black Walnut	Excellent	X	Located in Development
AF AG	5.9 9.8	Juglans nigra Juglans nigra	Black Walnut Black Walnut	Fair Excellent	X	Located in Development Located in Development
AH	4.4	Celtis occidentalis	Hackberry	Excellent	Х	Located in Development
Al	11.7	Juglans nigra	Black Walnut	Excellent	X	Located in Development
AJ AK	4.9 13.6	Celtis occidentalis Juglans nigra	Hackberry Black Walnut	Excellent Excellent	X	Located in Development Located in Development
AL	7.0	Morus alba	Mulberry	Fair	X	Located in Development
AM	4.5	Picea pungens Picea pungens	Colorado Spruce	Poor	X	Poor Condition
AN	5.1		Colorado Spruce	Poor		Poor Condition

PROJECT

Jet Brite Car Wash

Route 59 and 83rd Street Naperville, Illinois 60564

PROJECT TEAM



uplandDesign Itd Park Planning and Landscape Architecture

1229 N North Branch St, Chicago, Illinois 60642 24042 Lockport St, Plainfield, Illinois 60544 815-254-0091 www.uplanddesign.com

SHEET TITLE

Tree Preservation Plan


SHEET NUMBER

T1.

DRAW / REVISION

LD/DW	Resubmittal	14DEC2022		
LD/LR	Resubmittal	18JAN2023		
LD/AB	Resubmittal	07FEB2023		
LD	Resubmittal	02MAR2023		
LD/MO	Resubmittal	12JULY2023		
LD/MO	Resubmittal	10AUG2023		
roject Number 1095				

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W:\1095-Jet Brite Car Wash Naperville-Jet Brite\30-CD-Files
PLOT: UPLAND 2023

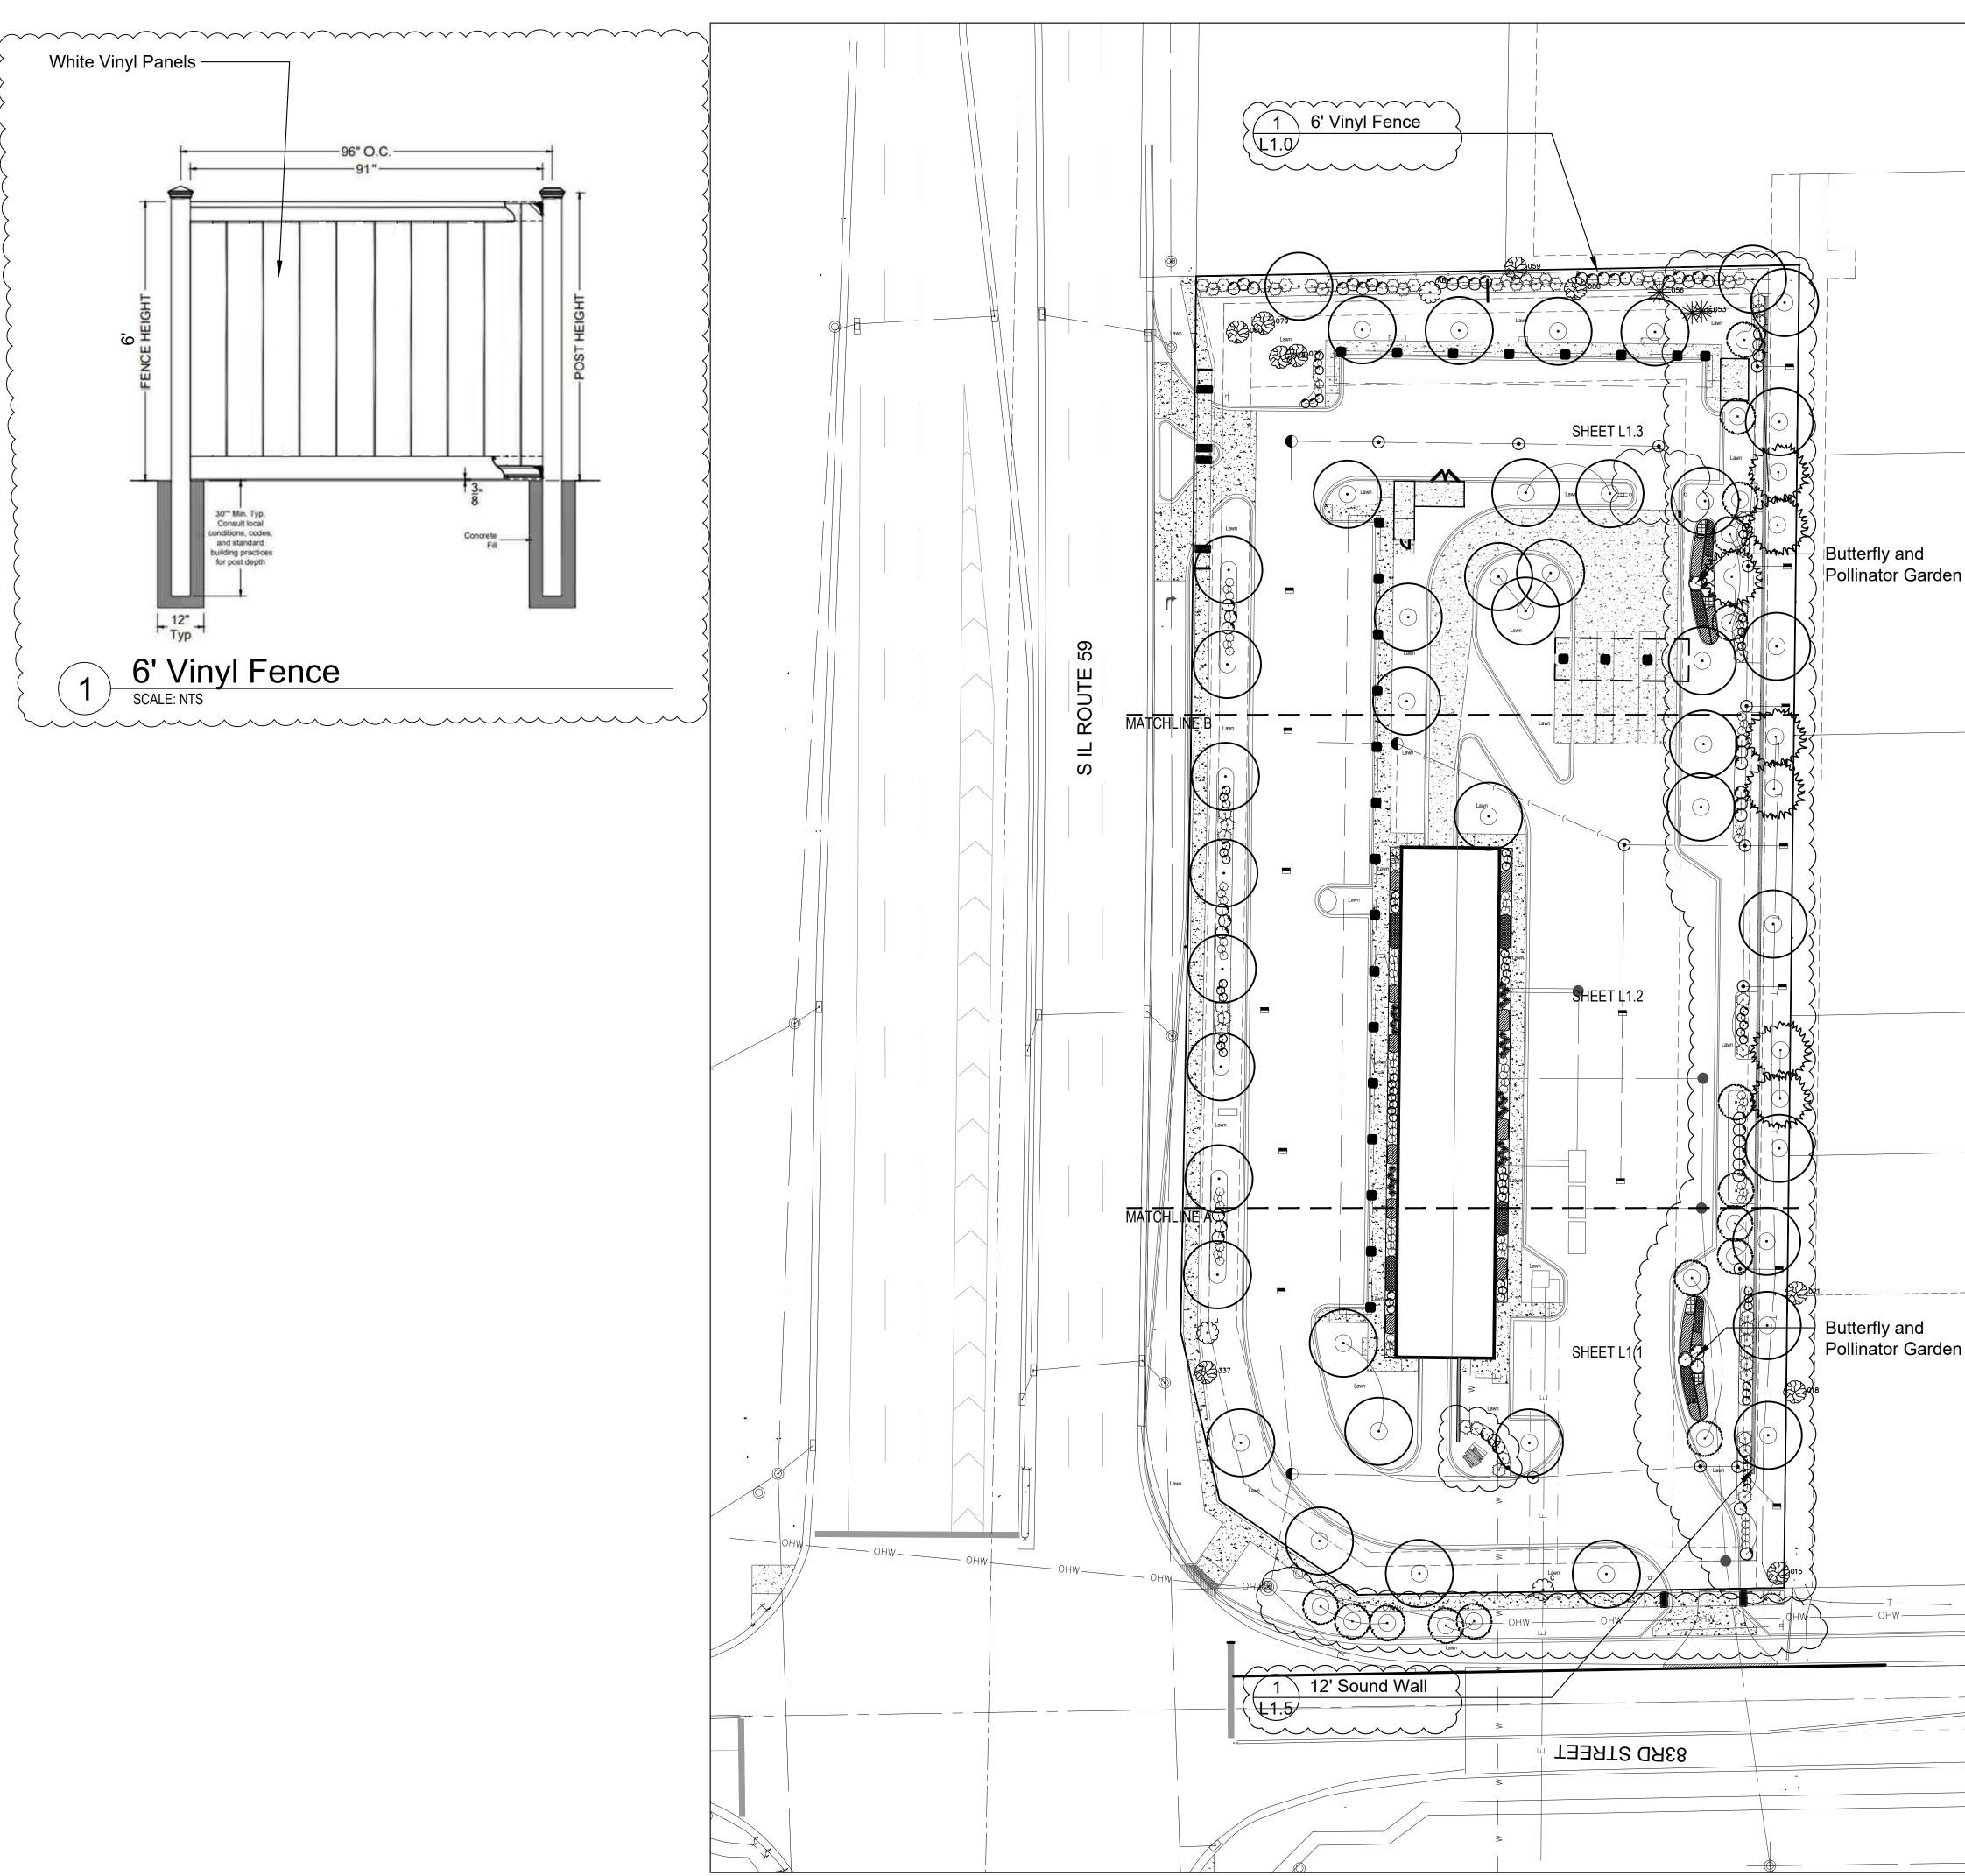

SCALE: 1" = 30'-0" 0 15' 30' 60' 90'

GENERAL NOTES: LANDSCAPE

- Notes indicated on grading plans shall pertain to landscape plans. Final grade of planting beds shall be as per grading plan.
- 2. The landscape contractor shall be responsible for making themselves familiar with all underground utilities and structures.
- 3. All existing plant material and trees shall be saved and protected unless otherwise noted. Contractor to protect new and existing trees and landscaping from damage and shall restore all areas disturbed as a result of construction.
- Plant material shall be supplied from Northern Illinois nursery stock, shall be dug the planting season it is installed, and shall conform to the American Association of Nurseryman's standards.
- 5. Plant material shall be size and type specified. Substitution of plant material shall be on a case by case basis and approved in writing by the Owner's Representative. In no case shall plant material be smaller than indicated in the plans.
- 6. Do not willfully proceed with plantings as designed when it is obvious that obstructions and/or grade differences exist that may not have been known during the design process.
- Such conditions shall be immediately brought to the attention of the Owner's Representative.

 7. All plant material shall be inspected and approved by the Owner's Representative prior to the installation of any and all plant material.
- 8. Plant locations shall be flagged in field with Owner's Rep. Final location of all plant material shall be subject to approval of the Owner's Representative prior to digging any holes. The landscape contractor is responsible for providing Owner's Representative with 48 hour minimum advance notice prior to planting.
- 9. Plants shall be watered on the day they are planted and maintained with watering until final acceptance of the project.
- 10. Apply a pre-emergent as per manufacturer's specification prior to installing mulch.
- 11. Beds and tree rings (6' diameter) shall have 3" of hardwood shredded mulch applied and a 4" deep spade edge at lawn. Trees that are not located in beds, shall have a tree ring.
- 12. Landscape plant material shall be guaranteed for 12 months from final acceptance. Any plant 1/3 dead or more shall be replaced under the guarantee.
- 13. Contractor to prepare landscape beds by roto-tilling 2" of Mushroom Compost into new beds.
 Do not add compost nor roto-till within drip line of existing trees.
- 14. Lawn Seeding shall be under favorable weather conditions, and shall follow dates in
- specification.

 15. Turf mixes shall be installed and lawn established at all disturbed areas.
- 16. Do not overseed into mulch beds and paving.
- 17. Contractor shall restore all areas disturbed as a result of construction.

 18. Jet Brite Car Wash shall maintain all onsite landscaping including the area east of the
- soundwall.

Shade Tree

Ornamental Tree

Ornamental Grass

6' Vinyl Fence

Perennial and Groundcover (hatch symbol varies)

LEGEND

PROJECT

Jet Brite Car Wash

Route 59 and 83rd Street Naperville, Illinois 60564

PROJECT TEAM



uplandDesign Itd

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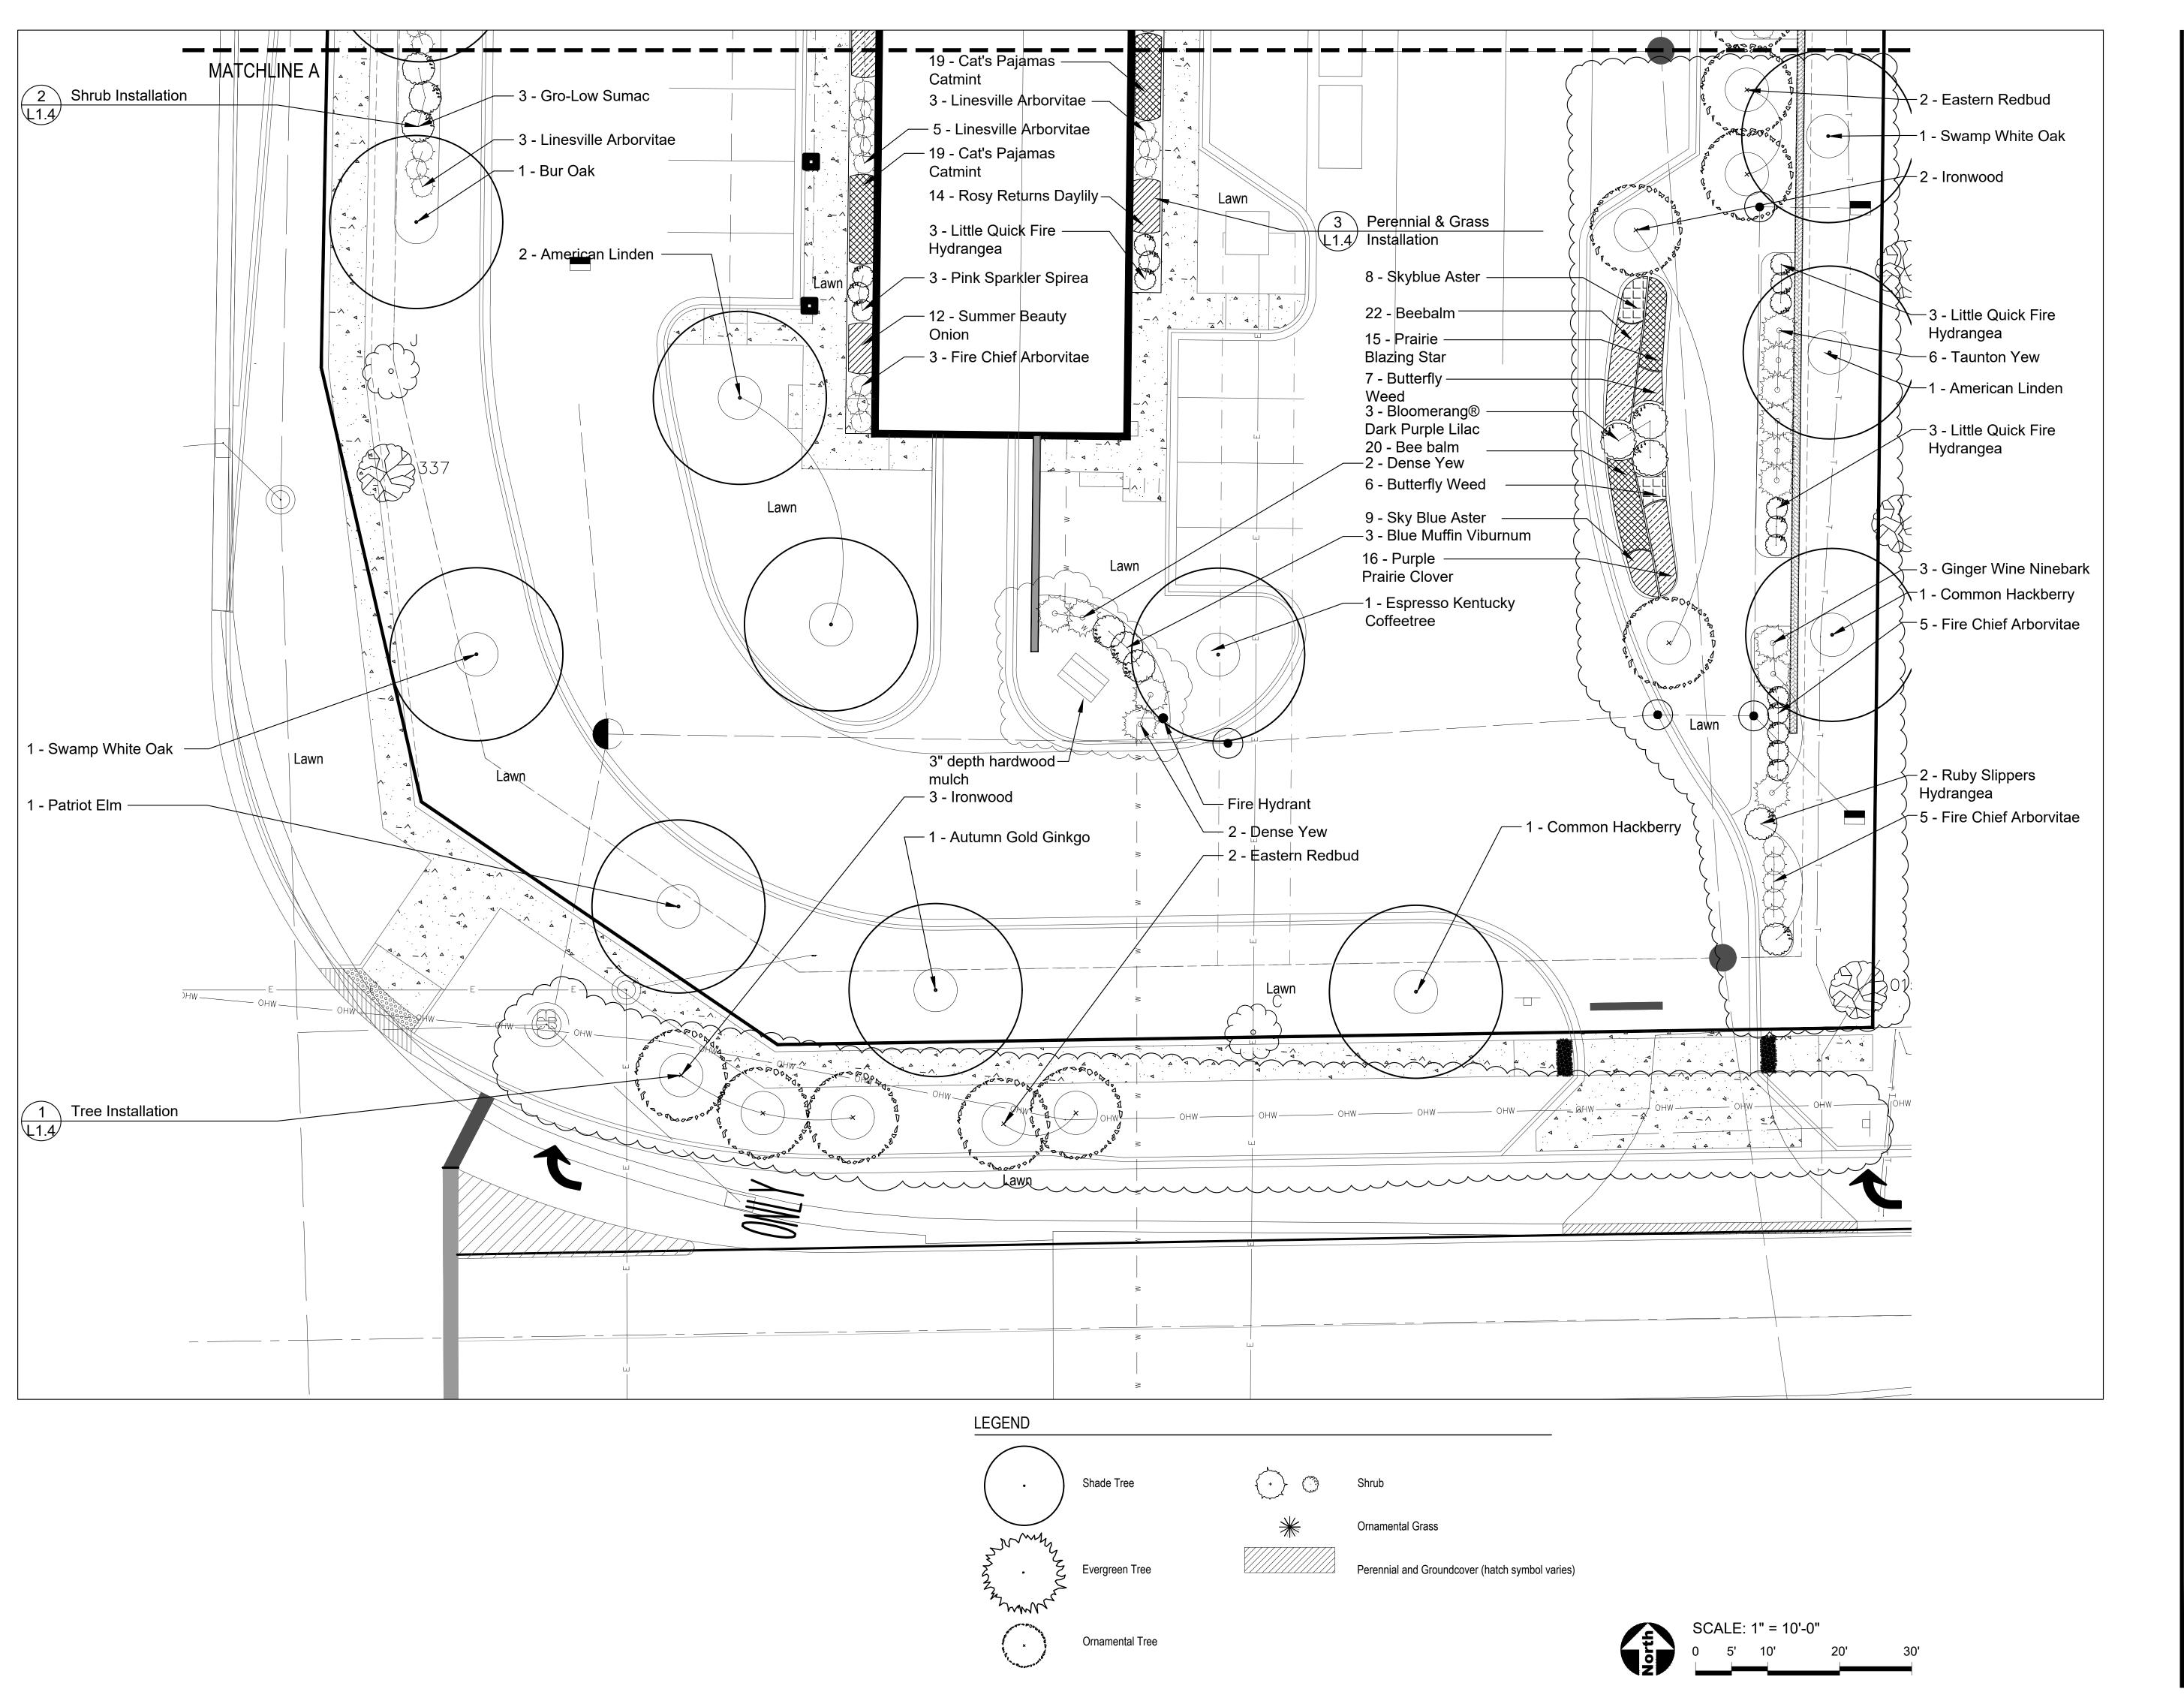
Landscape Plan

SHEET NUMBER

DRAW / REVISION

14DEC2022
18JAN2023
07FEB2023
02MAR2023
12JULY2023
10AUG2023

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PROJECT

Jet Brite Car Wash

Route 59 and 83rd Street Naperville, Illinois 60564

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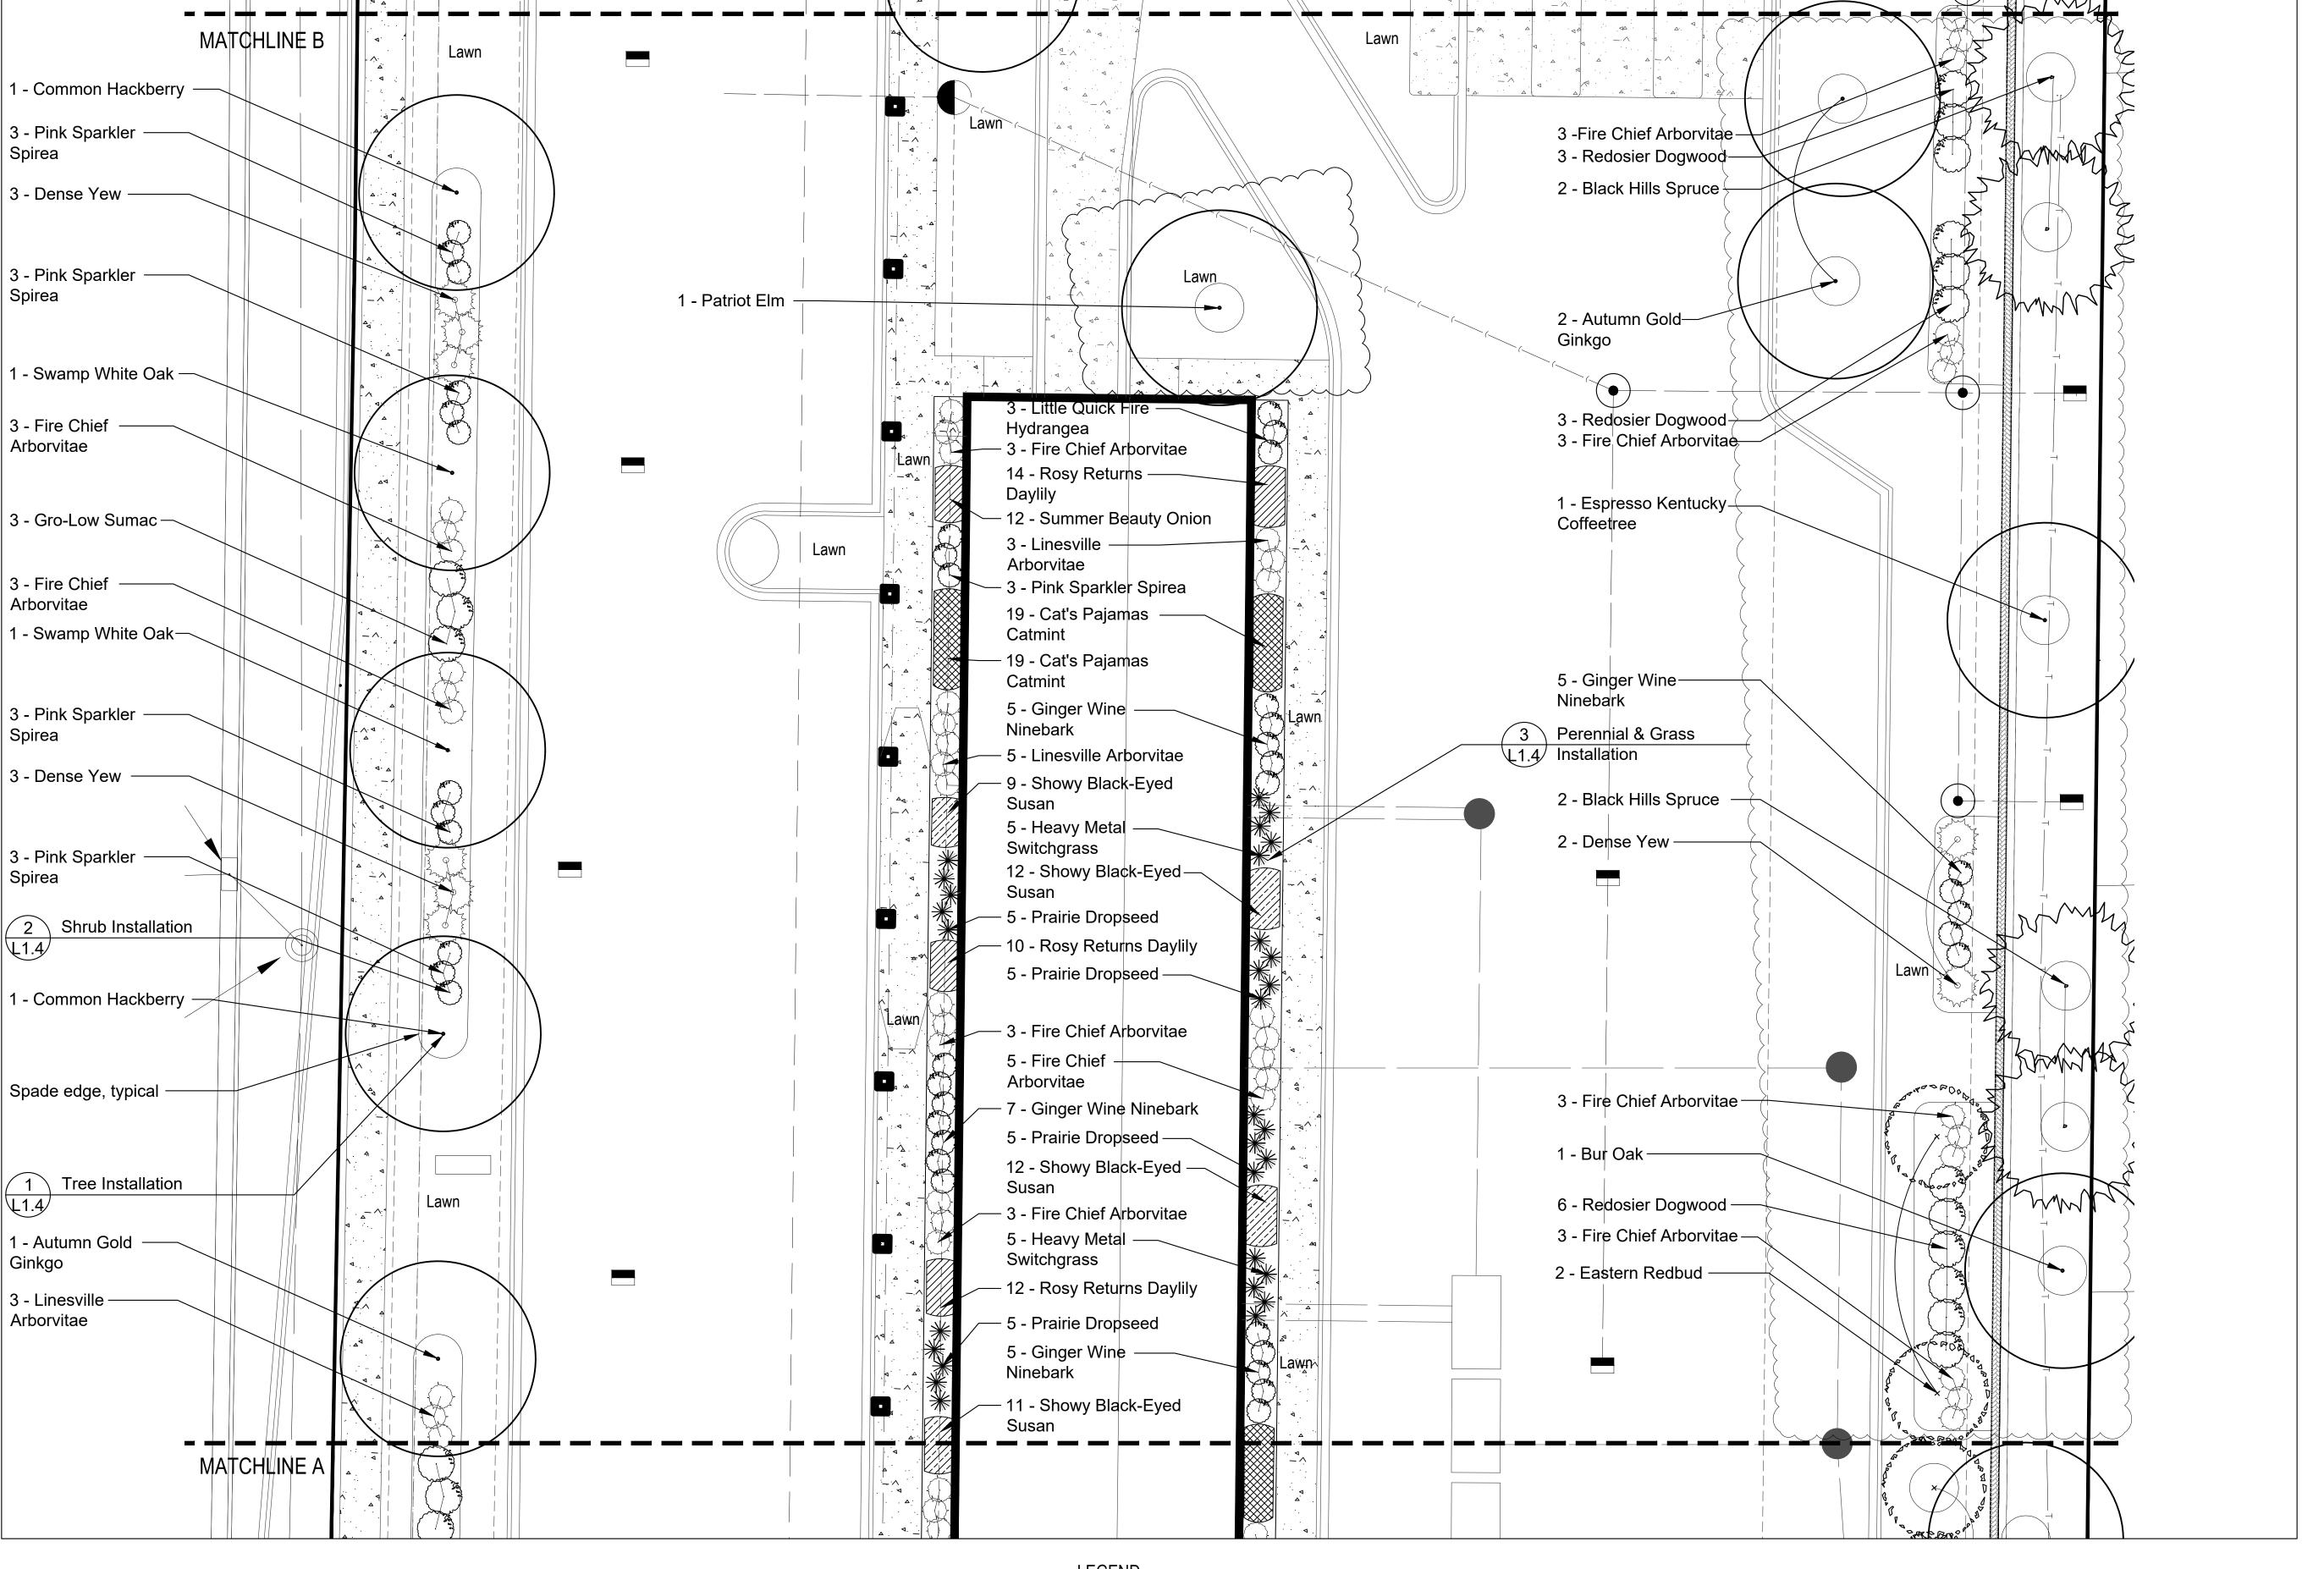
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	Resubmittal	02MAR2023


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LD/MO Resubmittal 10AUG2023

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Jet Brite Car Wash

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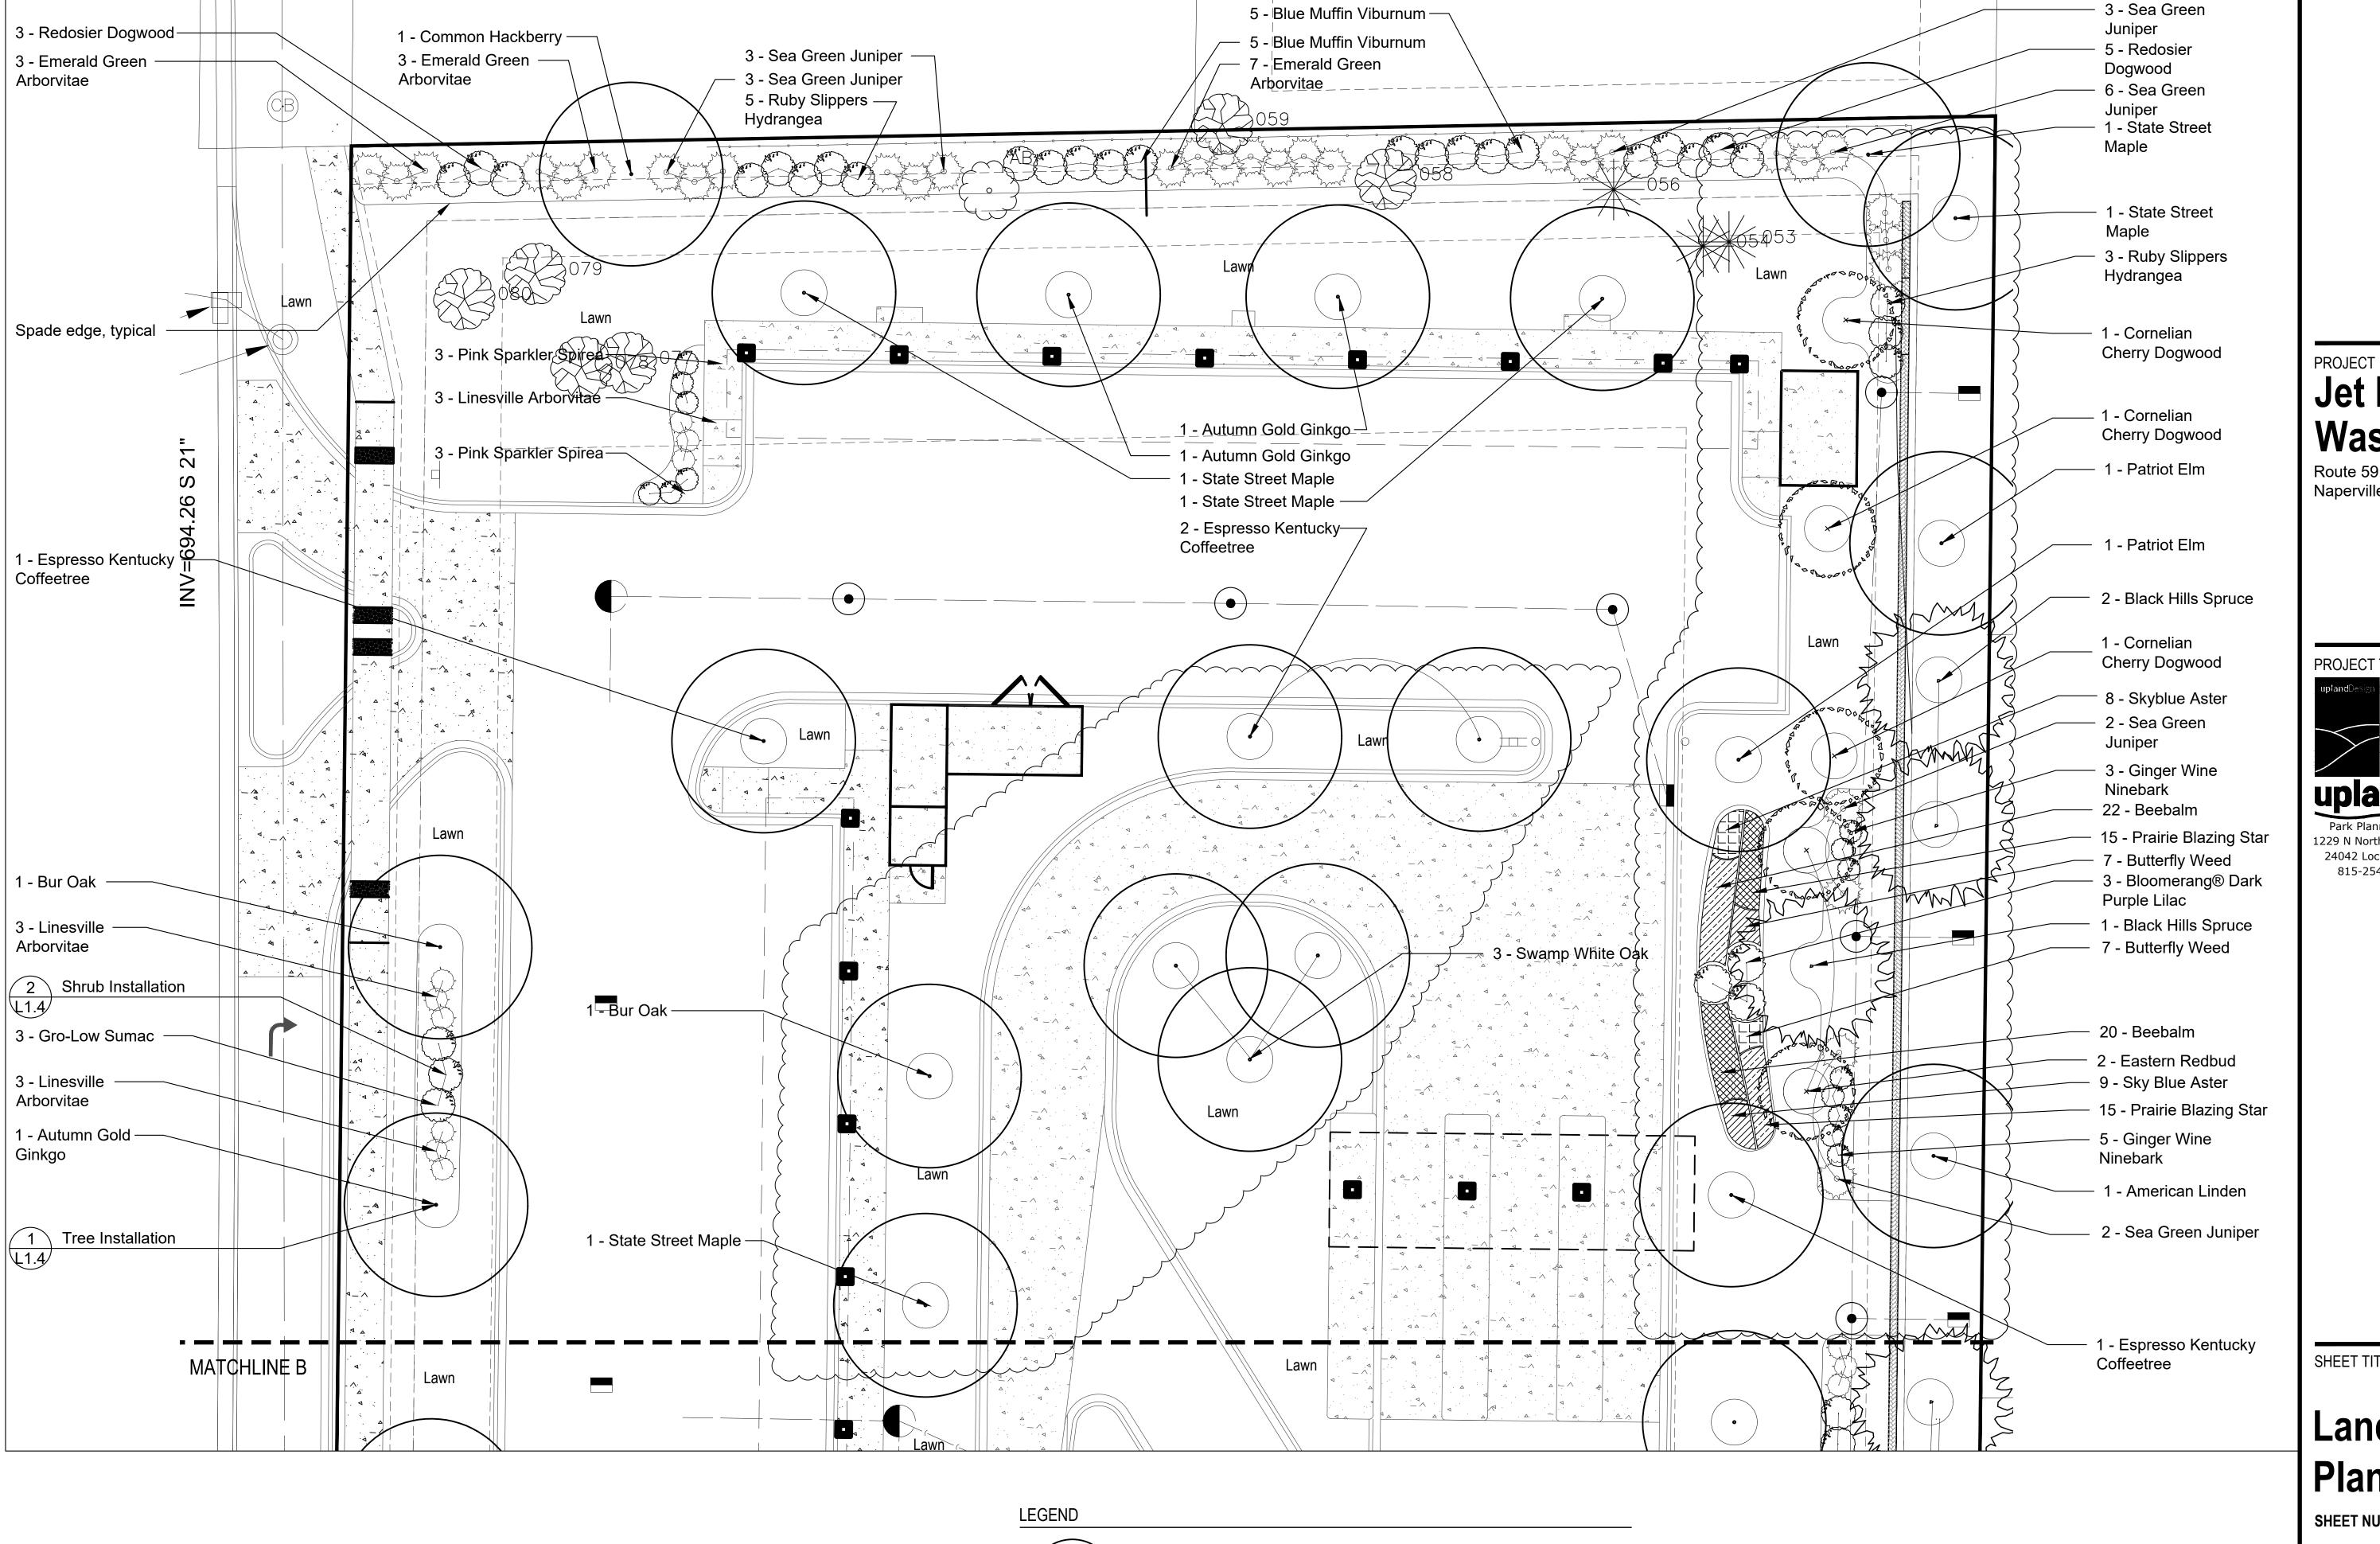
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LD	Resubmittal	02MAR2023		
LD/MO	Resubmittal	12JULY2023		
LD/MO	Resubmittal	10AUG2023		
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Shade Tree

Ornamental Tree

Ornamental Grass

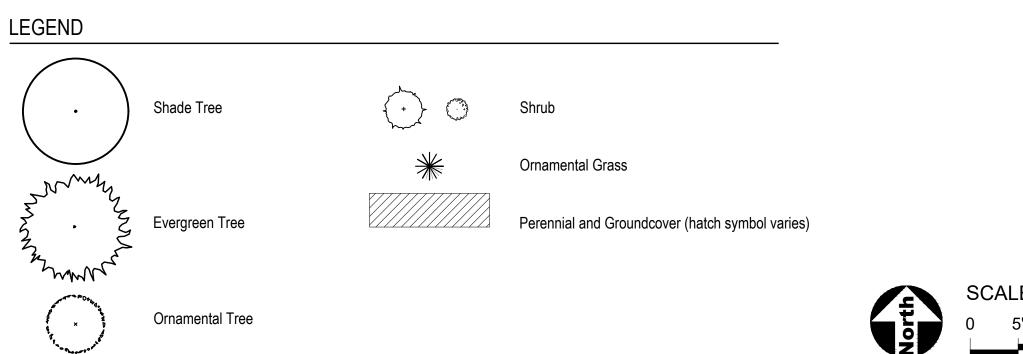Jet Brite Car Wash

Route 59 and 83rd Street Naperville, Illinois 60564

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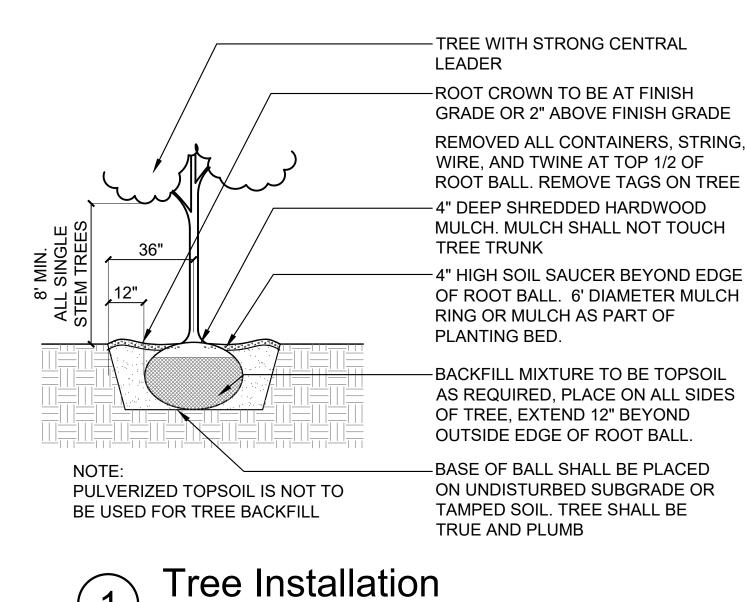
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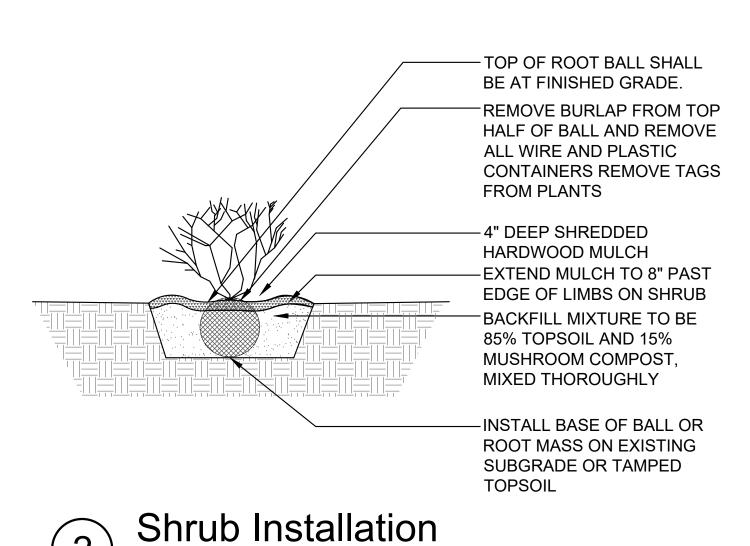
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Resubmittal	10AUG2023
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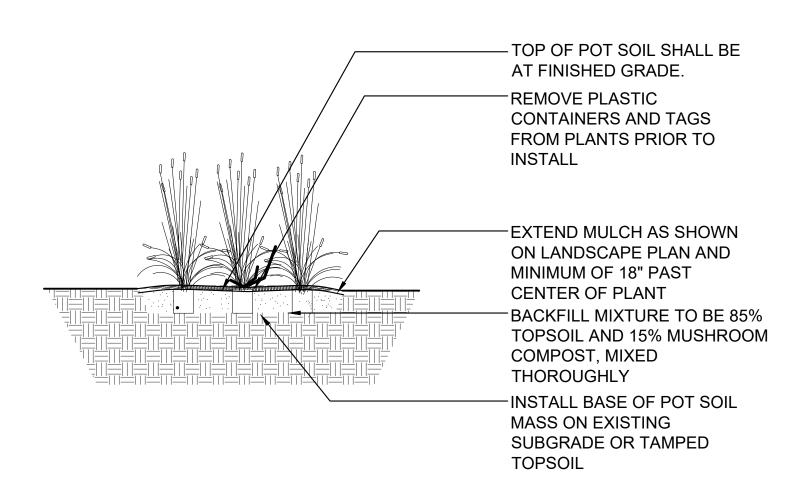
Perennial and Groundcover (hatch symbol varies)





d-plant-tree 12

d-plant-shrub_12




Perennial & Ornamental Grass Installation


SCALE: 1" = 1'-0"


d-perennials

REQUIREMENT CHART

	ening and Tree Preservation 3	.2.3. Parkway frees	1	•
Location/Distance	Requirement	Calculations	Proposed Trees	
IL Route 59: 438' 56' Entry Drive	1 shade tree per 40'	(438'-56')/40'= 9.55 Parkway Trees	10 Shade Trees	
83rd Street: 211' 26' Entry Drive	1 shade tree per 40'	(211'-26')/40'= 4.62 Parkway Trees	5 Ornamental Trees due to overhead wires	
Chapter 10 Landscape, Scre	ening and Tree Preservation 4	I.1. Perimeter Landscaping Trees		
Location/Distance	Requirement	Calculations	Proposed Trees	Proposed Shrubs
Property Line: 1337' 56' Entry Drive 26' Entry Drive	1 Shade tree per 70'	(1337'-82')/70'= 17.9 Perimeter Trees	18 Shade Trees	
Chapter 10 Landscape, Scre	ening and Tree Preservation 4	I.2.1. Foundation Plantings		
Location/Distance	Requirement	Calculations		Proposed Shrubs
Plantable Foundation: 344'	2' wide planting bed minimum	344'*2'= 688 sq ft of planting beds		62
Chapter 10 Landscape. Scre	ening and Tree Preservation 4	I.3.2. Nonresidential Adjacent to Reside	ential Rear Yards	
Location/Distance	Requirement	Calculations		Proposed Shrubs
North side of Property	Continuous landscape			
Line: 215'	buffer 6' height minimum	215' = continuous 6' minimum shrubs		48 Shrubs
	ening and Tree Preservation 5	5.1.1. Parking Lot Landscaping Interior		
Location/Distance	Requirement	Calculations	Proposed Trees	
Parking Lot Islands	more than 20 adjacent parking spots in a single row. Islands to be minimum 130' sq and 1 Shade Tree per 130' square of landscape island. Minimum 50% of landscape island to be planted with groundcover, shrubs, or turf grass. No taller than 30".	5 islands*1 shade tree = 5 Shade Trees	5 Shade Trees	
Chapter 10 Landscape, Scre	ening and Tree Preservation 5	5.2.3.2. Perimeter Parking Lot Landscapi	ng Across from Nor	nresidential Proper
Location/Distance	Requirement	Calculations		Proposed Shrubs
West Parking Lot Perimeter: 283'	5' wide planting bed minimum at 50% of parking lot	283'*50%= 141.5' of 5' wide planting bed		45 Shrubs
Chapter 10 Landscape, Scre	ening and Tree Preservation 5	i.2.4.1. Perimeter Parking Lot Landscapi	ng Abutting Reside	ntial Property
Location/Distance	Requirement	Calculations	Proposed Trees	Proposed Shrubs
North Side Parking Lot Perimeter: 131'	5' wide planting bed minimum at 50% of parking lot. 6' tall plants minimum 50% Evergreen 50% Deciduous Shrubs And 1 Shade Tree Per 35'	131'*50% = 65.5' of 5' wide planting bed, 6' tall shrubs 131'/35'= 3.7 Parking Perimeter Trees	4 Shade Trees	Met with 4.3.2. Nonresidential Adjacent to Residential Rea Yards landscape buffer
Chapter 10 Landson Con	poning and Trop Breas with a C	S Seventing of Source Duling		\\\\
Chapter 10 Landscape, Scre Location/Distance	ening and Tree Preservation 6 Requirement	5. Screening of Service Drives		Proposed Shrubs
East Side Service Drive Adjacent to Residential: 446'	100% Screened by 6' board on board fence. No additional landscaping shall	446' of Board on Board Fence Additional 50% shrubs provided along fence		Additional: 83 Shr

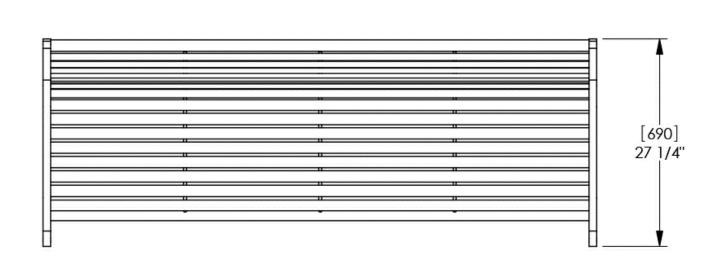

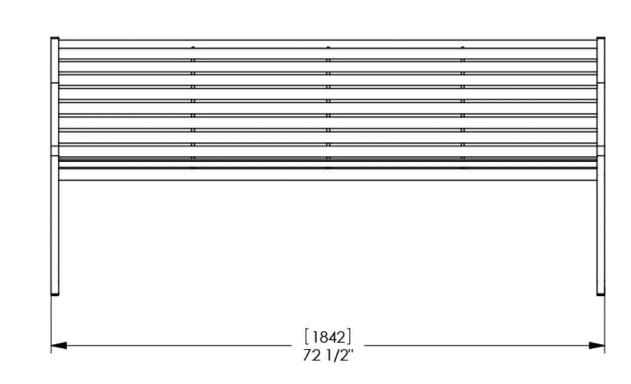

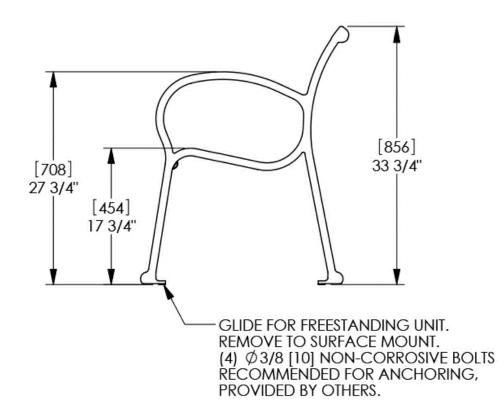

PLANT LIST

QTY

5 |2.5" cal.

5 2.5" cal.

7 2.5" cal.

6 2.5" cal.

7 2.5" cal.

4 2.5" cal.

4 2.5" cal.

4 2.5" cal.

7 |2.5" cal.

8 |6' ht.

3 |6' ht.

5 |6' ht.

16

126

127

24 #1 Cont.

27 #1 Cont.

16 #1 Cont.

50 #1 Cont.

45 #1 Cont.

84 #1 Cont.

76 #1 Cont.

44 #1 Cont.

10 #1 Cont.

20 #1 Cont.

34 #1 Cont.

396

42

SIZE

Evergreen Trees - Balled and Burlap

Ornamental Trees - Balled and Burlap

Evergreen Shrubs - Balled and Burlap or Pot

Deciduous Shade Trees - Balled and Burlap

BOTANICAL NAME

Acer miyabei 'Morton'

Quercus macrocarpa

Picea Glauca 'Densata'

Cercis canadensis

Ostyra virginiana

Cornus mas

19 | 36" ht. x 36" wt. | Juniperus chinesis 'Sea Green'

13 24" ht. x 24" wt. Thuja occidentalis 'Emerald Green'

12 | 18" ht. x 18" wt. | *Hydrangea paniculata 'SMHPLQF'*

10 24" ht. x 24" wt. | Hydrangea quercifolia 'Ruby Slippers'

Allium 'Summer Beauty'

Hemerocallis 'Rosy Returns'

Monarda didyma 'Rasberry Wine'

Nepeta racemosa 'Cat's Pajamas'

Rudbeckia fulgida var. speciosa

|Panicum virgatum 'Heavy Metal'

Symphyotrichum oolentangiense

Asclepias tuberosa

Liatris pycnostachya

Sporobolus heterolepis

Dalea purpurea

12 | 36" ht. x 36" wt. | *Taxus x media 'Densiformis'*

45 24" ht. x 24" wt. | Thuja occidentalis 'Fire Chief'

31 24" ht. x 24" wt. | Thuja occidentalis 'Linesville'

Deciduous Shrubs - Balled and Burlap or Pot
20 24" ht. x 24" wt. | Cornus sericea 'Isanti'

33 24" ht. x 24" wt. Physocarpus opulifolius

6 | 18" ht. x 18" wt. | *Syringa*

Perennials and Ornamental Grasses - Pot

9 24" ht. x 24" wt. | Rhus aromatica 'Grow Low

24 | 18" ht. x 18" wt. | Spiraea betulifolia 'COURISPIO1'

13 | 36" ht. x 36" wt. | Viburnum dentatum 'Christom'

6 36" ht. x 36" wt. | Taxus x media 'Tauntonii'

Ginkgo biloba 'Autumn Gold'


Gymnocladus dioicus 'Espresso'


Celtis occidentalis

Quercus bicolor

Tilia americana

Ulmus x 'Patriot'

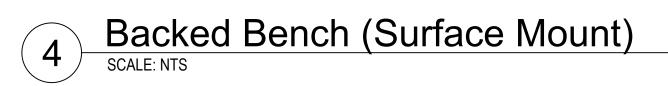

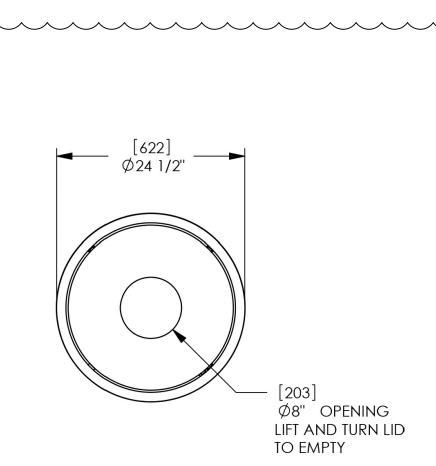

COMMON NAME

State Street Maple

Common Hackberry

Swamp White Oak

American Linden

Black Hills Spruce

Eastern Redbud

Sea Green Juniper

Fire Chief Arborvitae

Linesville Arborvitae

Redosier Dogwood

Little Quick Fire Hydrangea

Bloomerang Dk Purple Lilac

Ruby Slippers Hydrangea

Ginger Wine Ninebark

Pink Sparkler Spirea

Blue Muffin Viburnum

Summer Beauty Onion

Purple Prairie Clover

Rosy Returns Daylily

Cat's Pajamas Catmint

Showy Black-Eyed Susan

Heavy Metal Switchgrass

Prairie Dropseed

Skyblue Aster

Prairie Blazing Star

Beebalm

Butterfly Weed

Gro-Low Sumac

Ironwood

Dense Yew

Taunton Yew

Cornelian Cherry Dogwood


Emerald Green Arborvitae

Bur Oak

Patriot Elm

Autumn Gold Ginkgo

Espresso Kentucky Coffeetree

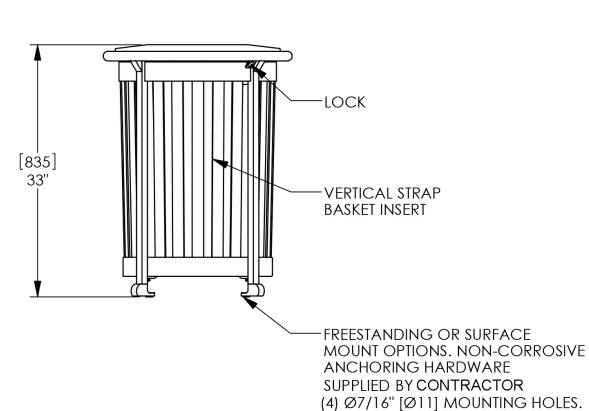

5 Trash Receptacle (Surface Mount)

SCALE: NTS

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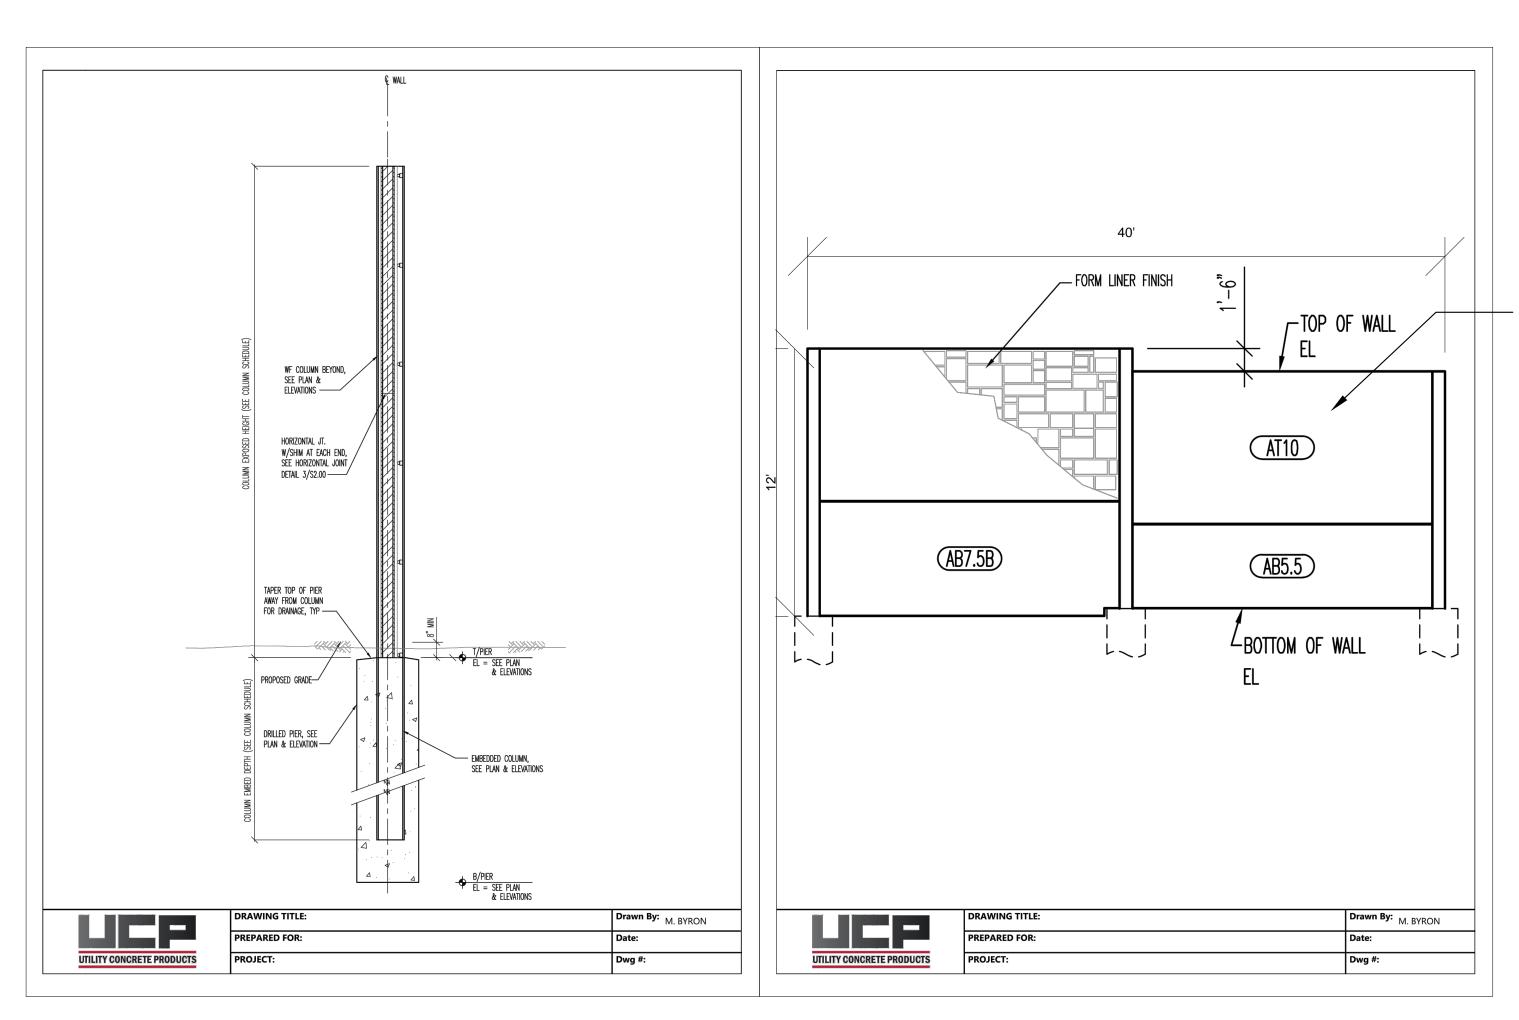
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- COLOR: IDOT TAUPE BY SHERMAN WILLIAMS



NOTE:

 DETAIL FOR PLANNING REVIEW ONLY. NOT FOR CONSTRUCTION. STRUCTURAL DESIGN BY OTHERS.

12' Sound Wall
SCALE: NTS

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