GEOMETRIC AND PAVING NOTES (GENERAL):

THE DEVELOPER AND CONTRACTOR SHALL HAVE THE RESPONSIBILITY TO ADEQUATELY PROTECT THE PAVEMENT AND PROPERTY, CURB AND GUTTER AND OTHER RIGHT-OF-WAY IMPROVEMENTS, WHETHER NEWLY CONSTRUCTED OR EXISTING, FROM ANY AND ALL DAMAGE, SUFFICIENT MEANS SHALL BE EMPLOYED BY THE CONTRACTOR TO PROTECT AGAINST SUCH DAMAGE TO THE SATISFACTION OF THE CITY ENGINEER.

ANY NEW OR EXISTING IMPROVEMENTS THAT ARE DAMAGED SHALL BE REPAIRED OR REPLACED IN A MANNER THAT IS SATISFACTORY TO THE CITY ENGINEER.

THE CONTRACTOR AND/OR DEVELOPER SHALL SECURE ALL NECESSARY RIGHTS AND PERMISSIONS TO PERFORM ANY WORK ON PRIVATE PROPERTY NOT WITHIN THE OWNERSHIP RIGHTS OF THE DEVELOPER. THE DEVELOPER SHALL BEAR THE SOLE RESPONSIBILITY FOR DAMAGES THAT MAY OCCUR AS A RESULT OF WORK PERFORMED UNDER CONTRACTS THEY INITIATE.

THE CONTRACTOR/DEVELOPER WILL BE RESPONSIBLE FOR BRINGING PAVEMENTS (STREET, CURB AND GUTTER, SIDEWALK, DRIVEWAY) ON THE PROPERTY UP TO CITY STANDARDS INCLUDING ANY REPAIRS TO SUBSTANDARD PAVEMENTS THAT EXISTED PRIOR TO OR OCCURRED DURING CONSTRUCTION.

WHEREVER NEW WORK WILL MEET EXISTING CONDITIONS OTHER THAN LAWN AREAS, REGARDLESS OF WHETHER THE NEW OR EXISTING WORK IS ASPHALT OR CONCRETE, THE EXISTING ADJACENT SIDEWALK, DRIVEWAYS, PAVEMENT OR CURB SHALL BE NEATLY SAW CUT. THE SAW CUT SHALL BE IN A NEAT STRAIGHT LINE SUFFICIENTLY DEEP SO THAT IT RENDERS A SMOOTH VERTICAL FACE TO MATCH TO. IF THE CONTRACTOR IS NOT CAREFUL OR DOES NOT SAW DEEP ENOUGH AND THE CUT LINE BREAKS OUT OR CHIPS TO AN IMPERFECT EDGE, THEN THE EXISTING SIDE MUST BE RE-CUT SQUARE AND DONE OVER UNTIL IT IS

CITY OF NAPERVILLE, IL ZONING ANALYSIS					
	REQUIRED	PROVIDED/EXISTING			
ZONED	B-3	B-3			
MAX. LOT AREA	-	6.40 Acres			
MAX. BUILDING HEIGHT	-	-			
MIN. LOT AREA	-	215,099 ft²			
MIN. LOT WIDTH	-	-			
MAX. BUILDING COVERAGE (FAR)	32.5% (73,891 ft²)	-% (64,945 ft²)			
Building Setback	70' € or 20' R.O.W	94.9' & 126.8' *			
Fuel Dispenser Setback (Front & Side)	15'	21.1' / 50.2' *			
Parking Setback	5'	5.0'			
PARKING					
Auto Service Station (4.5 spaces / 1,000 ft²)	5,259 / 1000 x 4.5 = 24	73 Spaces			
Retail/General (4 spaces / 1,000 ft²)	33,500 / 1000 x 4 = 134	245 Spaces			
STACKING					
Carwash	10 Enter & 2 Exit	Compliant			

*	Existing Condition.
-	Condition Use Required for Car
	Services in B-3 District.
-	Administrative Subdivison Plat -
	Shift in Property Line.
-	Cross Access Agreement required
	between two properties.
-	By-Pass lane provided after Prep
	Hut >10ft wide - No Variance
	required.

Legend							
Water Line Ss—SS—SS—Sanitary Sewer Main Storm Sewer MH/Open Lid ME M Storm Sewer MH/Open Lid ME M Storm Sewer MH/Open Lid ME M Water Meter Light Pole or Traffic Light Wh Storm Sewer Manhole No Storm Sewer Manhole	Pavement Match Existing Grade point Number of Parking Spaces Be Removed Proposed Concrete Walk/Pavement Proposed Asphalt						

THESE DOCUMENTS ARE THE EXCLUSIVE PROPERTY OF NEIKIRK ENGINEERING, LLC AND THEREBY PROTECTED UNDER COPYRIGHT LAWS. ALL ORIGINAL DESIGNS, SPECIFICATIONS AND IDEAS REPRESENTED HERE ARE FOR THE SOLE USE OF THIS PROJECT AND SHALL NOT BE REPRODUCED OR ALTERED IN ANY MANNER WITHOUT THE WRITTEN CONSENT OF NEIKIRK ENGINEERING, LLC. Copyright 2021 Neikirk Engineering, LLC. All rights reserved.

REVISIONS

DATE

DESCRIPTION

 PERMITTING SET	04/16/21
REV 1	08/11/21
REV 3	10/22/21



Civil Engineers • Land Surveyors

306 N. Market St., Mt. Carmel, IL 62863 Phone: (618) 263-4100 www.neikirkengineering.com

SCALE.	1 =40
DRAWN BY:	RM, TL
DESIGNER:	TJL,RM
CHECKED BY:	TJL
ENGINEER:	MICHAEL E. NEIKIRK
ARCHITECT:	-
OWNER:	BENDERSON DEVELOPMENT

EXP: 11/30/2021 62053893 REGISTERED PROFESSIONAL ENGINEER

CERTIFIED BY


DELTA SONIC 1780 N. AURORA RD. NAPERVILLE, IL


DRAWING TITLE

OVERALL SITE PLAN

FILE LOCATION

C2.0

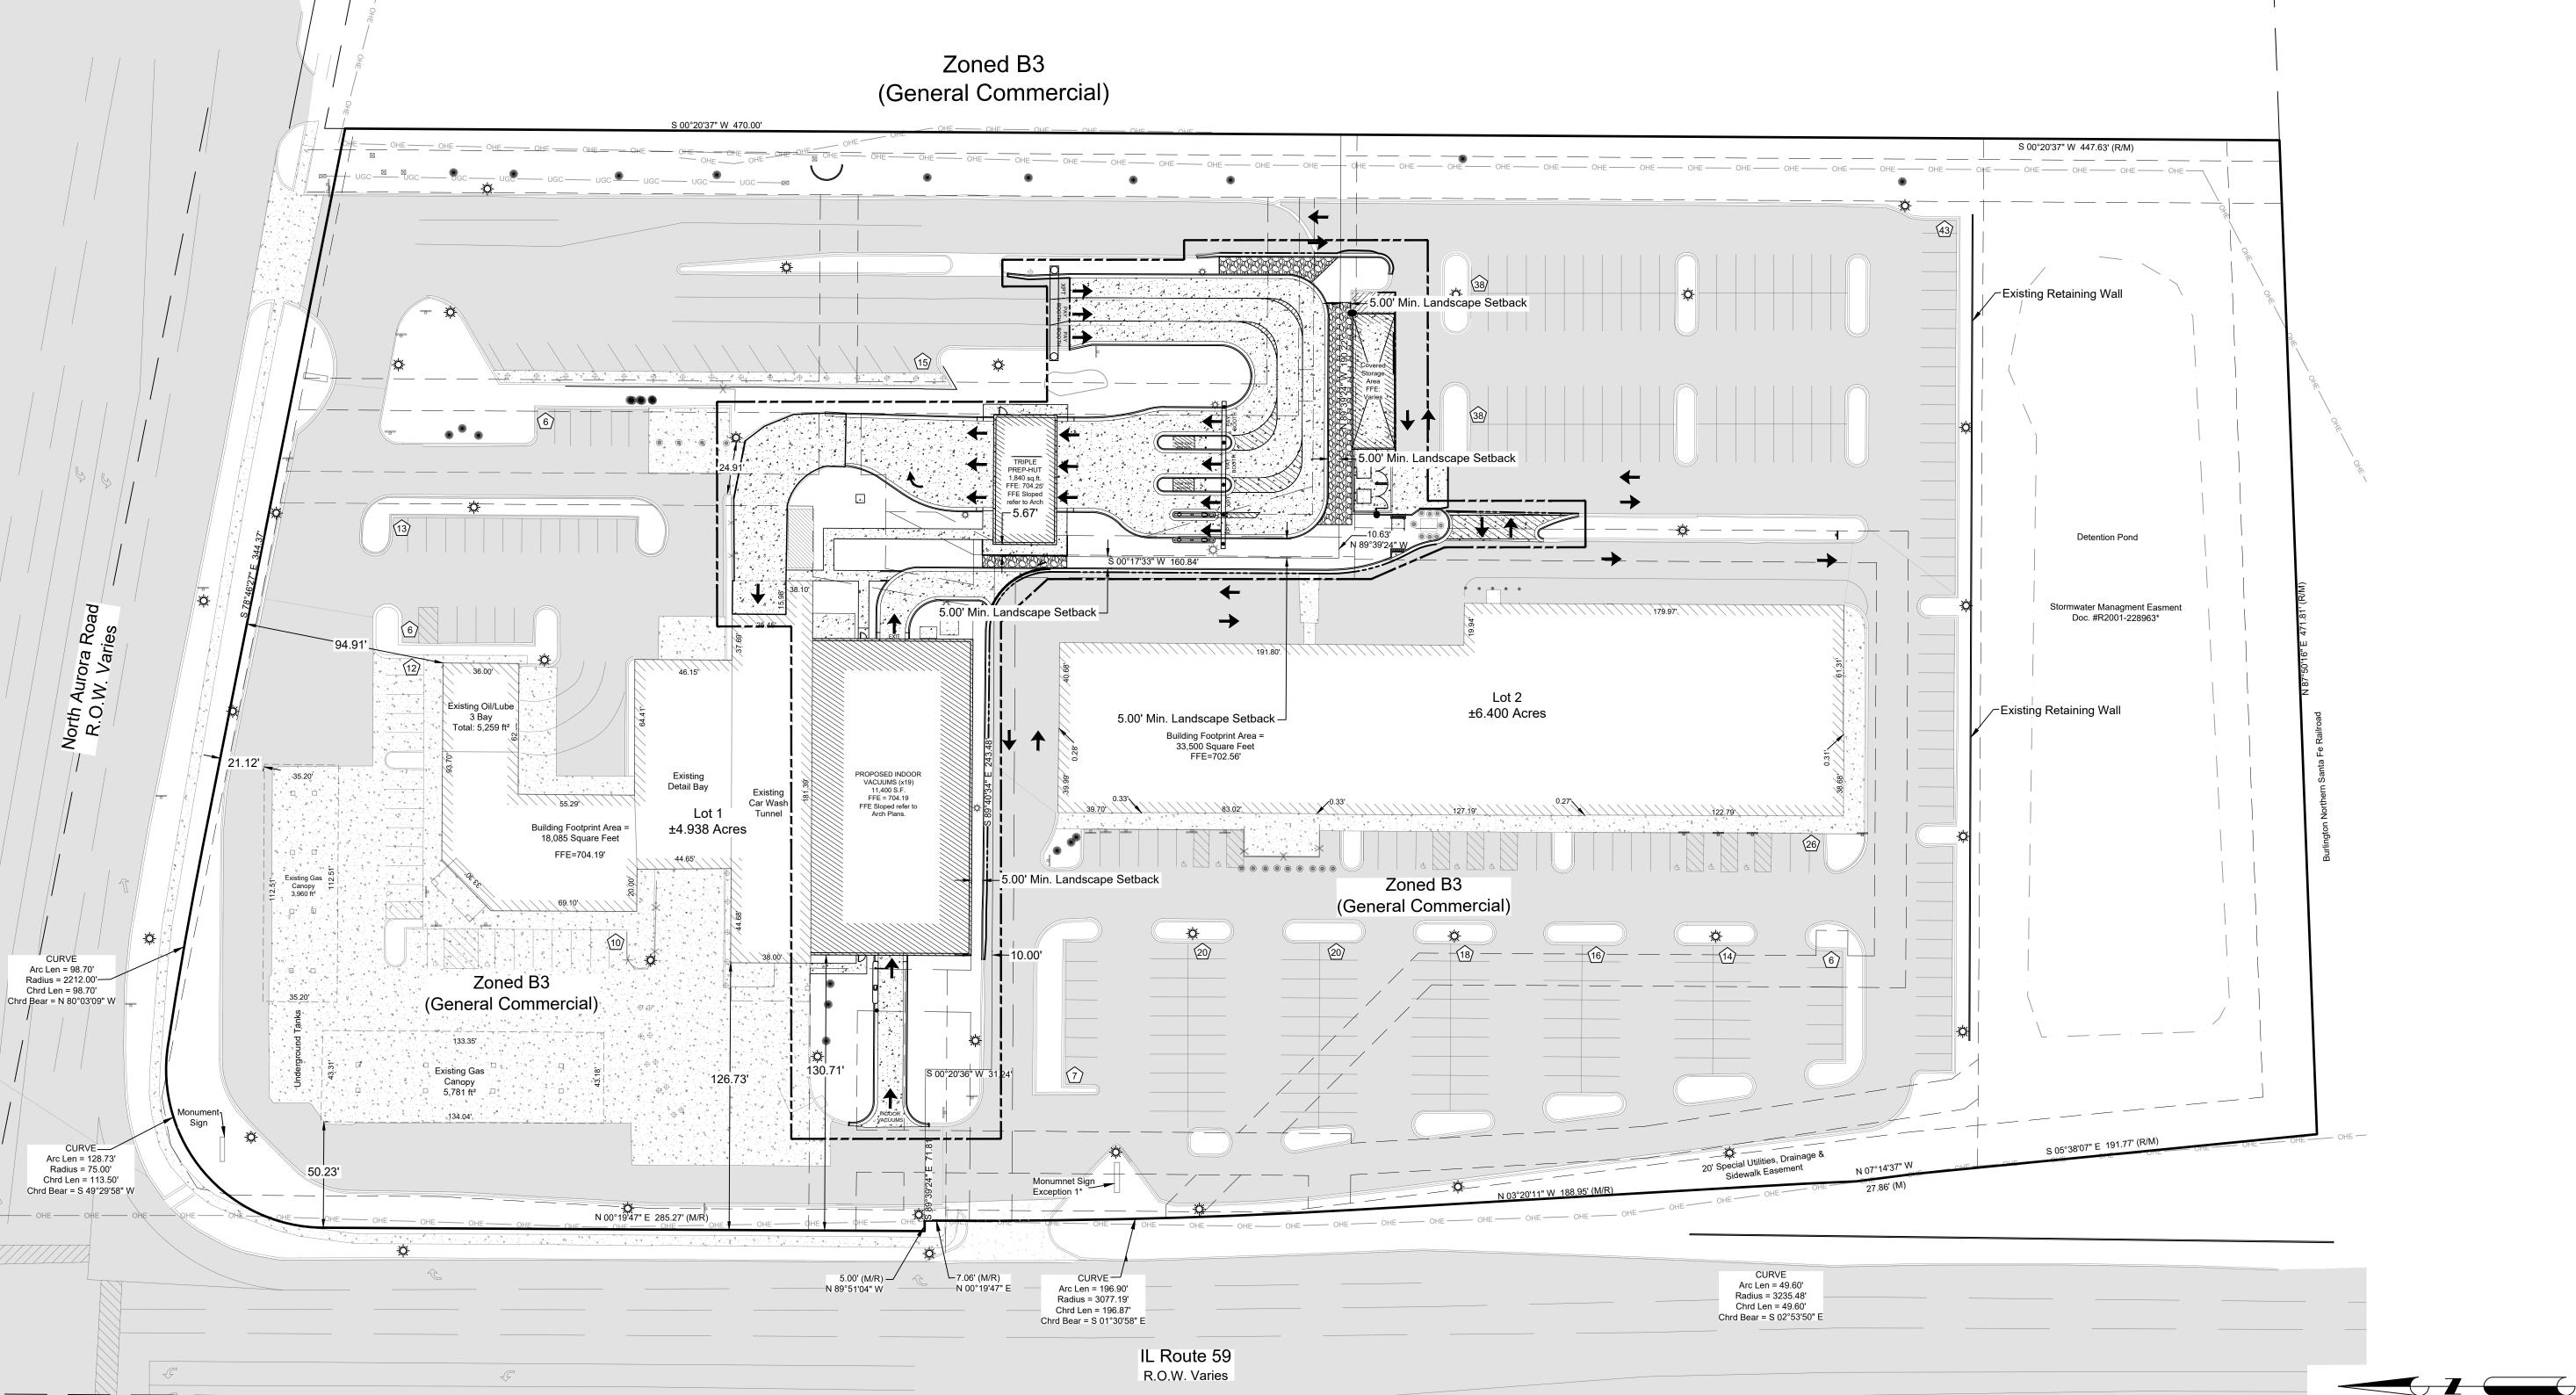

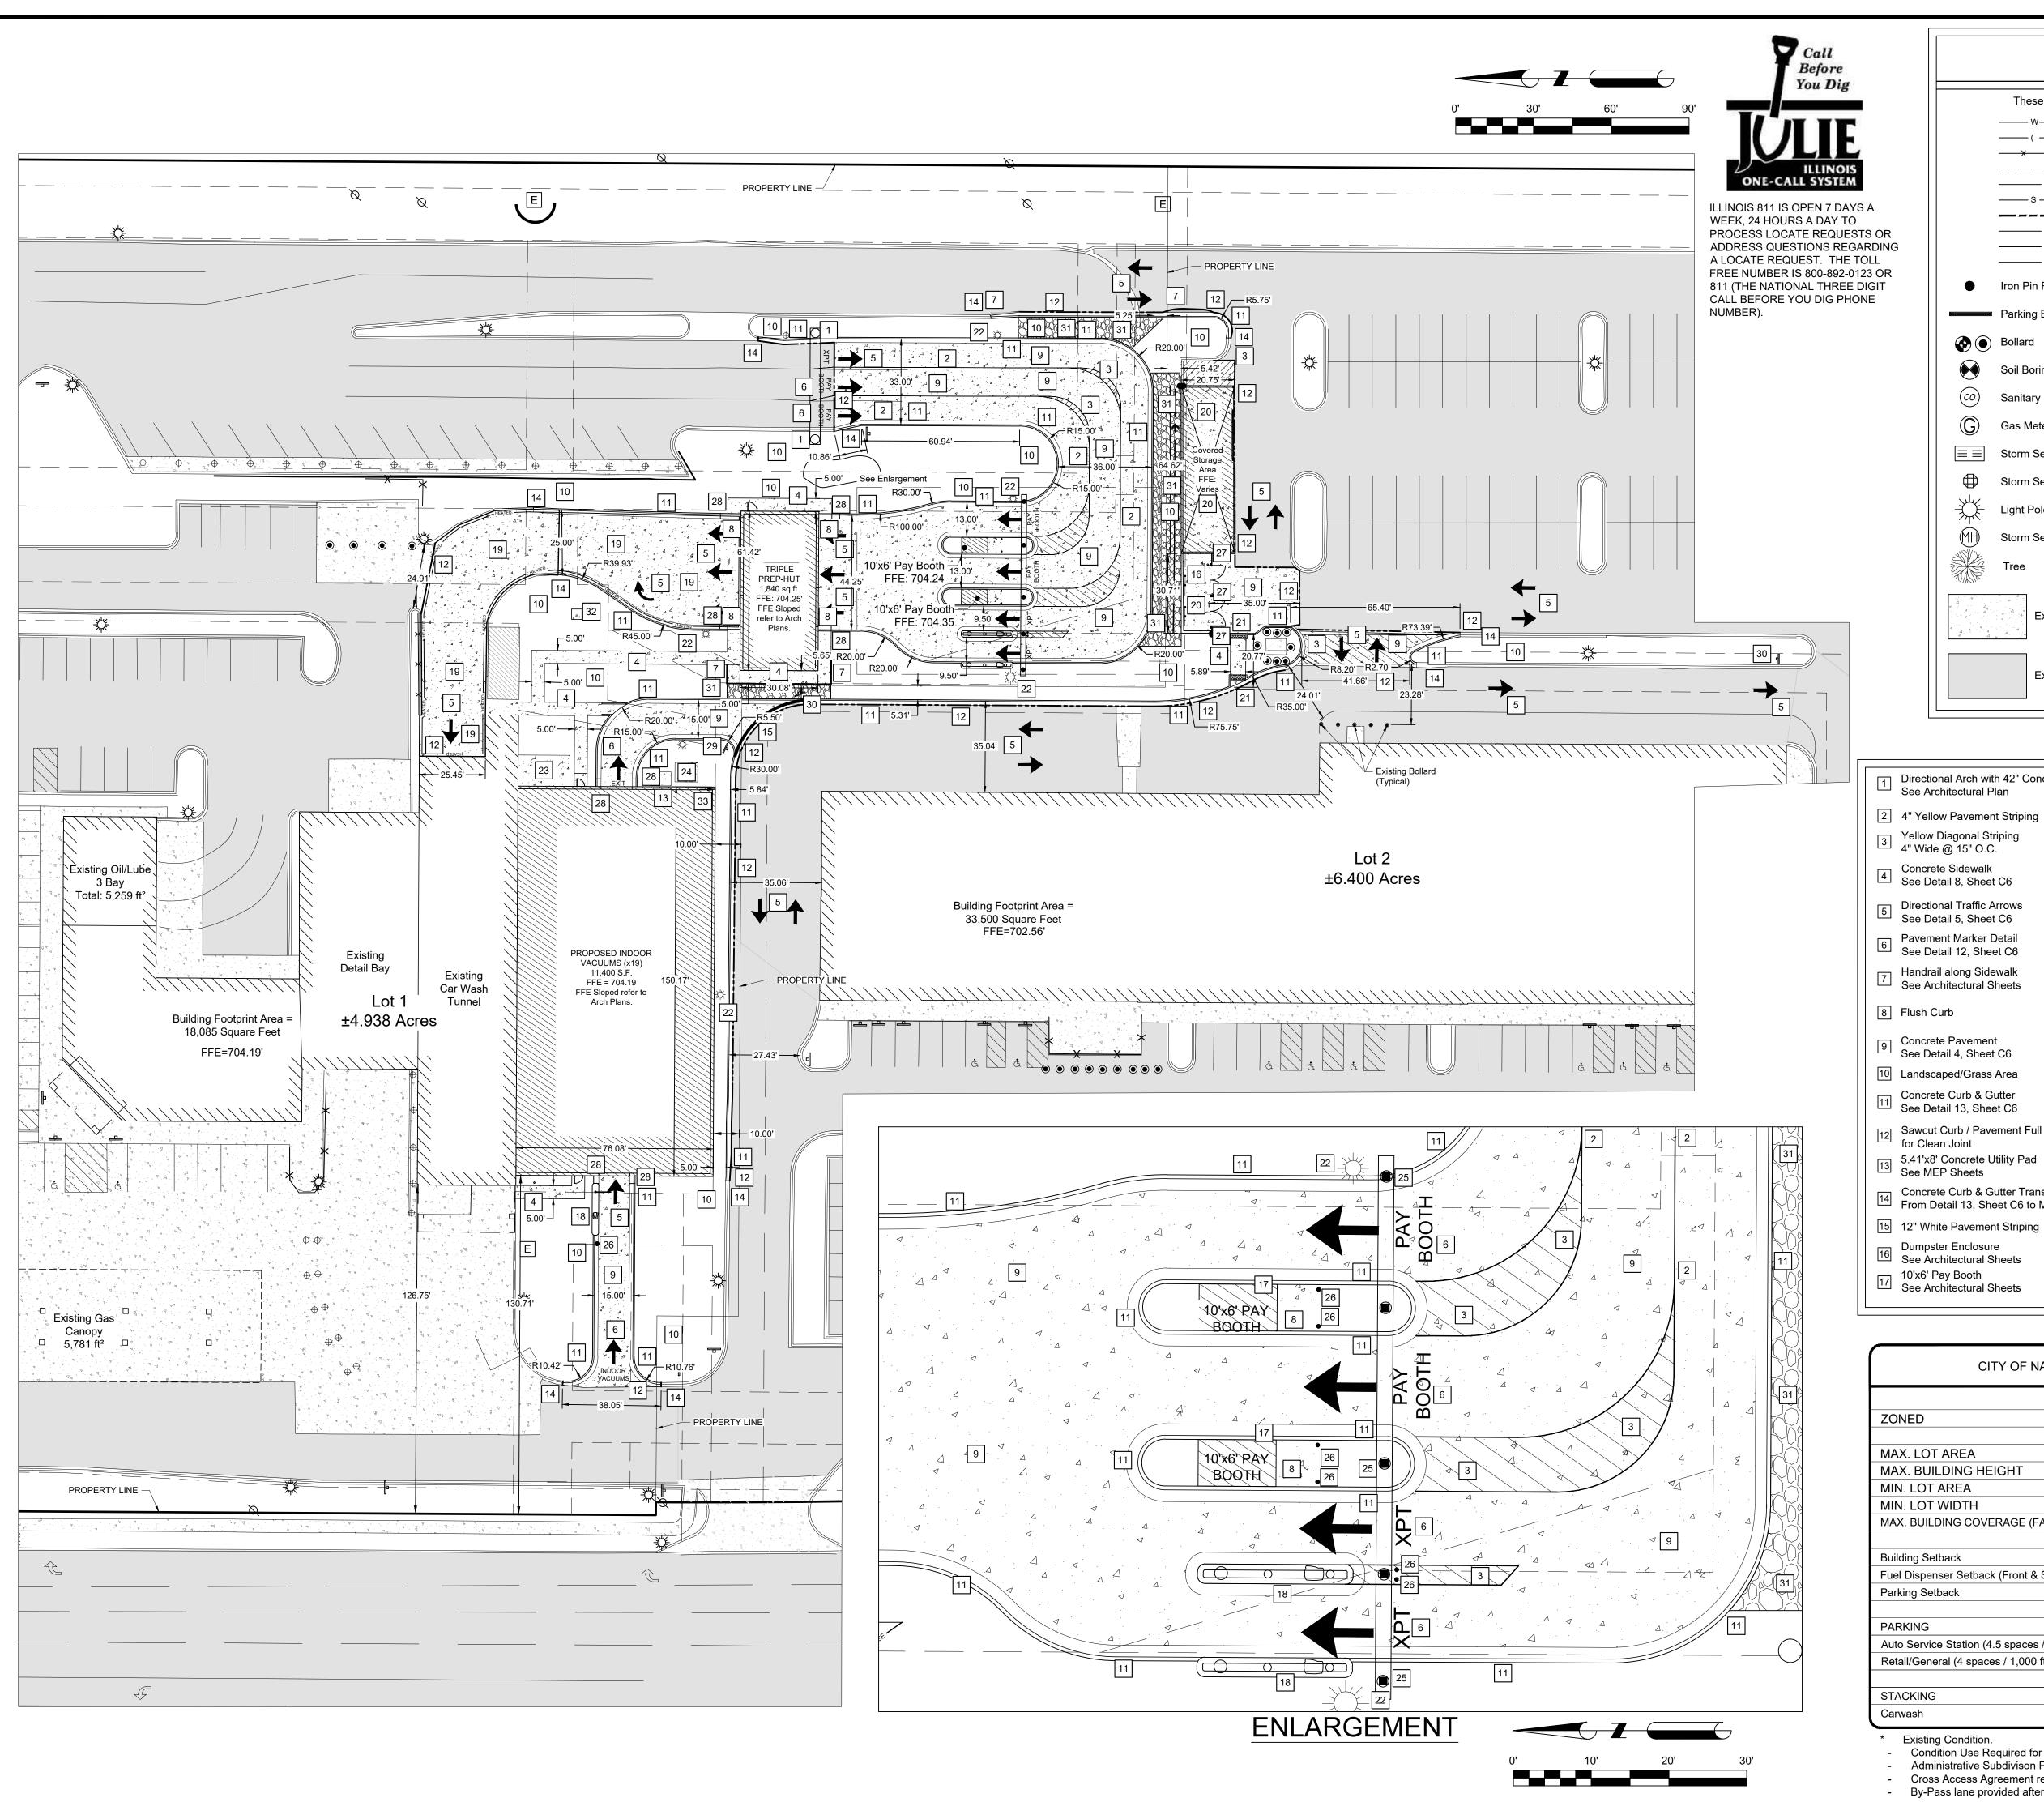

Legend

	These standard symbols may be found in the drawing.						
		-	· W W	Water Line			
			((Sanitary Sewer Main			in
			—		Fence		
			— 470 — — — — — UGE ———		sting Cont derground		ric
			s —— s ——		rm Sewer		
				Lim	nits of Impr	ovem	ents
			— OHE ———	Ov	erhead Uti	lity Lir	nes
			— GAS ——		s Lines		
			— UGC ———	Un	derground	Cable	
	•	Iron F	Pin Found			Sani	tary Sewer Manhole
		Parkii	ng Bumper		ط	Sign	
	• •	Bollar	rd			Wate	er Meter
		Soil B	oring Location		\bowtie	Wate	er Valve
	co	Sanita	ary Sewer Cleanout		\varnothing	Utilit	y Pole
	©	Gas N	Meter		TBR	To E	Be Removed
		Storm	Sewer Curb Inlet		TC	Тор	of Curb
	\bigoplus	Storm	Sewer MH/Open Lid		PV	Pave	ement
	举	Light	Pole or Traffic Light		ME	Mato	ch Existing
	MH	Storm	Sewer Manhole	<u>47</u>	0.0	Grad	de point
		Tree			30	Num	ber of Parking Spaces
√	A A A A A A A A A A A A A A A A A A A	4 A A	Existing Concrete		4 4 4 4 4 4 4 4 4 4 4 4 4 4 4 4 4 4 4 4	4	Proposed Concrete Walk/Pavement
			Existing Pavement				Proposed Asphalt

REVISIONS

THESE DOCUMENTS ARE THE EXCLUSIVE PROPERTY OF NEIKIRK ENGINEERING, LLC AND THEREBY PROTECTED UNDER COPYRIGHT

LAWS. ALL ORIGINAL DESIGNS, SPECIFICATIONS AND IDEAS REPRESENTED HERE ARE FOR THE SOLE USE OF THIS PROJECT AND SHALL NOT BE REPRODUCED OR ALTERED IN ANY MANNER WITHOUT THE WRITTEN CONSENT OF NEIKIRK ENGINEERING, LLC. Copyright 2021 Neikirk Engineering, LLC. All rights reserved.

NO.	DESCRIPTION	DAT
F	PERMITTING SET	04/16/21
F	REV 1	08/11/21
F	REV 3	10/22/21

<u>Keynotes</u>						
1 1 1 1 1	I Arch with 42" Concrete Bases tectural Plan	18	XPT Unit - See Detail 13, Sheet C6 Refer to Arch Plans for Full Details			
Vollow Die	Pavement Striping	19	Concrete Pavement - Snow Melt Section with Xypex Mix. (Only for heated conc.) See Detail 3, Sheet C6			
4" Wide @) 15" O.C.	20	Concrete Apron for Dumpster and Storage Building. See Architectural Sheets			
Directions	l 8, Sheet C6 I Traffic Arrows	21	24" Wide Detectable Warning See Detail 11, Sheet C6			
See Detai	I 5, Sheet C6 Marker Detail	22	Relocated Light Poles See Detail 6, Sheet C6			
See Detai	I 12, Sheet C6 long Sidewalk	23	12'x20' Vacuum Motor Pad See MEP Sheets			
	tectural Sheets	24	8'x8' Electric Transformer Pad See MEP Sheets			
8 Flush Curb		25	Camera Arch with 18" Concrete Bases See Architectural Plans			
	4, Sheet C6	26	4" Bollard See Detail 10, Sheet C6			
Concrete 0	ed/Grass Area Curb & Gutter	27	6" Bollard See Detail 10, Sheet C6			
See Detail	13, Sheet C6 urb / Pavement Full Depth	28	3' Transitional Curb from 0" height to 6"			
for Clean of the formula of the form	oncrete Utility Pad	29	Stop Sign See Detail 7, Sheet C6			
Concrete	Curb & Gutter Transition	30	Do Not Enter Sign See Detail 7, Sheet C6			
	ail 13, Sheet C6 to Match Existing Pavement Striping	31	Decorative Stone/Riprap on Slope Manifold Box - 4'x4' Heated Concrete Pad			
Dummeter	Englosuro		See Detail 19, Sheet C6			

_	<u>Keynotes</u>							
	1	Directional Arch with 42" Concrete Bases See Architectural Plan	18	XPT Unit - See Detail 13, Sheet C6 Refer to Arch Plans for Full Details				
	2	4" Yellow Pavement Striping	19	Concrete Pavement - Snow Melt Section with Xypex Mix. (Only for heated conc.) See Detail 3, Sheet C6				
	3	Yellow Diagonal Striping 4" Wide @ 15" O.C.		Concrete Apron for Dumpster and Storage				
	4	Concrete Sidewalk See Detail 8, Sheet C6	20	Building. See Architectural Sheets				
		Directional Traffic Arrows	21	24" Wide Detectable Warning See Detail 11, Sheet C6				
	5	See Detail 5, Sheet C6	22	Relocated Light Poles See Detail 6, Sheet C6				
	6	Pavement Marker Detail See Detail 12, Sheet C6	23	12'x20' Vacuum Motor Pad				
		Handrail along Sidewalk	20	See MEP Sheets				
	7	See Architectural Sheets	24	8'x8' Electric Transformer Pad See MEP Sheets				
	8	Flush Curb	25	Camera Arch with 18" Concrete Bases See Architectural Plans				
	9	Concrete Pavement See Detail 4, Sheet C6	26	4" Bollard See Detail 10, Sheet C6				
	10	Landscaped/Grass Area	27	6" Bollard				
	11	Concrete Curb & Gutter See Detail 13, Sheet C6	21	See Detail 10, Sheet C6				
		Sawcut Curb / Pavement Full Depth	28	3' Transitional Curb from 0" height to 6"				
	12	for Clean Joint	29	Stop Sign See Detail 7, Sheet C6				
	13	5.41'x8' Concrete Utility Pad See MEP Sheets	30	Do Not Enter Sign See Detail 7, Sheet C6				
	14	Concrete Curb & Gutter Transition From Detail 13, Sheet C6 to Match Existing	31	Decorative Stone/Riprap on Slope				

306 N. Market St., Mt. Carmel, IL 62863
Phone: (618) 263-4100
www.neikirkengineering.com

Engineering, LLC

Civil Engineers • Land Surveyors

1"=30' / 1"=10'
RM, TL
TJL,RM
TJL
MICHAEL E. NEIKIRK
-
BENDERSON DEVELOPMENT
EXP: 11/30/2021

CERTIFIED BY

DRAWING TITLE

CITY OF NAPERVILLE, IL ZONING ANALYSIS

33 6' High Fence to Screen Vacuum Pads

	REQUIRED	PROVIDED/EXISTING
ZONED	B-3	B-3
MAX. LOT AREA	-	6.40 Acres
MAX. BUILDING HEIGHT	-	-
MIN. LOT AREA	-	215,099 ft ²
MIN. LOT WIDTH	-	-
MAX. BUILDING COVERAGE (FAR)	32.5% (73,891 ft²)	-% (64,945 ft²)
Building Setback	70' € or 20' R.O.W	94.9' & 126.8' *
Fuel Dispenser Setback (Front & Side)	15'	21.1' / 50.2' *
Parking Setback	5'	5.0'
PARKING		
Auto Service Station (4.5 spaces / 1,000 ft²)	5,259 / 1000 x 4.5 = 24	73 Spaces
Retail/General (4 spaces / 1,000 ft²)	33,500 / 1000 x 4 = 134	245 Spaces
STACKING		
Carwash	10 Enter & 2 Exit	Compliant

* Existing Condition.

Condition Use Required for Car Services in B-3 District.
Administrative Subdivison Plat - Shift in Property Line.

Cross Access Agreement required between two properties.
 By-Pass lane provided after Prep Hut >10ft wide - No Variance required.

DELTA SONIC 1780 N. AURORA RD. NAPERVILLE, IL

SITE PLAN

FILE LOCATION DRAWING NUMBER

C2.1