IGNASH RESIDENCE

214 N. LAIRD AVENUE NAPERVILLE, IL SITE IMPROVEMENT PLANS

SUGGESTED CONSTRUCTION SEQUENCE

1. INSTALL SILT & CHAIN LINK FENCE AT LOCATIONS AS INDICATED ON THE PLANS.

2. SITE DEMOLITION AND PREP

3. EXCAVATE AND PREP FOR FINISH INSTALLATIONS..

4. CONSTRUCT HARDSCAPE IMPROVEMENTS PER PLAN.

5. COMPLETE TOPSOIL PLACEMENT AND PERMANENT SEEDING/SODDING AND LANDSCAPING.

6. REMOVE AND PROPERLY DISPOSE OF TEMPORARY EROSION CONTROL MEASURES.

BENCHMARK: (OFF-SITE)

CITY OF NAPERVILLE STATION NO. 705
LOCATED AT THE SW CORNER OF OGDEN AVE. & COLUMBIA
ST

EL = 734.64 NAVD88

SITE BENCHMARK


CROSS CUT IN TOP OF CURB OPPOSITE THE SW CORNER OF LOT 36.


ELEVATION = 703.88 NAVD88

PREPARED FOR:

IGNASH FAMILY 214 N. LAIRD STREET NAPERVILLE, IL 60540

ALPINE RIDGE BUILDERS, LLC 12249 S. RHEA DRIVE, STE. 2 PLAINFIELD, IL 60585

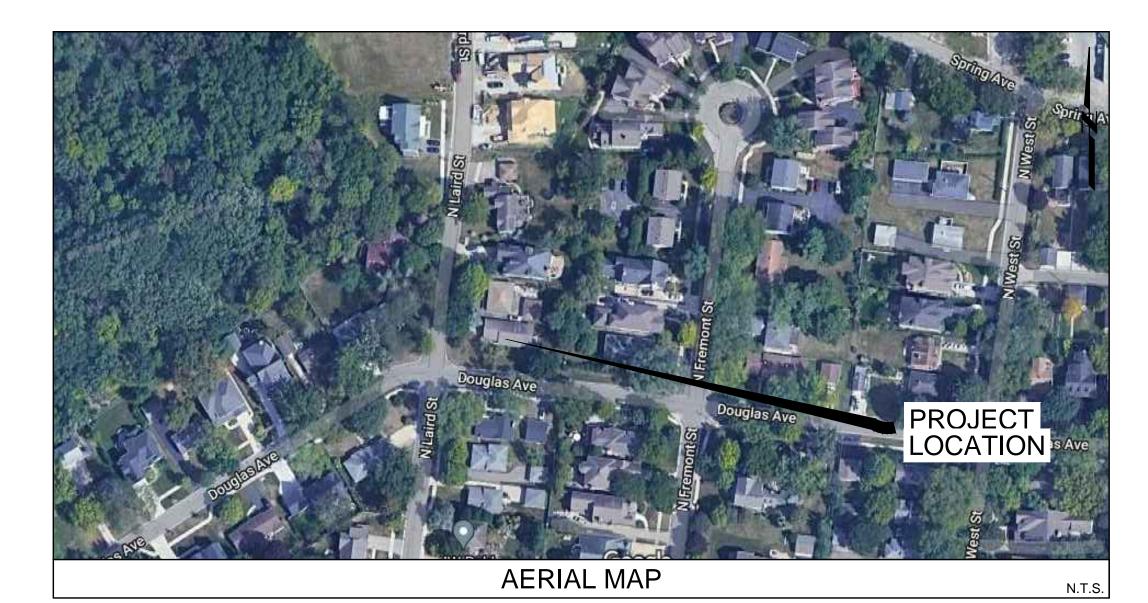

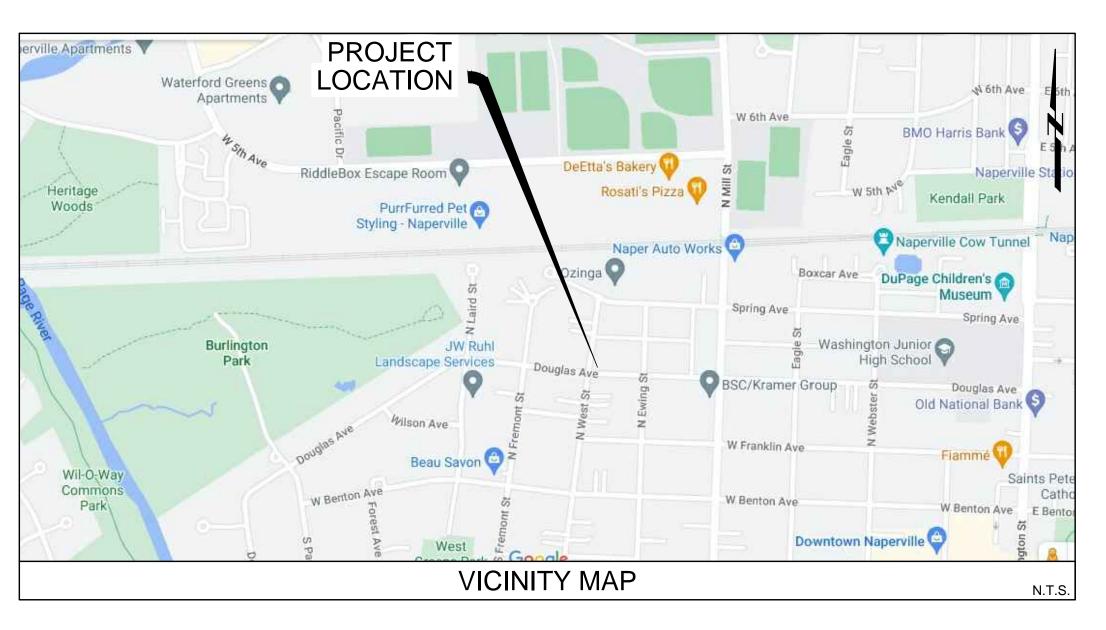

INDEX OF DRAWINGS	
SHEET NO.	DRAWING TITLE
C1.0	COVER SHEET
C2.0	EXISTING CONDITIONS
C2.1	SITE DEMO AND EROSION CONTROL PLAN
C3.0	SITE GRADING PLAN

CONSTRUCTION NOTE

1. A SET OF THE FINAL APPROVED ENGINEERING PLANS SHALL BE ON SITE DURING ANY CONSTRUCTION ACTIVITIES AT ALL TIMES. FAILURE TO DO SO MAY RESULT IN A NOTICE TO STOP CONSTRUCTION ACTIVITIES.

SURFACE WATER STATEMENT

STATE OF ILLINOIS)
) S
COUNTY OF DU PAGE)

TO THE BEST OF OUR KNOWLEDGE AND BELIEF THE DRAINAGE OF SURFACE WATERS WILL NOT BE CHANGED BY THE CONSTRUCTION OF SUCH DEVELOPMENT OR ANY PART THEREOF, OR, THAT IF SUCH SURFACE WATER DRAINAGE WILL BE CHANGED, REASONABLE PROVISION HAS BEEN MADE FOR COLLECTION AND DIVERSION OF SUCH SURFACE WATERS INTO PUBLIC AREAS, OR DRAINS WHICH THE OWNER HAS A RIGHT TO USE, AND THAT SUCH SURFACE WATERS WILL BE PLANNED FOR IN ACCORDANCE WITH GENERALLY ACCEPTED ENGINEERING PRACTICES SO AS TO REDUCE THE LIKELIHOOD OF DAMAGE TO THE ADJOINING PROPERTY BECAUSE OF THE CONSTRUCTION OF THE DEVELOPMENT.


DATED THIS 27TH DAY OF <u>SEPTEMBER</u>, A.D., 20 22 .

THOMAS G. CRNKOVICH, III
ILLINOIS REGISTERED
PROFESSIONAL ENGINEER
062-060814
STATE REGISTRATION NUMBER
2/28/22
REGISTRATION EXPIRATION / RENEWAL

TITLE: MANAGING PARTNER

REGISTRATION EXPIRATION / RENEWAL DATE
OWNER COMPANY NAME: RIVERCREST CONSULTING, LLC
BY: ATTEST:
SIGNATURE SIGNATURE

G CRNA 0.062-060814 CH LICENSED PROFESSIONAL ENGINEER OF LINOS

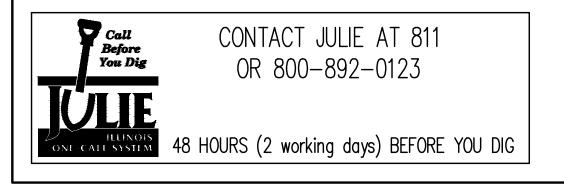

RIVERGREST CONSULTING, LLC Stormwater Manager Stormwater Manager B952 HANSLIK GOURT, UNIT 13

NAPERVILLE, IL 60564
(630) 538-5108

IGNASH RESIDENCE
NAPERVILLE, IL
NOT FOR CONSTRUCTION


SHE


COVE

PROJ. MGR.: TGC
PROJ. ENG.: TGC
DRAWN BY: TGC
DATE: 09/27/22
SCALE: N.T.S.
SHEET NO.

C1.0

PROJ. NUMBER: 22135

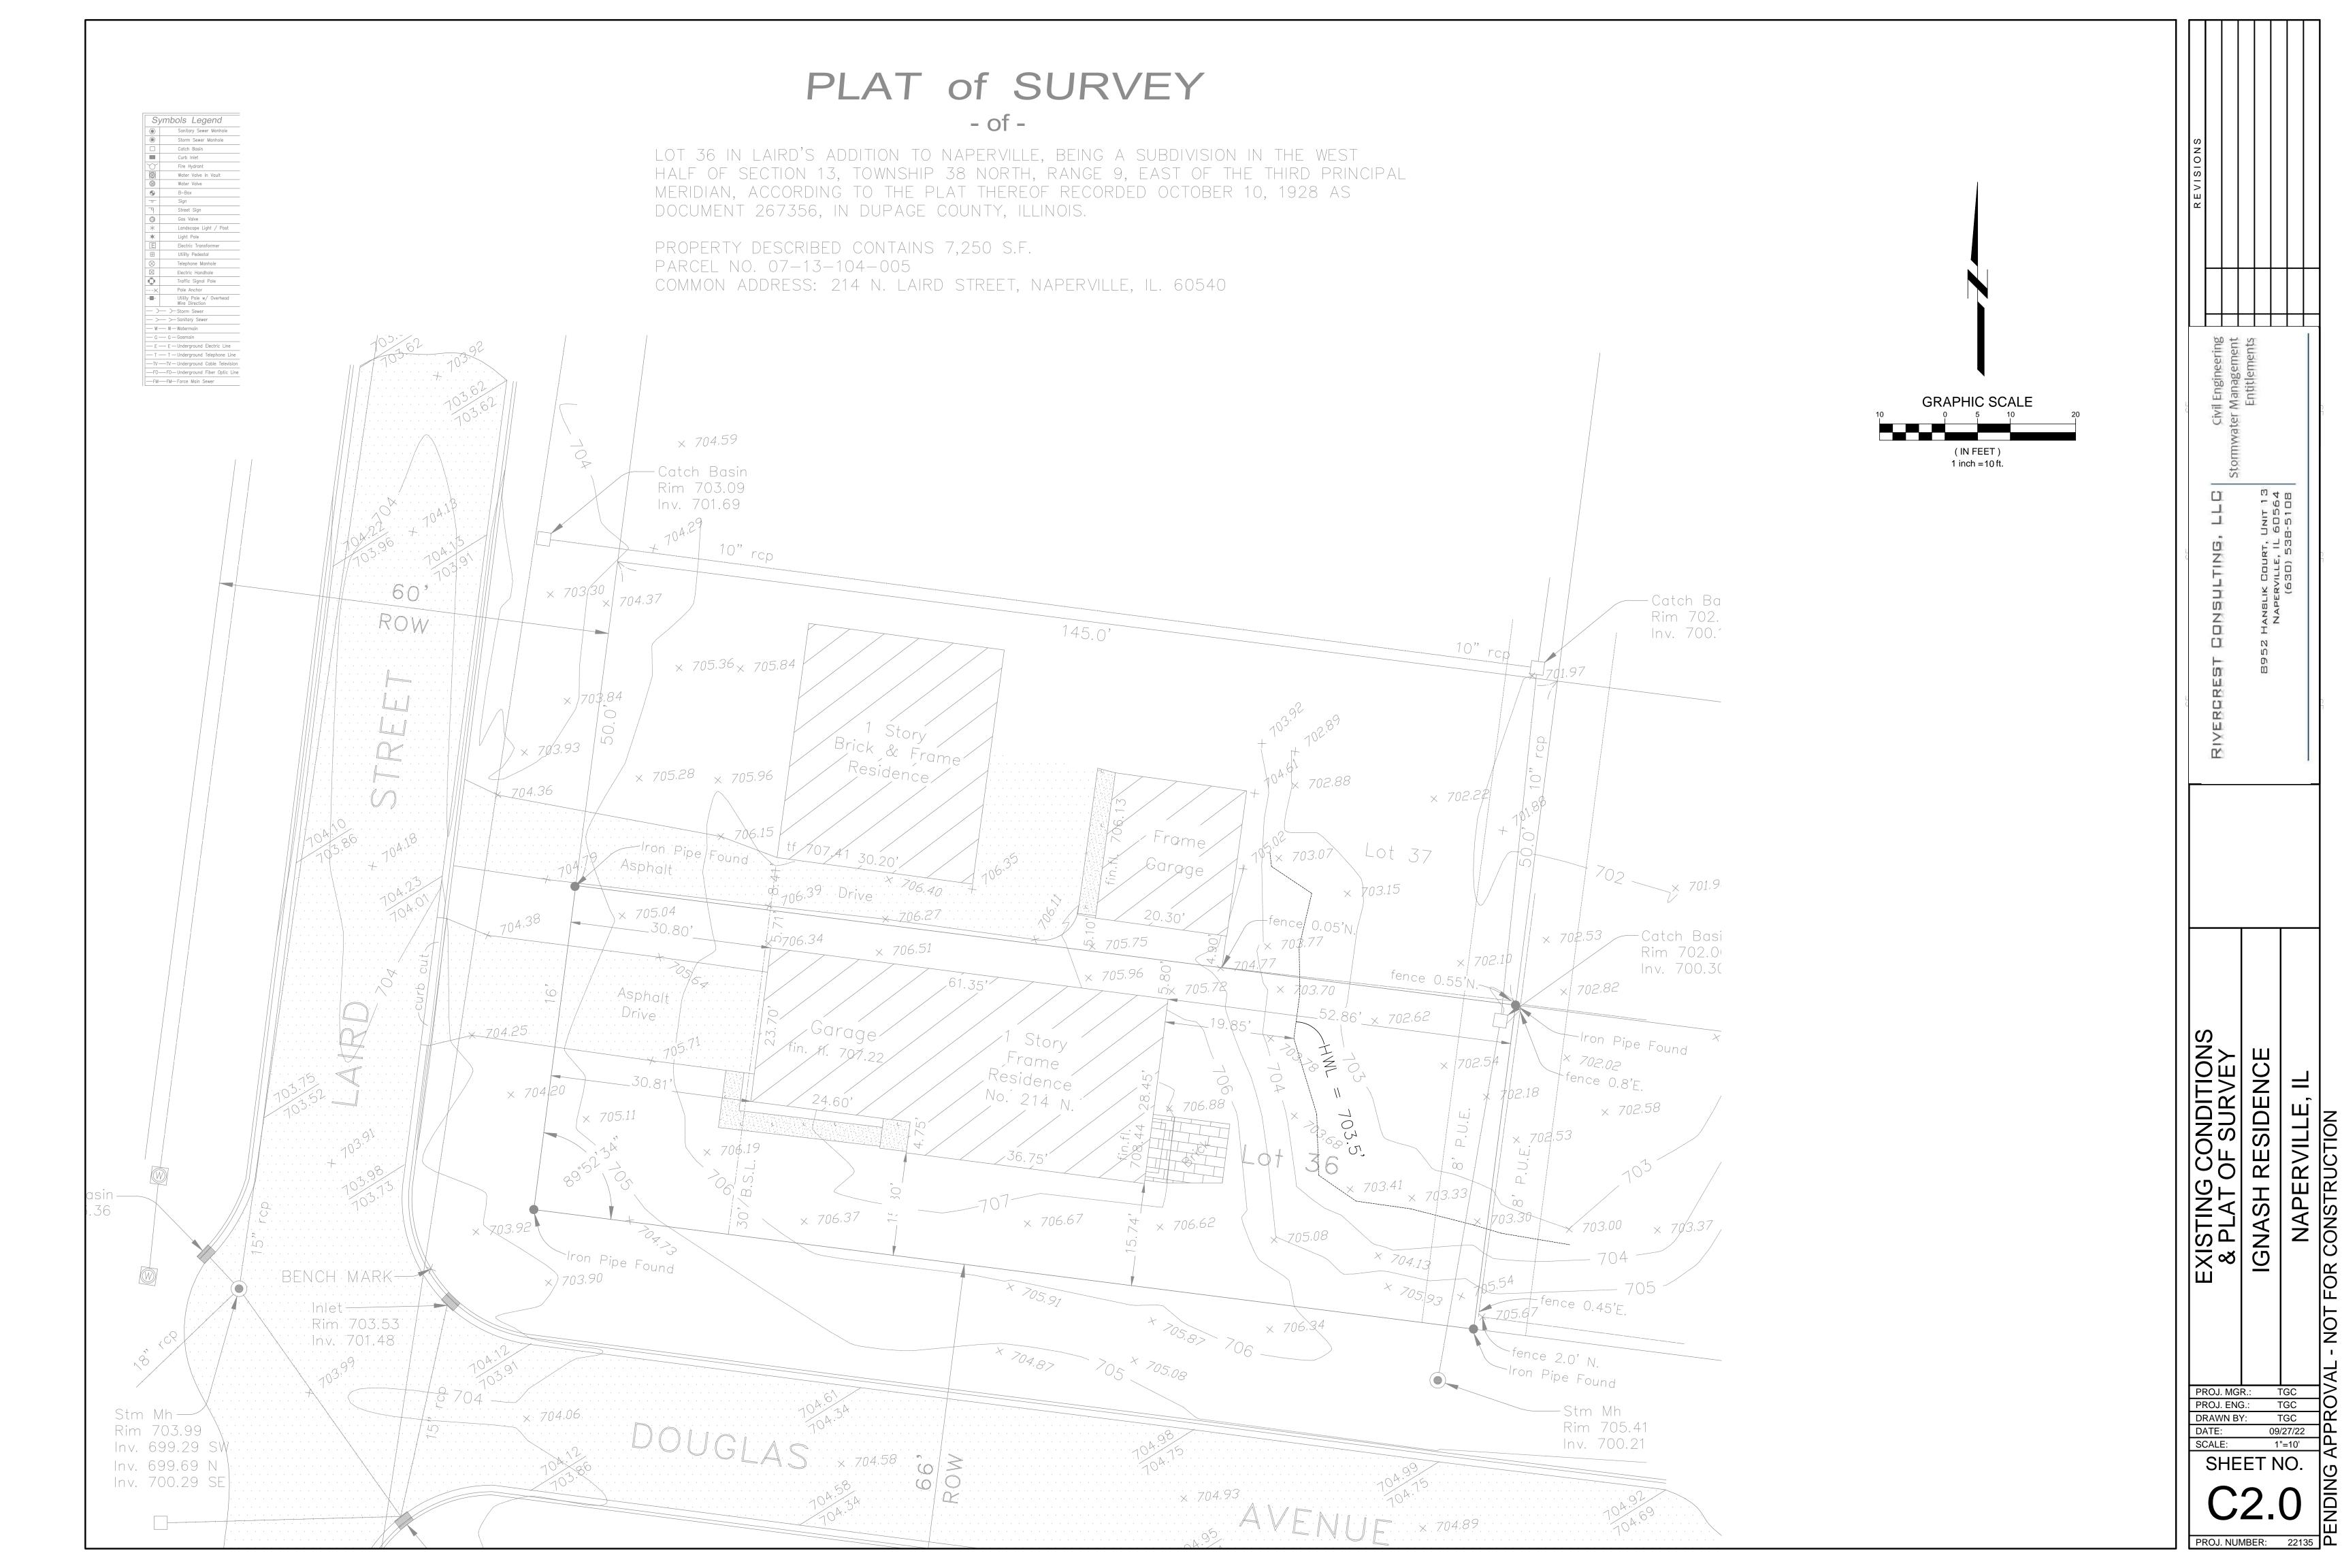

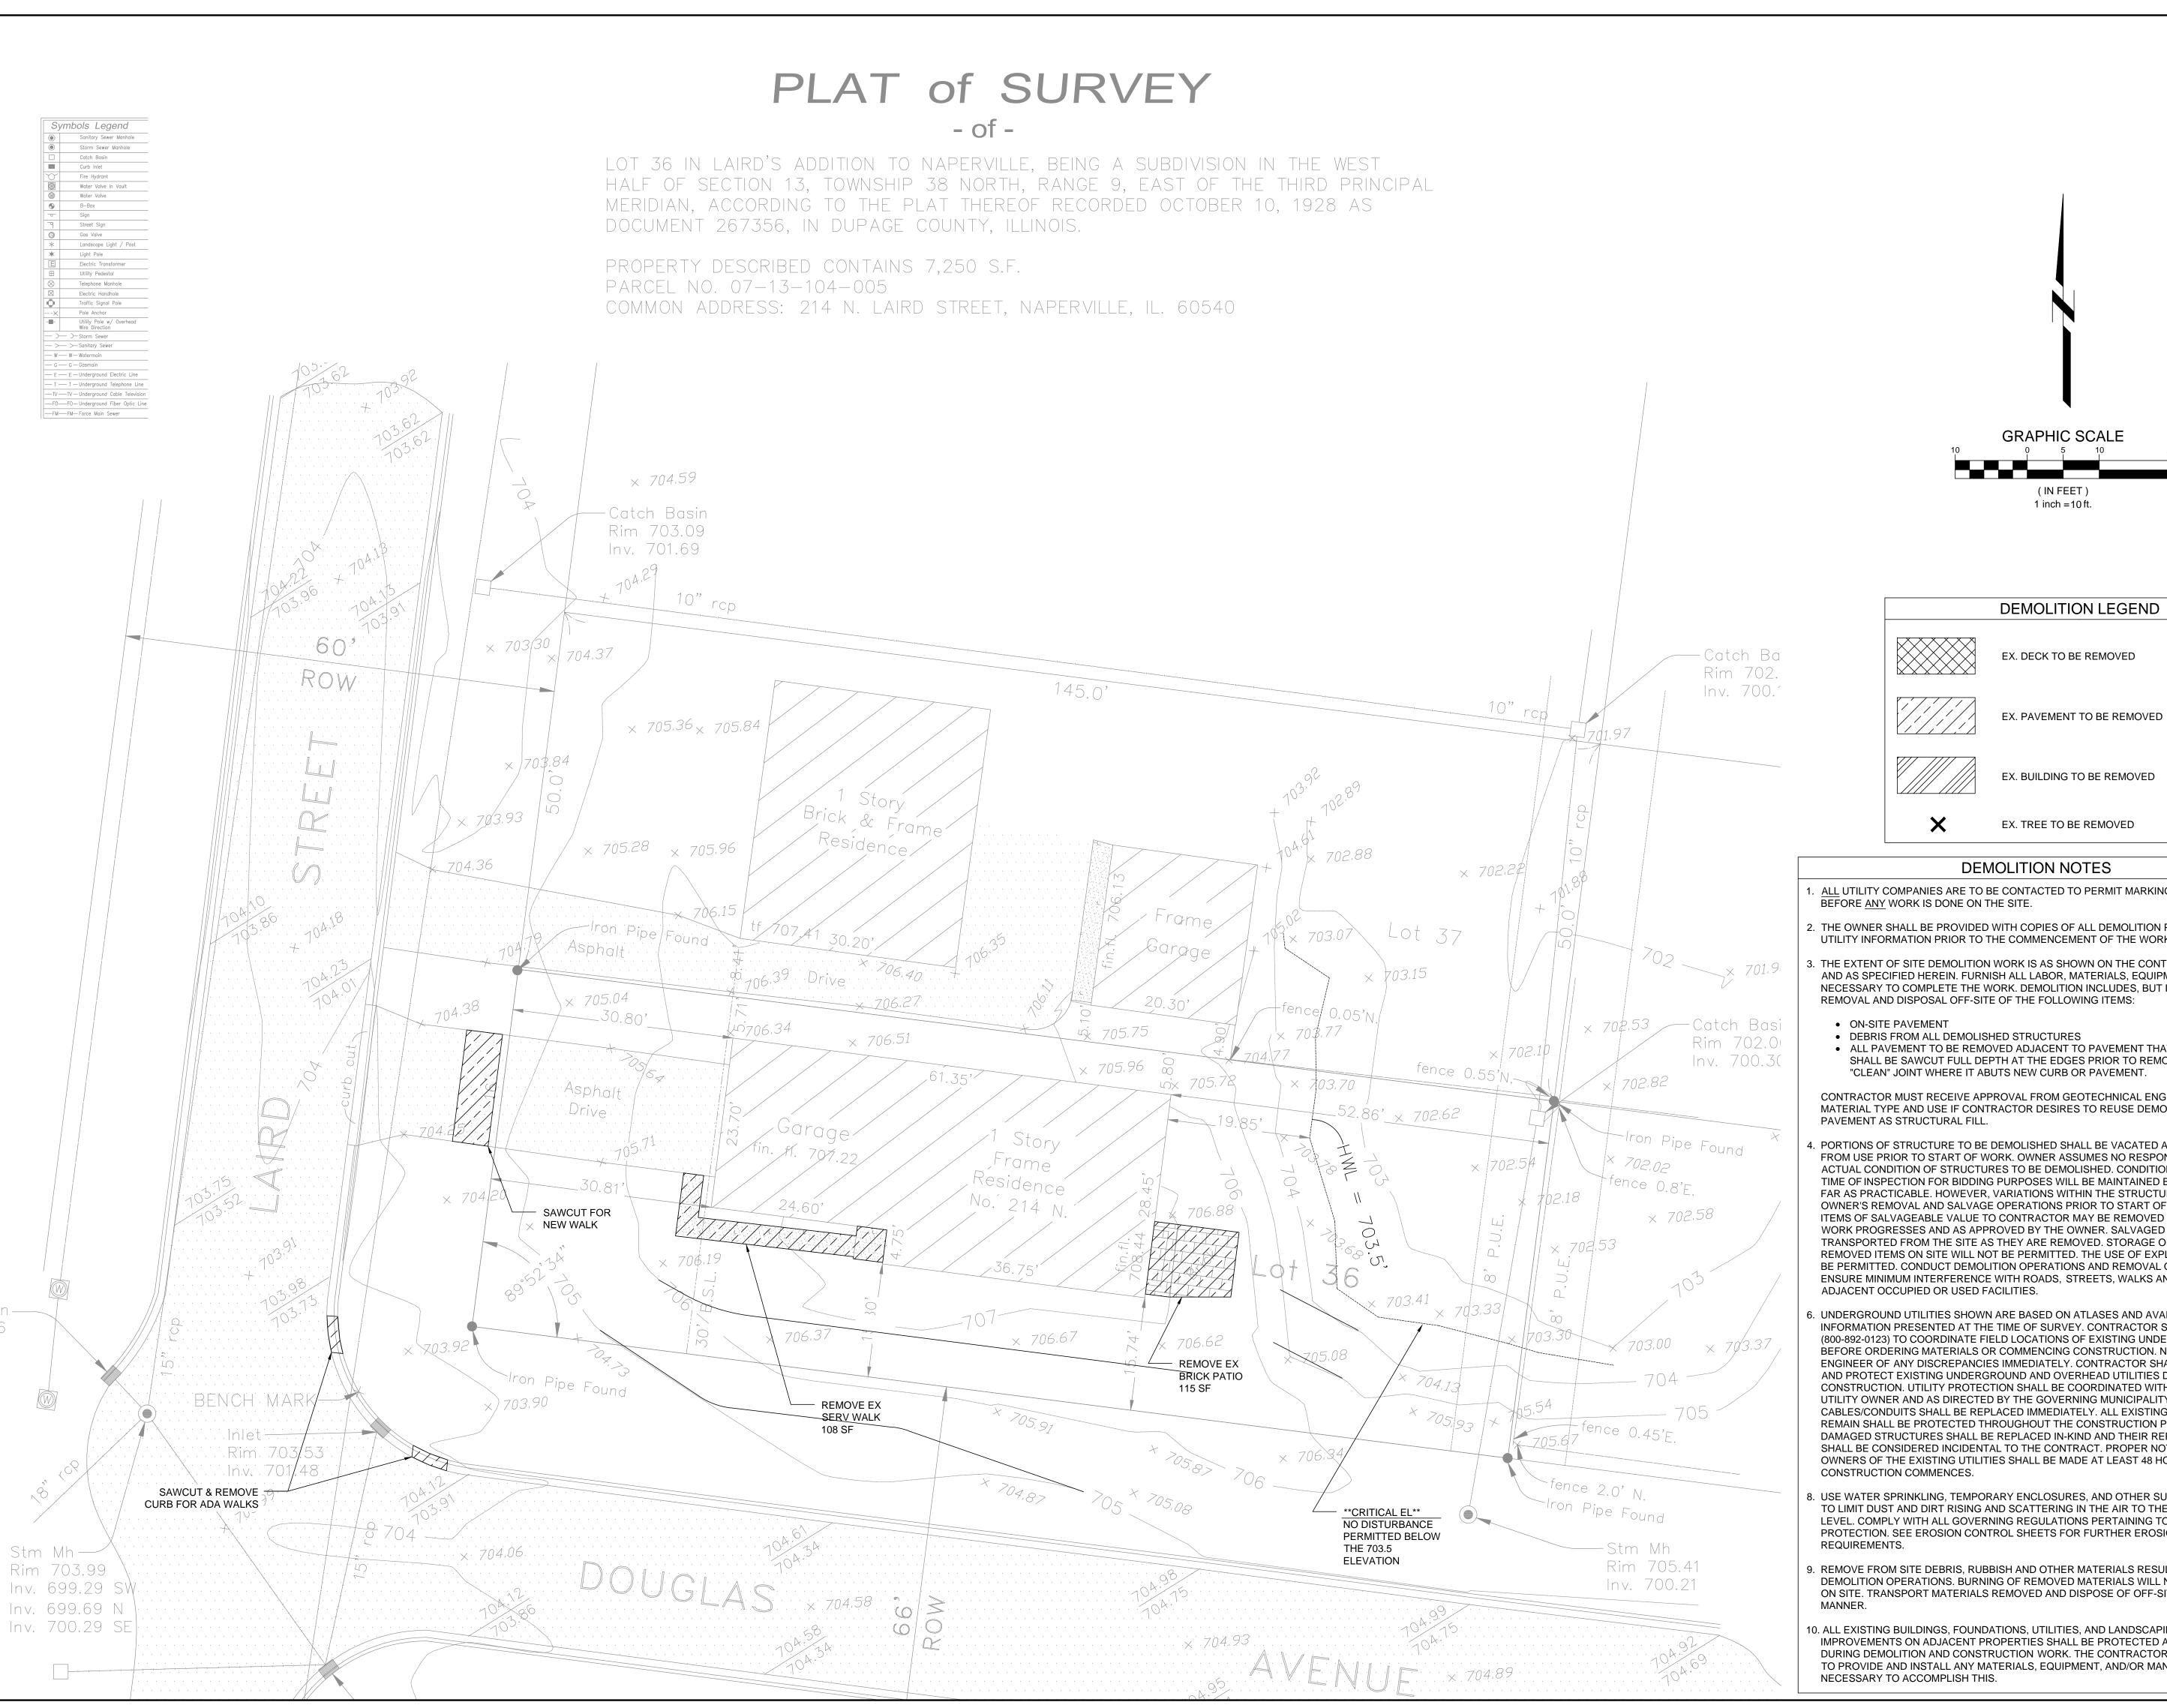

GRAPHIC SCALE 1 inch = $10 \, \text{ft}$. DEMOLITION LEGEND

DEMOLITION NOTES

- 2. THE OWNER SHALL BE PROVIDED WITH COPIES OF ALL DEMOLITION PERMITS AND UTILITY INFORMATION PRIOR TO THE COMMENCEMENT OF THE WORK.
- 3. THE EXTENT OF SITE DEMOLITION WORK IS AS SHOWN ON THE CONTRACT DOCUMENTS AND AS SPECIFIED HEREIN. FURNISH ALL LABOR, MATERIALS, EQUIPMENT AND SERVICE NECESSARY TO COMPLETE THE WORK. DEMOLITION INCLUDES, BUT IS NOT LIMITED TO, REMOVAL AND DISPOSAL OFF-SITE OF THE FOLLOWING ITEMS:
 - DEBRIS FROM ALL DEMOLISHED STRUCTURES
 - ALL PAVEMENT TO BE REMOVED ADJACENT TO PAVEMENT THAT IS TO REMAIN SHALL BE SAWCUT FULL DEPTH AT THE EDGES PRIOR TO REMOVAL TO OBTAIN A "CLEAN" JOINT WHERE IT ABUTS NEW CURB OR PAVEMENT.

CONTRACTOR MUST RECEIVE APPROVAL FROM GEOTECHNICAL ENGINEER FOR THE MATERIAL TYPE AND USE IF CONTRACTOR DESIRES TO REUSE DEMOLISHED SITE

- . PORTIONS OF STRUCTURE TO BE DEMOLISHED SHALL BE VACATED AND DISCONTINUED FROM USE PRIOR TO START OF WORK. OWNER ASSUMES NO RESPONSIBILITY FOR ACTUAL CONDITION OF STRUCTURES TO BE DEMOLISHED. CONDITIONS EXISTING AT TIME OF INSPECTION FOR BIDDING PURPOSES WILL BE MAINTAINED BY OWNER IN SO FAR AS PRACTICABLE. HOWEVER, VARIATIONS WITHIN THE STRUCTURES MAY OCCUR BY OWNER'S REMOVAL AND SALVAGE OPERATIONS PRIOR TO START OF DEMOLITION WORK. ITEMS OF SALVAGEABLE VALUE TO CONTRACTOR MAY BE REMOVED FROM SITE AS WORK PROGRESSES AND AS APPROVED BY THE OWNER. SALVAGED ITEMS MUST BE TRANSPORTED FROM THE SITE AS THEY ARE REMOVED. STORAGE OR SALE OF REMOVED ITEMS ON SITE WILL NOT BE PERMITTED. THE USE OF EXPLOSIVES WILL NOT BE PERMITTED. CONDUCT DEMOLITION OPERATIONS AND REMOVAL OF DEBRIS TO ENSURE MINIMUM INTERFERENCE WITH ROADS, STREETS, WALKS AND OTHER ADJACENT OCCUPIED OR USED FACILITIES.
- 6. UNDERGROUND UTILITIES SHOWN ARE BASED ON ATLASES AND AVAILABLE INFORMATION PRESENTED AT THE TIME OF SURVEY. CONTRACTOR SHALL CALL "JULIE" (800-892-0123) TO COORDINATE FIELD LOCATIONS OF EXISTING UNDERGROUND UTILITIES BEFORE ORDERING MATERIALS OR COMMENCING CONSTRUCTION. NOTIFY ENGINEER OF ANY DISCREPANCIES IMMEDIATELY. CONTRACTOR SHALL LOCATE AND PROTECT EXISTING UNDERGROUND AND OVERHEAD UTILITIES DURING CONSTRUCTION. UTILITY PROTECTION SHALL BE COORDINATED WITH THE RESPECTIVE UTILITY OWNER AND AS DIRECTED BY THE GOVERNING MUNICIPALITY. DAMAGED CABLES/CONDUITS SHALL BE REPLACED IMMEDIATELY. ALL EXISTING STRUCTURES TO REMAIN SHALL BE PROTECTED THROUGHOUT THE CONSTRUCTION PROCESS. ALL DAMAGED STRUCTURES SHALL BE REPLACED IN-KIND AND THEIR REPLACEMENT COST SHALL BE CONSIDERED INCIDENTAL TO THE CONTRACT. PROPER NOTIFICATION TO THE OWNERS OF THE EXISTING UTILITIES SHALL BE MADE AT LEAST 48 HOURS BEFORE
- B. USE WATER SPRINKLING, TEMPORARY ENCLOSURES, AND OTHER SUITABLE METHODS TO LIMIT DUST AND DIRT RISING AND SCATTERING IN THE AIR TO THE LOWEST LEVEL. COMPLY WITH ALL GOVERNING REGULATIONS PERTAINING TO ENVIRONMENTAL PROTECTION. SEE EROSION CONTROL SHEETS FOR FURTHER EROSION CONTROL
- D. REMOVE FROM SITE DEBRIS, RUBBISH AND OTHER MATERIALS RESULTING FROM DEMOLITION OPERATIONS. BURNING OF REMOVED MATERIALS WILL NOT BE PERMITTED ON SITE. TRANSPORT MATERIALS REMOVED AND DISPOSE OF OFF-SITE IN A LEGAL
- 10. ALL EXISTING BUILDINGS, FOUNDATIONS, UTILITIES, AND LANDSCAPING AND OTHER IMPROVEMENTS ON ADJACENT PROPERTIES SHALL BE PROTECTED AT ALL TIMES DURING DEMOLITION AND CONSTRUCTION WORK. THE CONTRACTOR IS RESPONSIBLE TO PROVIDE AND INSTALL ANY MATERIALS, EQUIPMENT, AND/OR MANPOWER

SIDEN NAPERVILLE, CONSTRUCTION **IGNASH RE**

PROJ. MGR.: TGC TGC PROJ. ENG.: DRAWN BY TGC DATE: 09/27/22

SCALE: 1"=10'

PROJ. NUMBER: 22135

