## Landscape Plan

# METRO WEST

## Naperville, Illinois

October 24, 2017

## CONSULTANTS:




LANDSCAPE ARCHITECT:

GARY R. WEBER ASSOCIATES, INC 212 SOUTH MAIN STREET WHEATON, ILLINOIS 60187

CIVIL ENGINEER:

CIVWORKS CONSULTING, LLC

3343 N. NEVA AVENUE CHICAGO, IL 60634

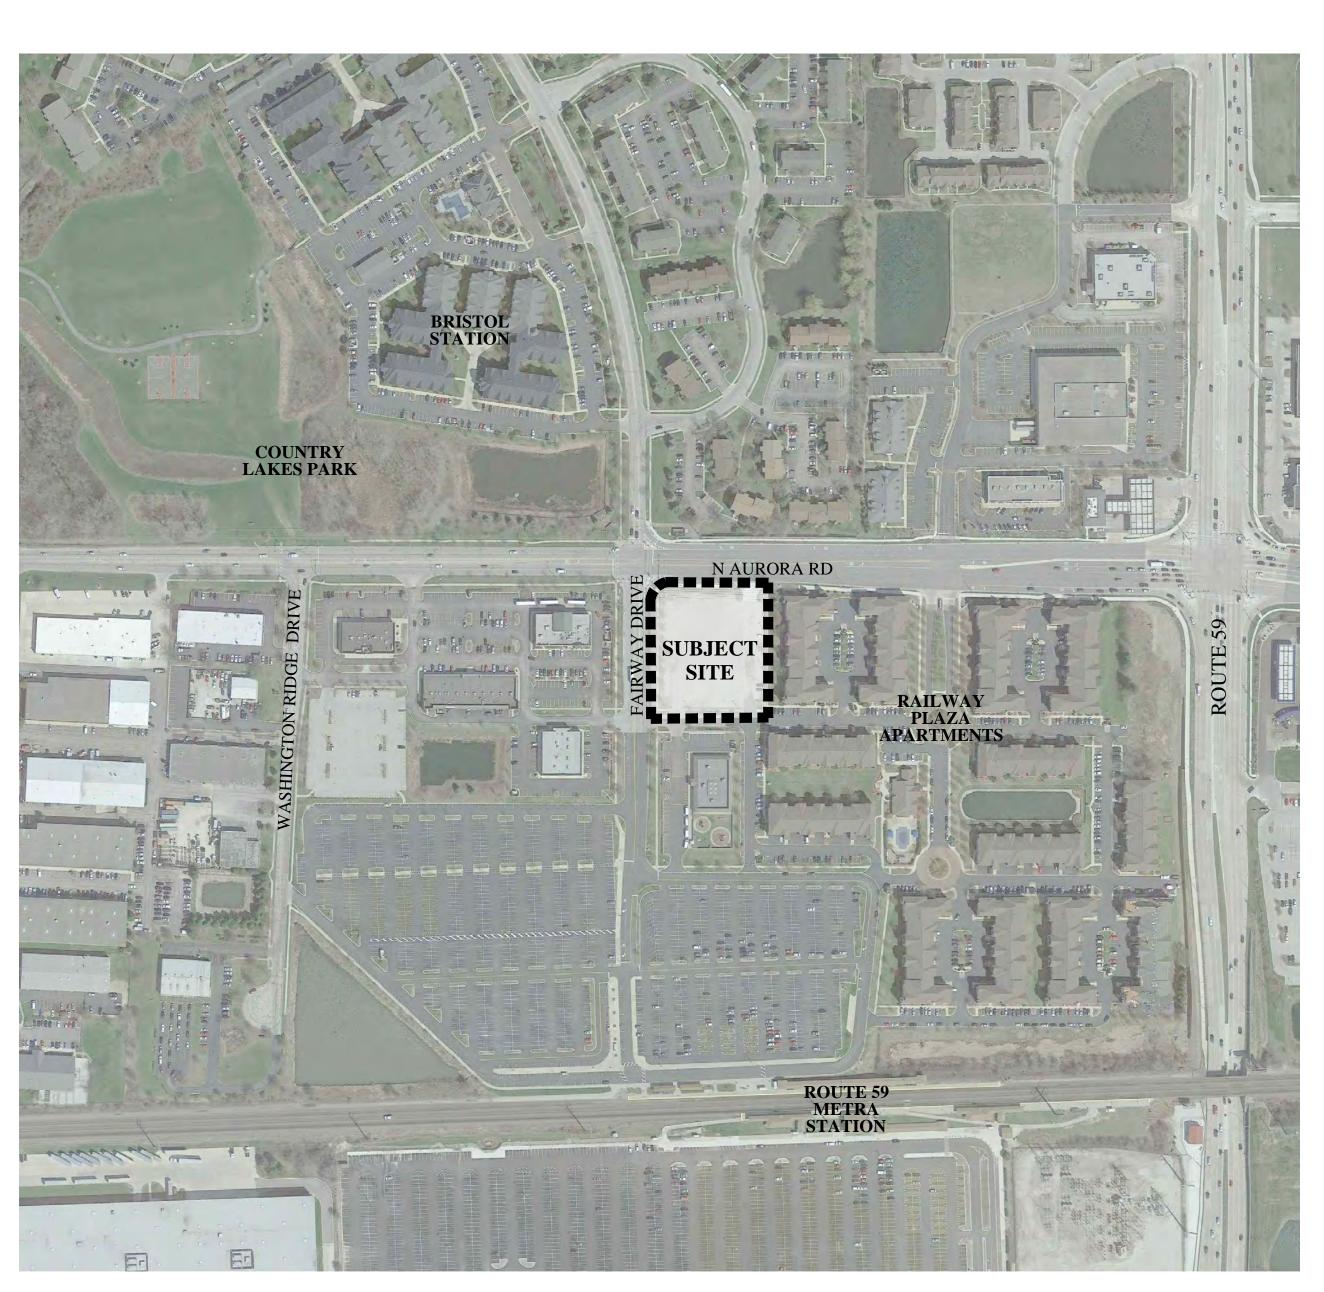

LOCATION MAP

SCALE: 1"=200'




## INDEX OF SHEETS


SHEET NO.	DESCRIPTION
0	COVER SHEET
1	OVERALL LANDSCAPE PLAN
2	LANDSCAPE PLAN
3	LANDSCAPE PLAN
4	TREE PRESERVATION PLAN
5	MONUMENT DETAILS
6	LANDSCAPE SPECIFICATIONS

#### **PLANTING DETAILS** /-AVOID PLACING SOIL OVER ROOT CROWN. SET ROOT BALL 3-6" HIGHER THAN FINISHED GRADE. /2" SHREDDED HARDWOOD BARK MULCH. FORM SAUCER AROUND OUTSIDE. FINISHED GRADE EXISTING SUBGRADE **DECIDUOUS AND EVERGREEN SHRUBS** -PLANT SPACING AS PER PLAN 2" SHREDDED HARDWOOD BARK MULCH EXISTING SUBGRADE PERENNIALS AND GROUNDCOVERS NOT TO SCALE -PRUNE ONLY TO ENCOURAGE CENTRAL LEADER. DO NOT CUT CENTRAL LEADER. -MAINTAIN EXPOSURE OF ROOT FLARE. IF ROOT FLARE IS NOT EXPOSED, CAREFULLY REMOVE EXCESS SOIL. SET ROOT BALL SO THAT BASE OF ROOT FLARE IS 3-6" HIGHER THAN ADJACENT FINISH GRADE. -3" SHREDDED HARDWOOD BARK MULCH. FORM SAUCER AROUND OUTSIDE EDGE (1" AT BASE OF ---FINISHED GRADE EXISTING SUBGRADE PLANTING PIT TO BE AT LEAST TWICE AS WIDE AS ROOT BALL.


ROOT BALL DIA.

**SCALE: 1"=50'** 

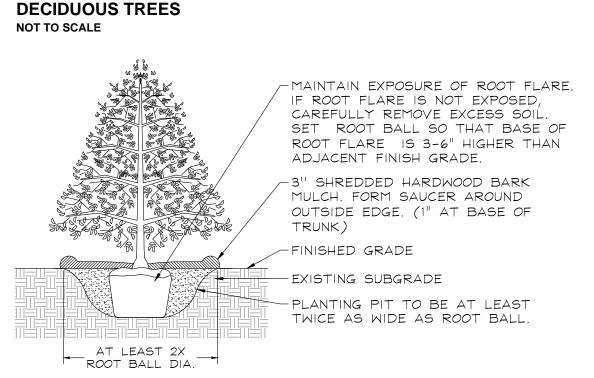

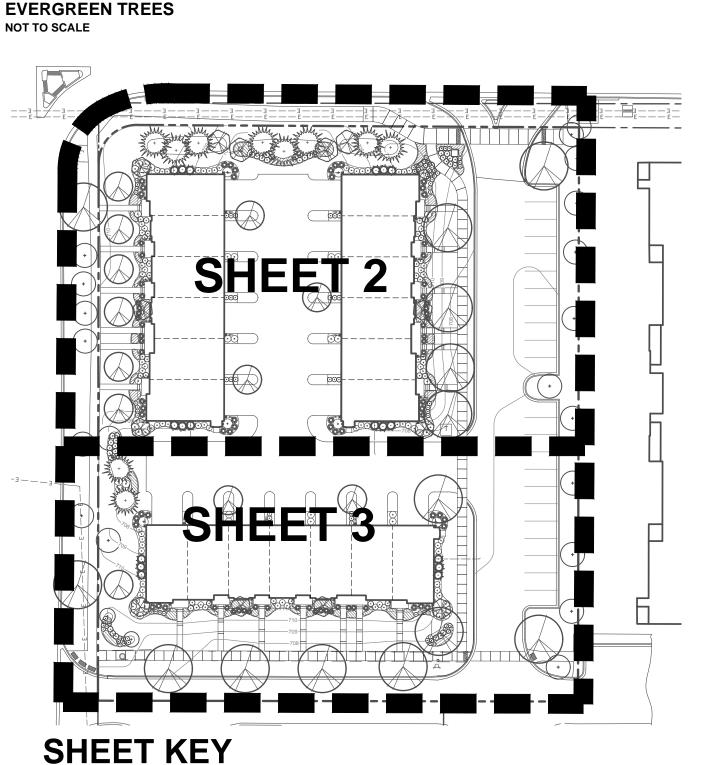


NORTH

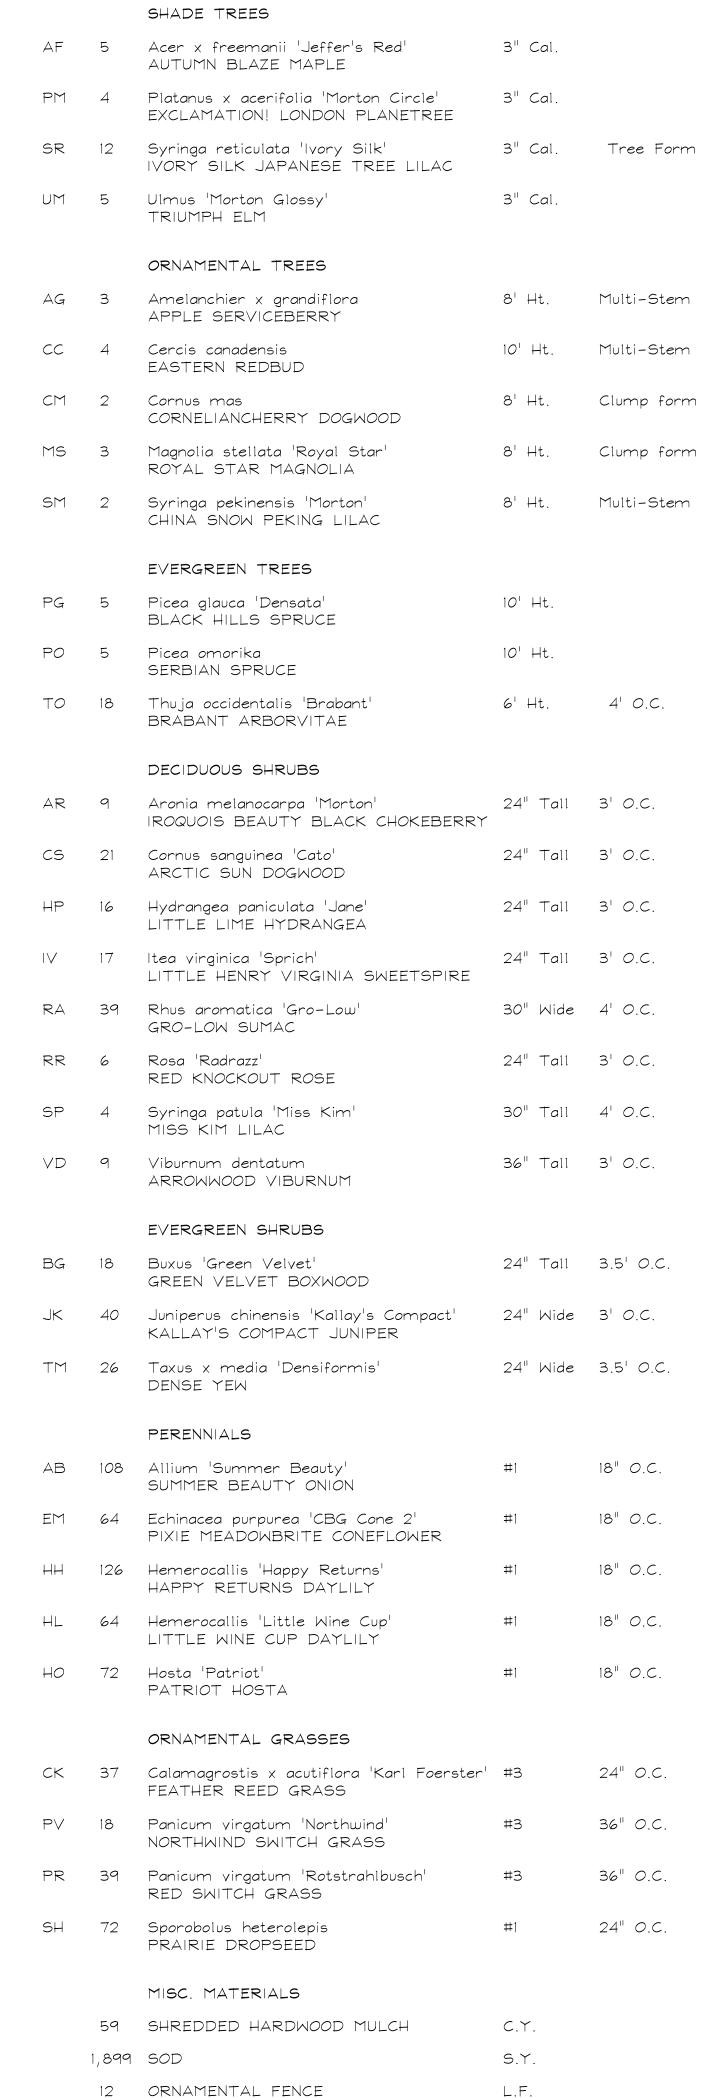

**PLANT LIST** 

Key Qty Botanical/Common Name

Remarks

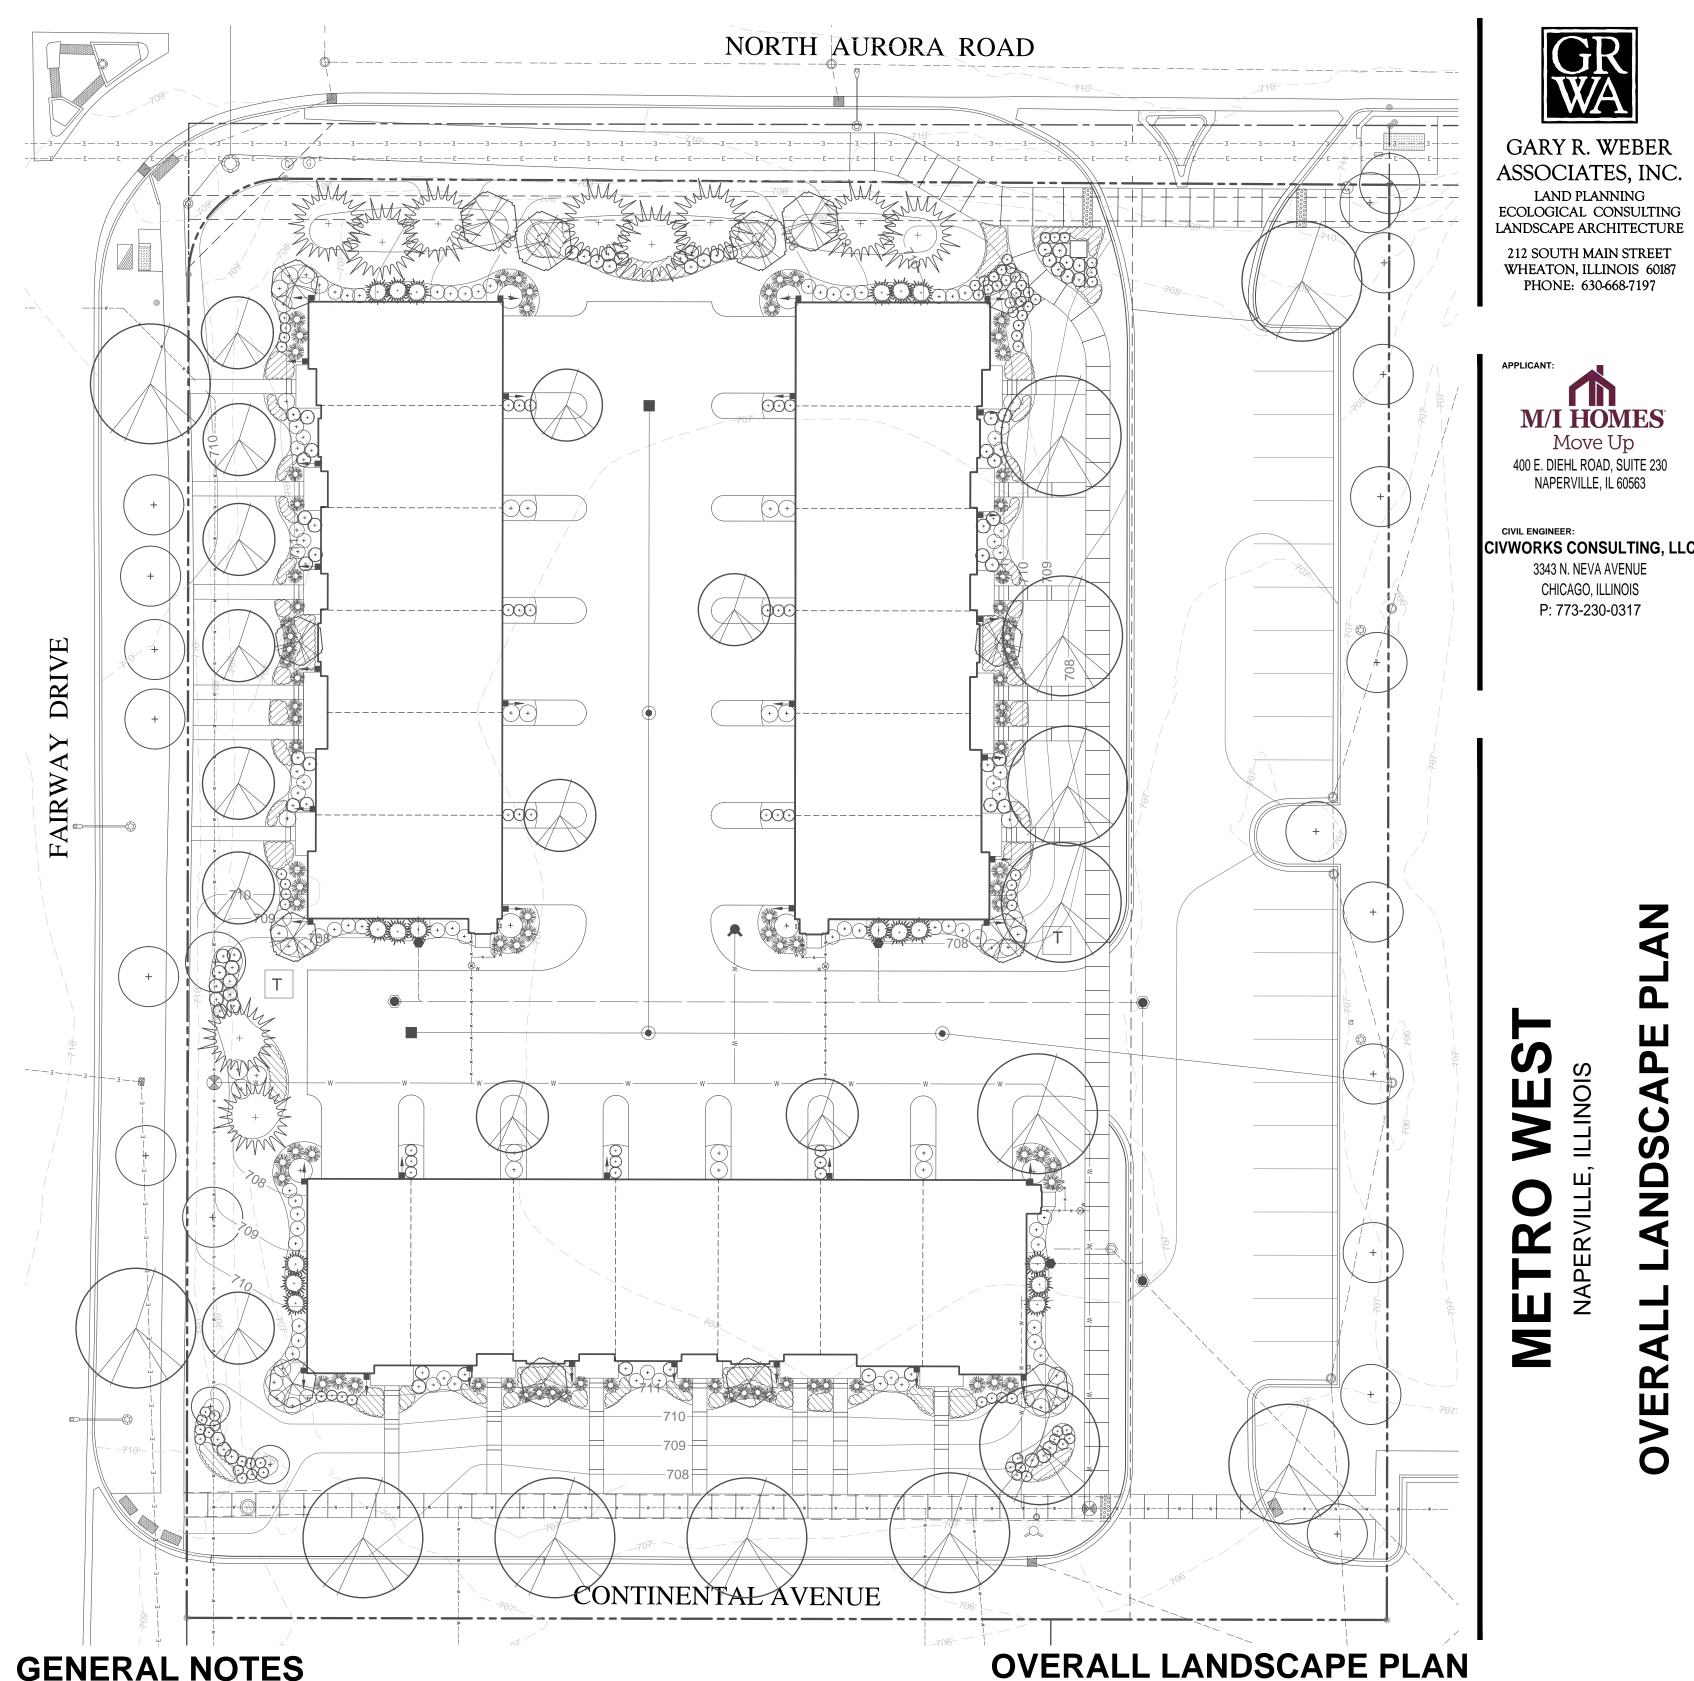

**GENERAL NOTES** 

1. TREES SHALL BE INSTALLED A MINIMUM OF FIVE (5) FEET HORIZONTALLY FROM UNDERGROUND ELECTRICAL FEEDERS, SANITARY SEWERS, SANITARY SERVICES, WATER MAINS, WATER SERVICES AND STORM LINES. TREES SHALL BE INSTALLED A MINIMUM OF TEN (10) FEET HORIZONTALLY FROM UTILITY STRUCTURES AND APPURTENANCES, INCLUDING, BUT NOT LIMITED TO, MANHOLES, VALVE VAULTS, VALVE BOXES, FIRE HYDRANTS AND STORM STRUCTURES. NO TREES, SHRUBS OR OBSTACLES WILL BE ALLOWED 10' IN FRONT OF, 5' ON THE SIDES, AND 7' TO THE REAR OF THE ELECTRICAL TRANSFORMER.

- 2. LOCATION OF TREES MAY REQUIRE ADJUSTMENT BASED ON FINAL ENGINEERING PLANS.
- 3. CONTRACTOR SHALL VERIFY UNDERGROUND UTILITY LINES AND IS RESPONSIBLE FOR ANY DAMAGE.
- 4. CONTRACTOR SHALL VERIFY ALL EXISTING CONDITIONS IN THE FIELD PRIOR TO CONSTRUCTION AND SHALL NOTIFY LANDSCAPE ARCHITECT OF ANY VARIANCE.
- 5. MATERIAL QUANTITIES SHOWN ARE FOR CONTRACTOR'S CONVENIENCE ONLY. THE CONTRACTOR MUST VERIFY ALL MATERIAL AND SUPPLY SUFFICIENT MATERIALS TO COMPLETE THE JOB PER PLAN.
- 6. THE LANDSCAPE ARCHITECT RESERVES THE RIGHT TO INSPECT TREES AND SHRUBS EITHER AT PLACE OF GROWTH OR AT SITE BEFORE PLANTING, FOR COMPLIANCE WITH REQUIREMENTS OF VARIETY, SIZE
- 7. WORK SHALL CONFORM TO AMERICAN STANDARD FOR NURSERY STOCK, STATE OF ILLINOIS HORTICULTURAL STANDARDS, AND LOCAL MUNICIPAL REQUIREMENTS.
- 8. CONTRACTOR SHALL SECURE AND PAY FOR ALL PERMITS, FEES, AND INSPECTIONS NECESSARY FOR THE PROPER EXECUTION OF THIS WORK AND COMPLY WITH ALL CODES APPLICABLE TO THIS WORK.
- 9. SEE GENERAL CONDITIONS AND SPECIFICATIONS FOR LANDSCAPE WORK FOR ADDITIONAL

10.24.2017 10.18.2017 9.25.2017

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LAND PLANNING

PHONE: 630-668-7197

M/I HOMES

Move Up

400 E. DIEHL ROAD, SUITE 230

NAPERVILLE, IL 60563

3343 N. NEVA AVENUE

CHICAGO, ILLINOIS

P: 773-230-0317

DATE 8.21.2017 PROJECT NO. MI1796 DRAWN MGM CHECKED

SHEET NO.




**NORTH** 

**SCALE: 1"=20'** 

EXHIBIT

AND QUALITY.

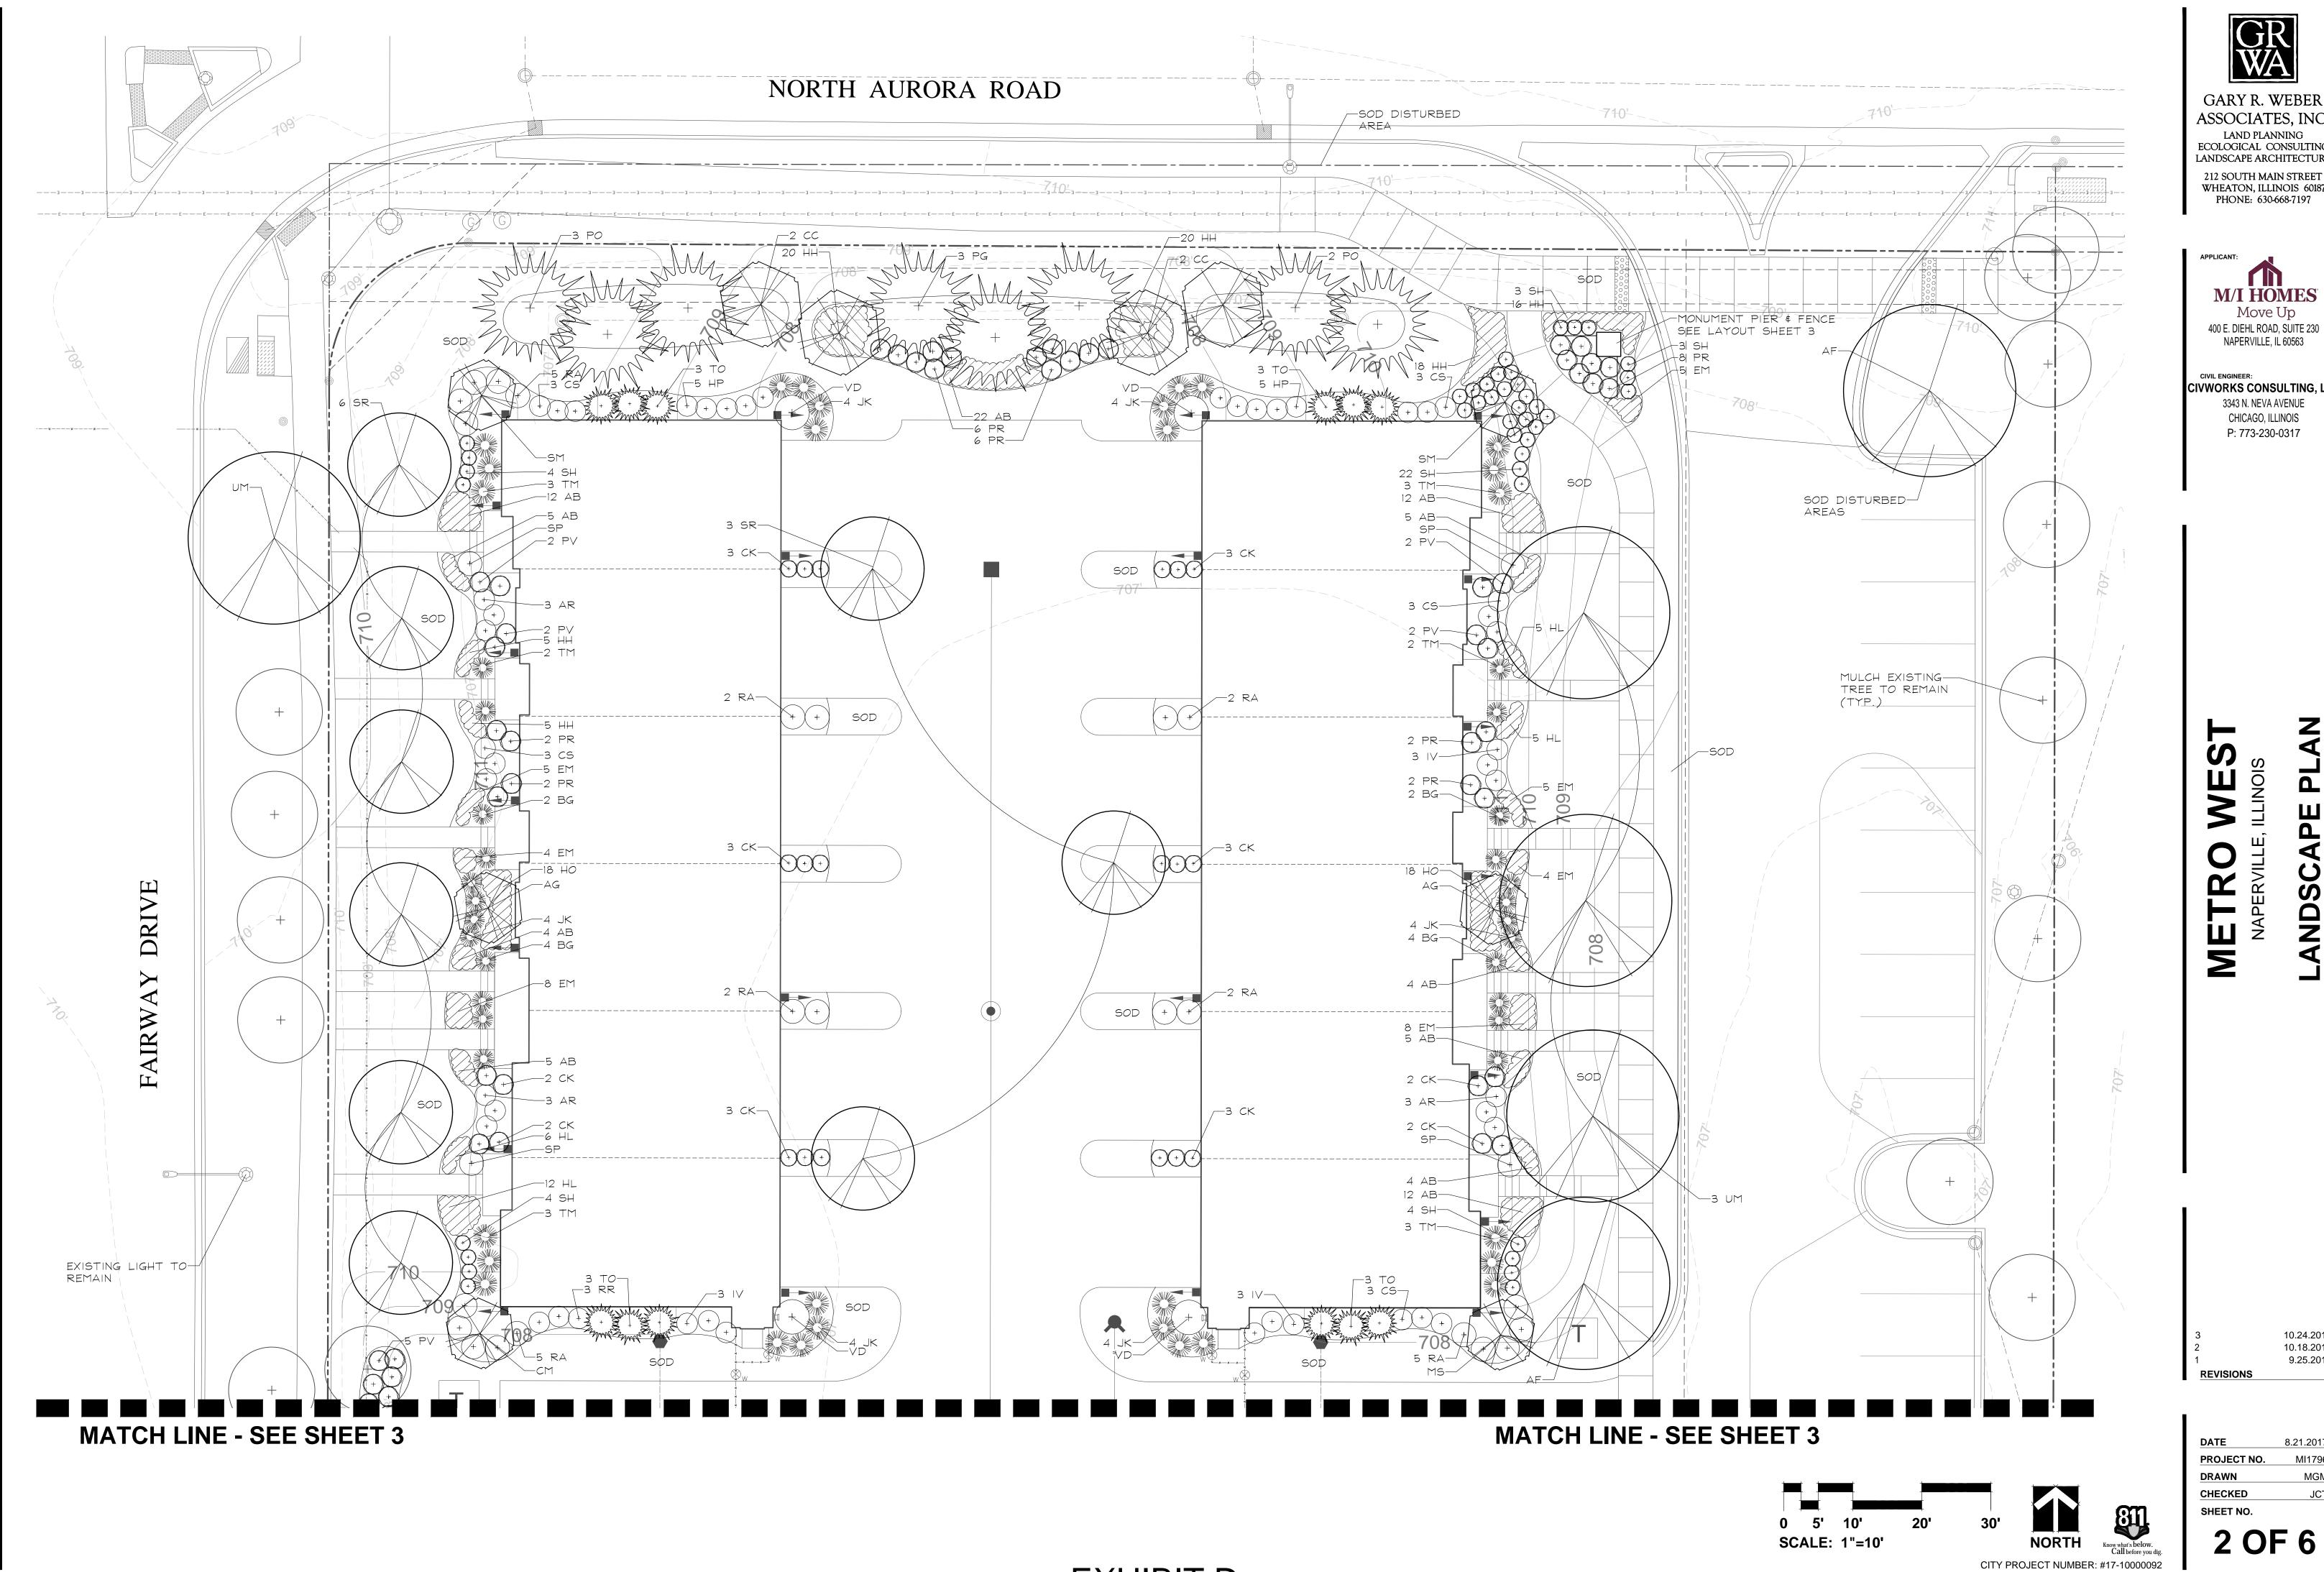

GARY R. WEBER


ASSOCIATES, INC. LAND PLANNING ECOLOGICAL CONSULTING LANDSCAPE ARCHITECTURE WHEATON, ILLINOIS 60187 PHONE: 630-668-7197

M/I HOMES Move Up 400 E. DIEHL ROAD, SUITE 230 NAPERVILLE, IL 60563

CIVWORKS CONSULTING, LLC 3343 N. NEVA AVENUE CHICAGO, ILLINOIS P: 773-230-0317


**ANDSCAP** 

10.24.2017 10.18.2017 9.25.2017

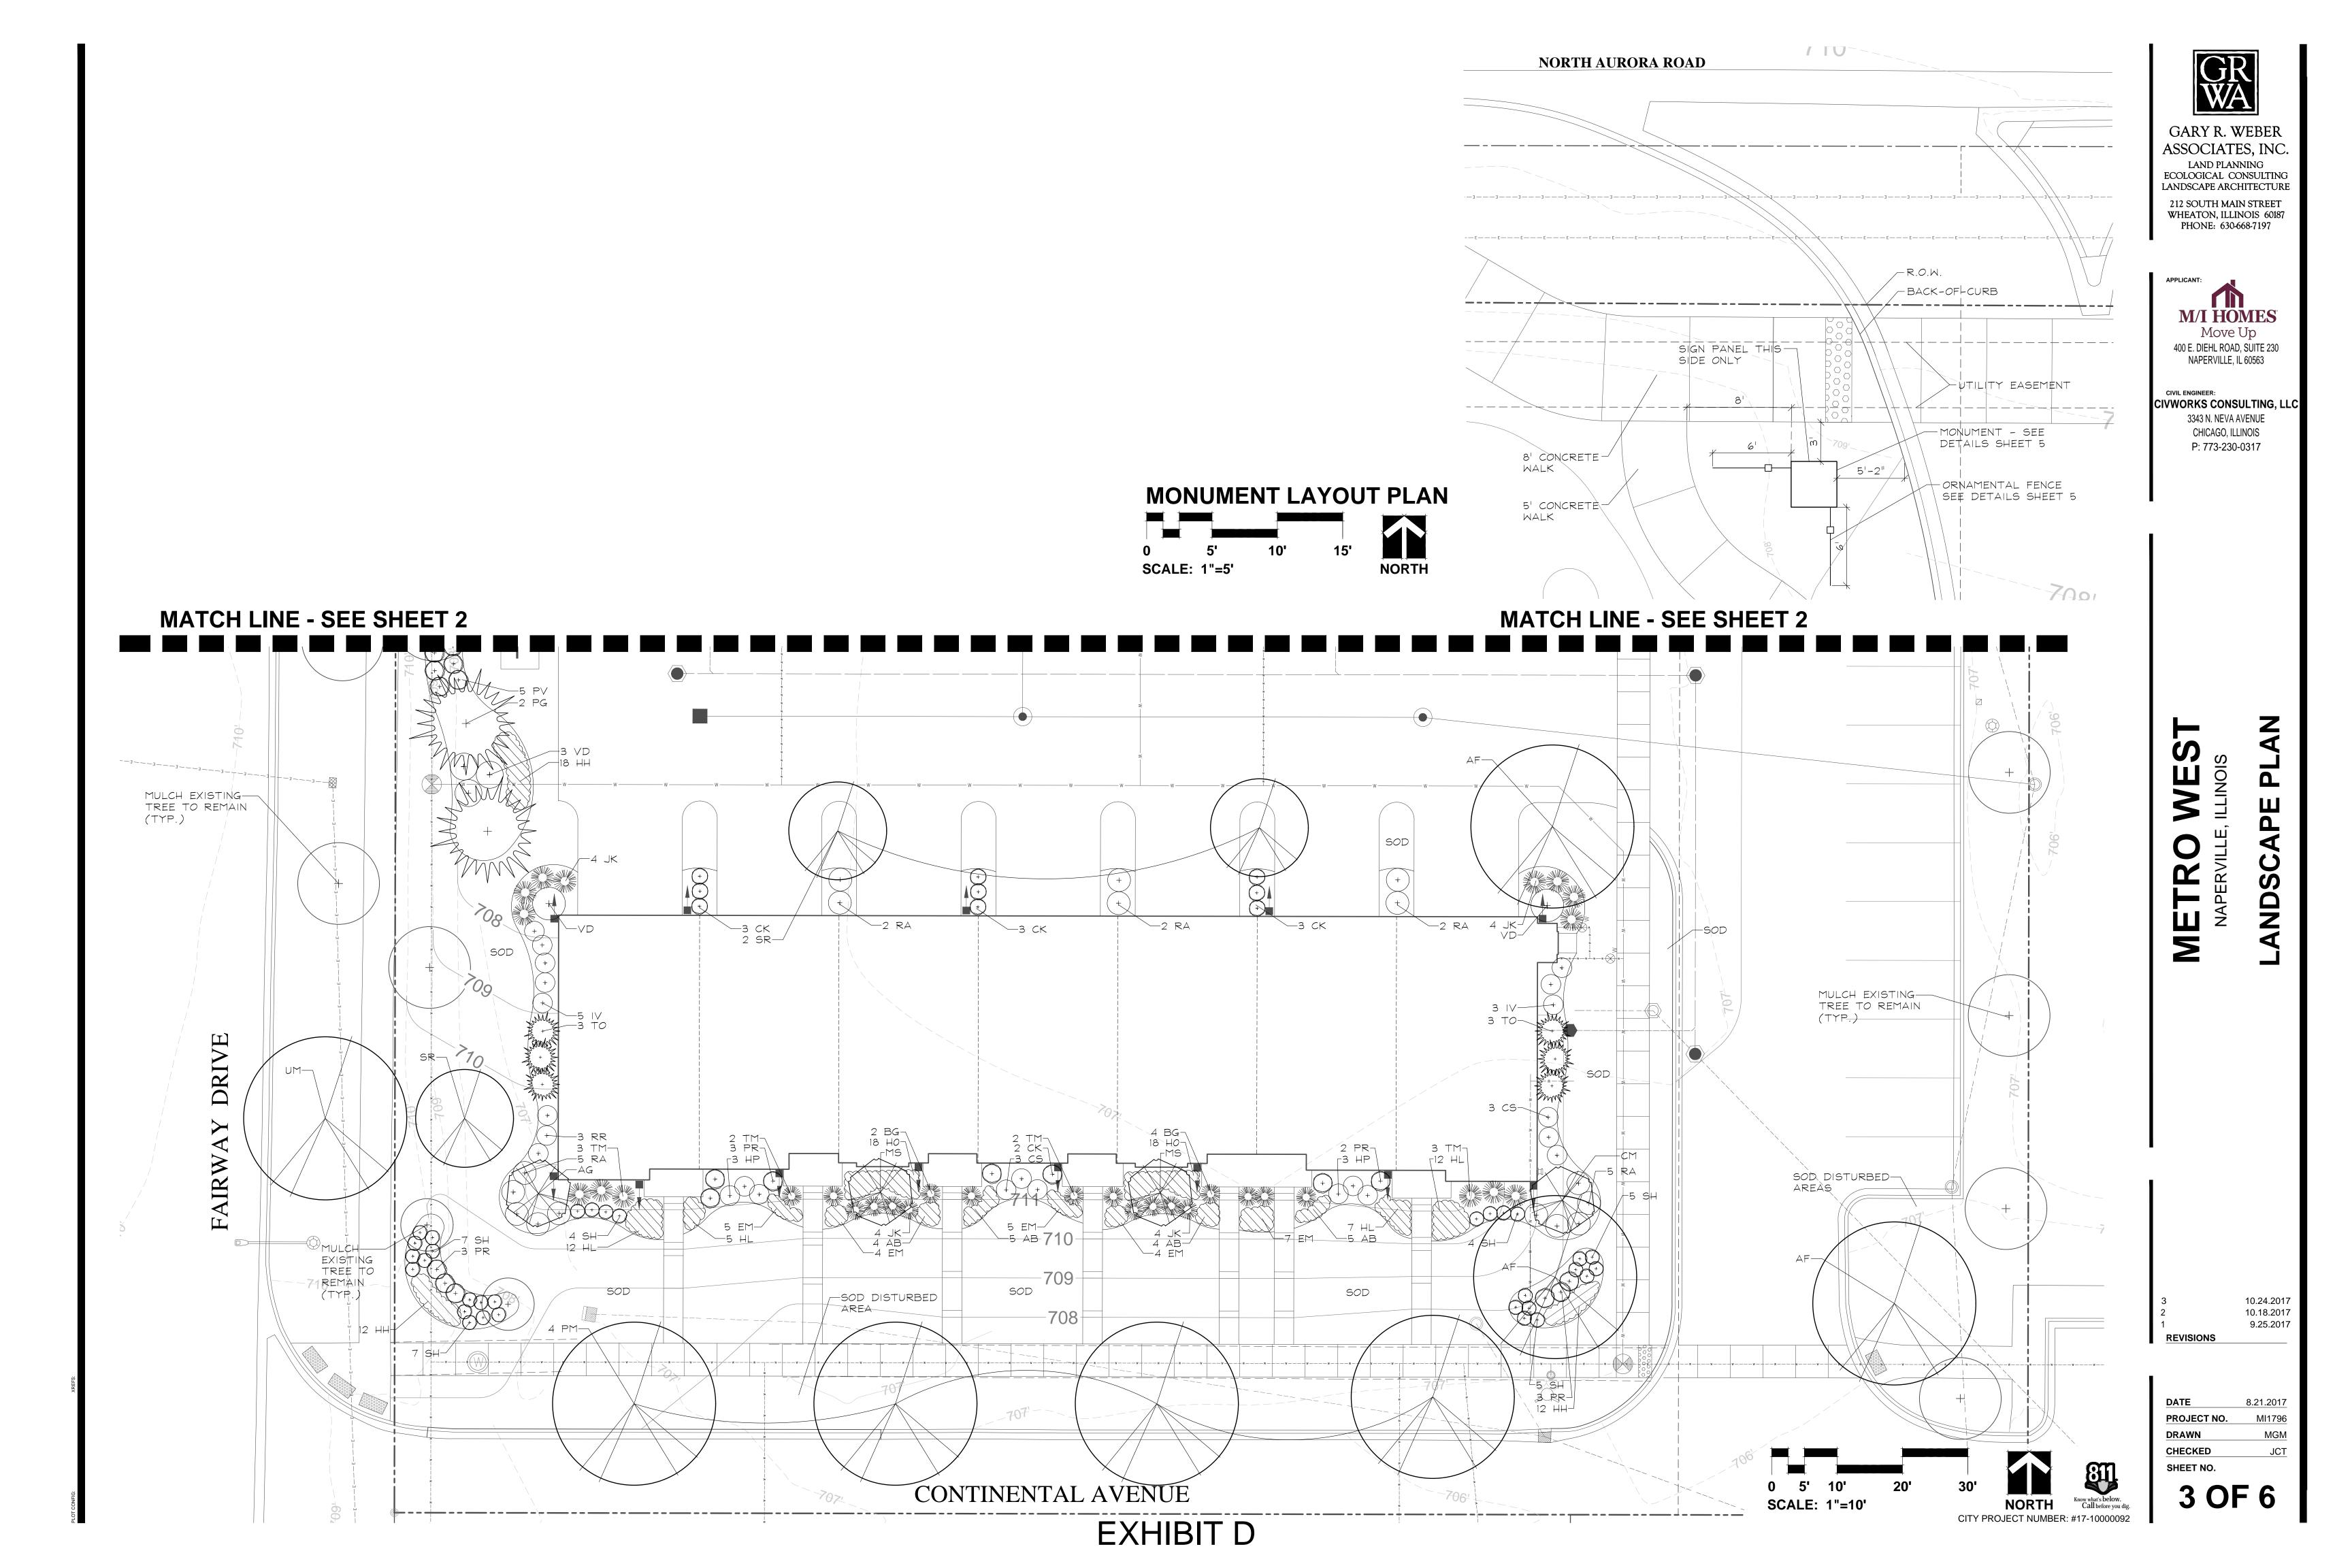

## **EXISTING TREE INVENTORY**

TAG NO.	BOTANICAL NAME	<b>COMMON NAME</b>	SIZE	HEALTH/STRUCTURE	PROPOSED ACTION
2935	Pyrus calleryana	Callery Pear	7"	Good	Preserve
2936	Pyrus calleryana	Callery Pear	10"	Good	Preserve
2937	Pyrus calleryana	Callery Pear	9"	Good	Preserve
2938	Pyrus calleryana	Callery Pear	7"	Fair; Sparse crown	Preserve
2939	Pyrus calleryana	Callery Pear	9"	Good	Preserve
2940	Pyrus calleryana	Callery Pear	8"	Fair; Sparse crown	Preserve
2941	Pyrus calleryana	Callery Pear	7"	Poor; Sparse crown	Preserve
2942	Pyrus calleryana	Callery Pear	10"	Good	Remove
2943	Pyrus calleryana	Callery Pear	7"	Fair; Sparse crown	Preserve
2944	Pyrus calleryana	Callery Pear	9"	Good	Preserve
2945	Pyrus calleryana	Callery Pear	10"	Poor; Split Risk	Preserve
2946	Pyrus calleryana	Callery Pear	9"	Poor; Dead limbs, sparse crown	Preserve
2947	Pyrus calleryana	Callery Pear	9"	Fair; Dead limbs	Preserve
2948	Pyrus calleryana	Callery Pear	7"	Poor; Dead limbs	Preserve
2949	Pyrus calleryana	Callery Pear	7"	Poor; Dead limbs, sparse crown	Preserve
2950	Pyrus calleryana	Callery Pear	9"	Fair; Missing/Dead Limbs	Preserve
2951	Pyrus calleryana	Callery Pear	10"	Good	Preserve
2952	Morus spp.	Mulberry	8"	Poor	Remove
2953	Gleditsia triacanthos	Honey Locust	4",4",3.5"	Poor; Split Risk	Remove
2954	Populus deltoides	Eastern Cottonwood	20"	Good	Preserve
2955	Populus deltoides	Eastern Cottonwood	16"	Good	Preserve
2956	Acer sacchrum	Sugar Maple	7"	Fair; Crowded	Preserve
2957	Acer sacchrum	Sugar Maple	7"	Fair; Leaning	Preserve
2958	Acer sacchrum	Sugar Maple	7"	Good	Preserve
2959	Acer x freemanii	Autumn Blaze Maple	7"	Good	Preserve
2960	Acer sacchrum	Sugar Maple	9"	Good	Preserve
2961	Acer x freemanii	Autumn Blaze Maple	7"	Fair; Leaning	Preserve
2962	Acer sacchrum	Sugar Maple	10"	Good	Preserve
2963	Acer sacchrum	Sugar Maple	10"	Good	Preserve
2964	Acer sacchrum	Sugar Maple	10"	Good	Preserve
2965	Acer sacchrum	Sugar Maple	8"	Fair; Leaning	Preserve
2911	Fraxinus pennsylvanica	Green Ash	3",3",3" 4"	Poor	Remove
2912	Fraxinus pennsylvanica	Green Ash	8",3",3" 3"	Poor	Remove
2913	Fraxinus pennsylvanica	Green Ash	8"	Poor	Remove
2914	Fraxinus pennsylvanica	Green Ash	8", 2", 2", 2"	Poor	Remove

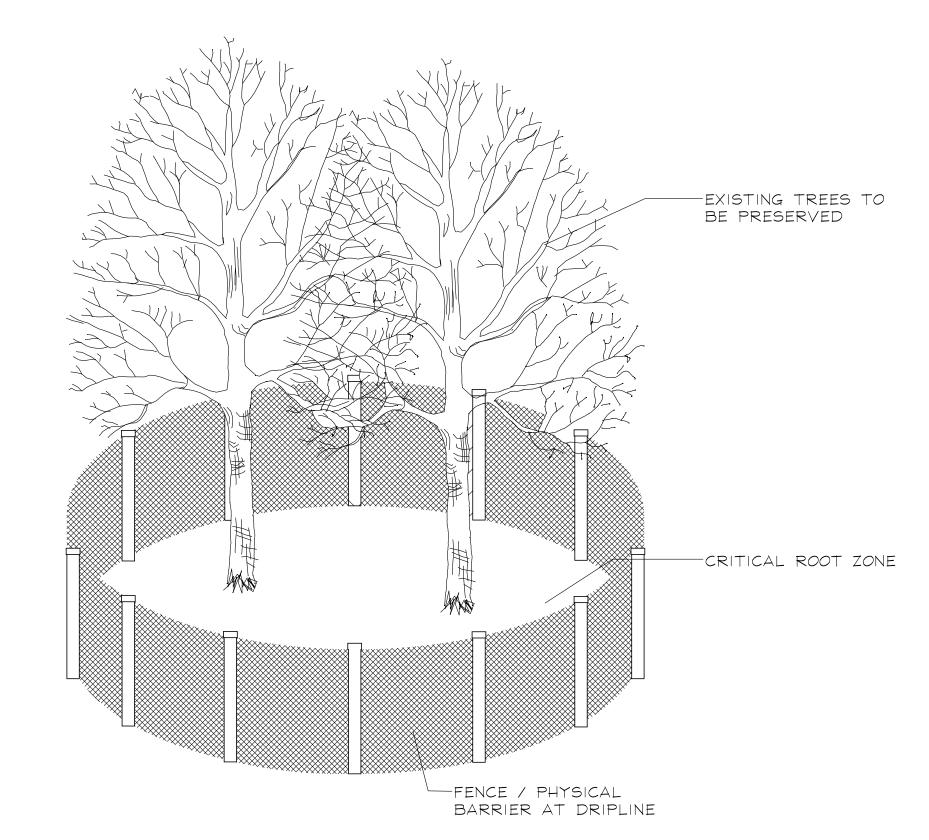

### TREE PRESERVATION DETAIL






**EXISTING TREE TO BE PRESERVED** 




**EXISTING TREE TO BE REMOVED** 

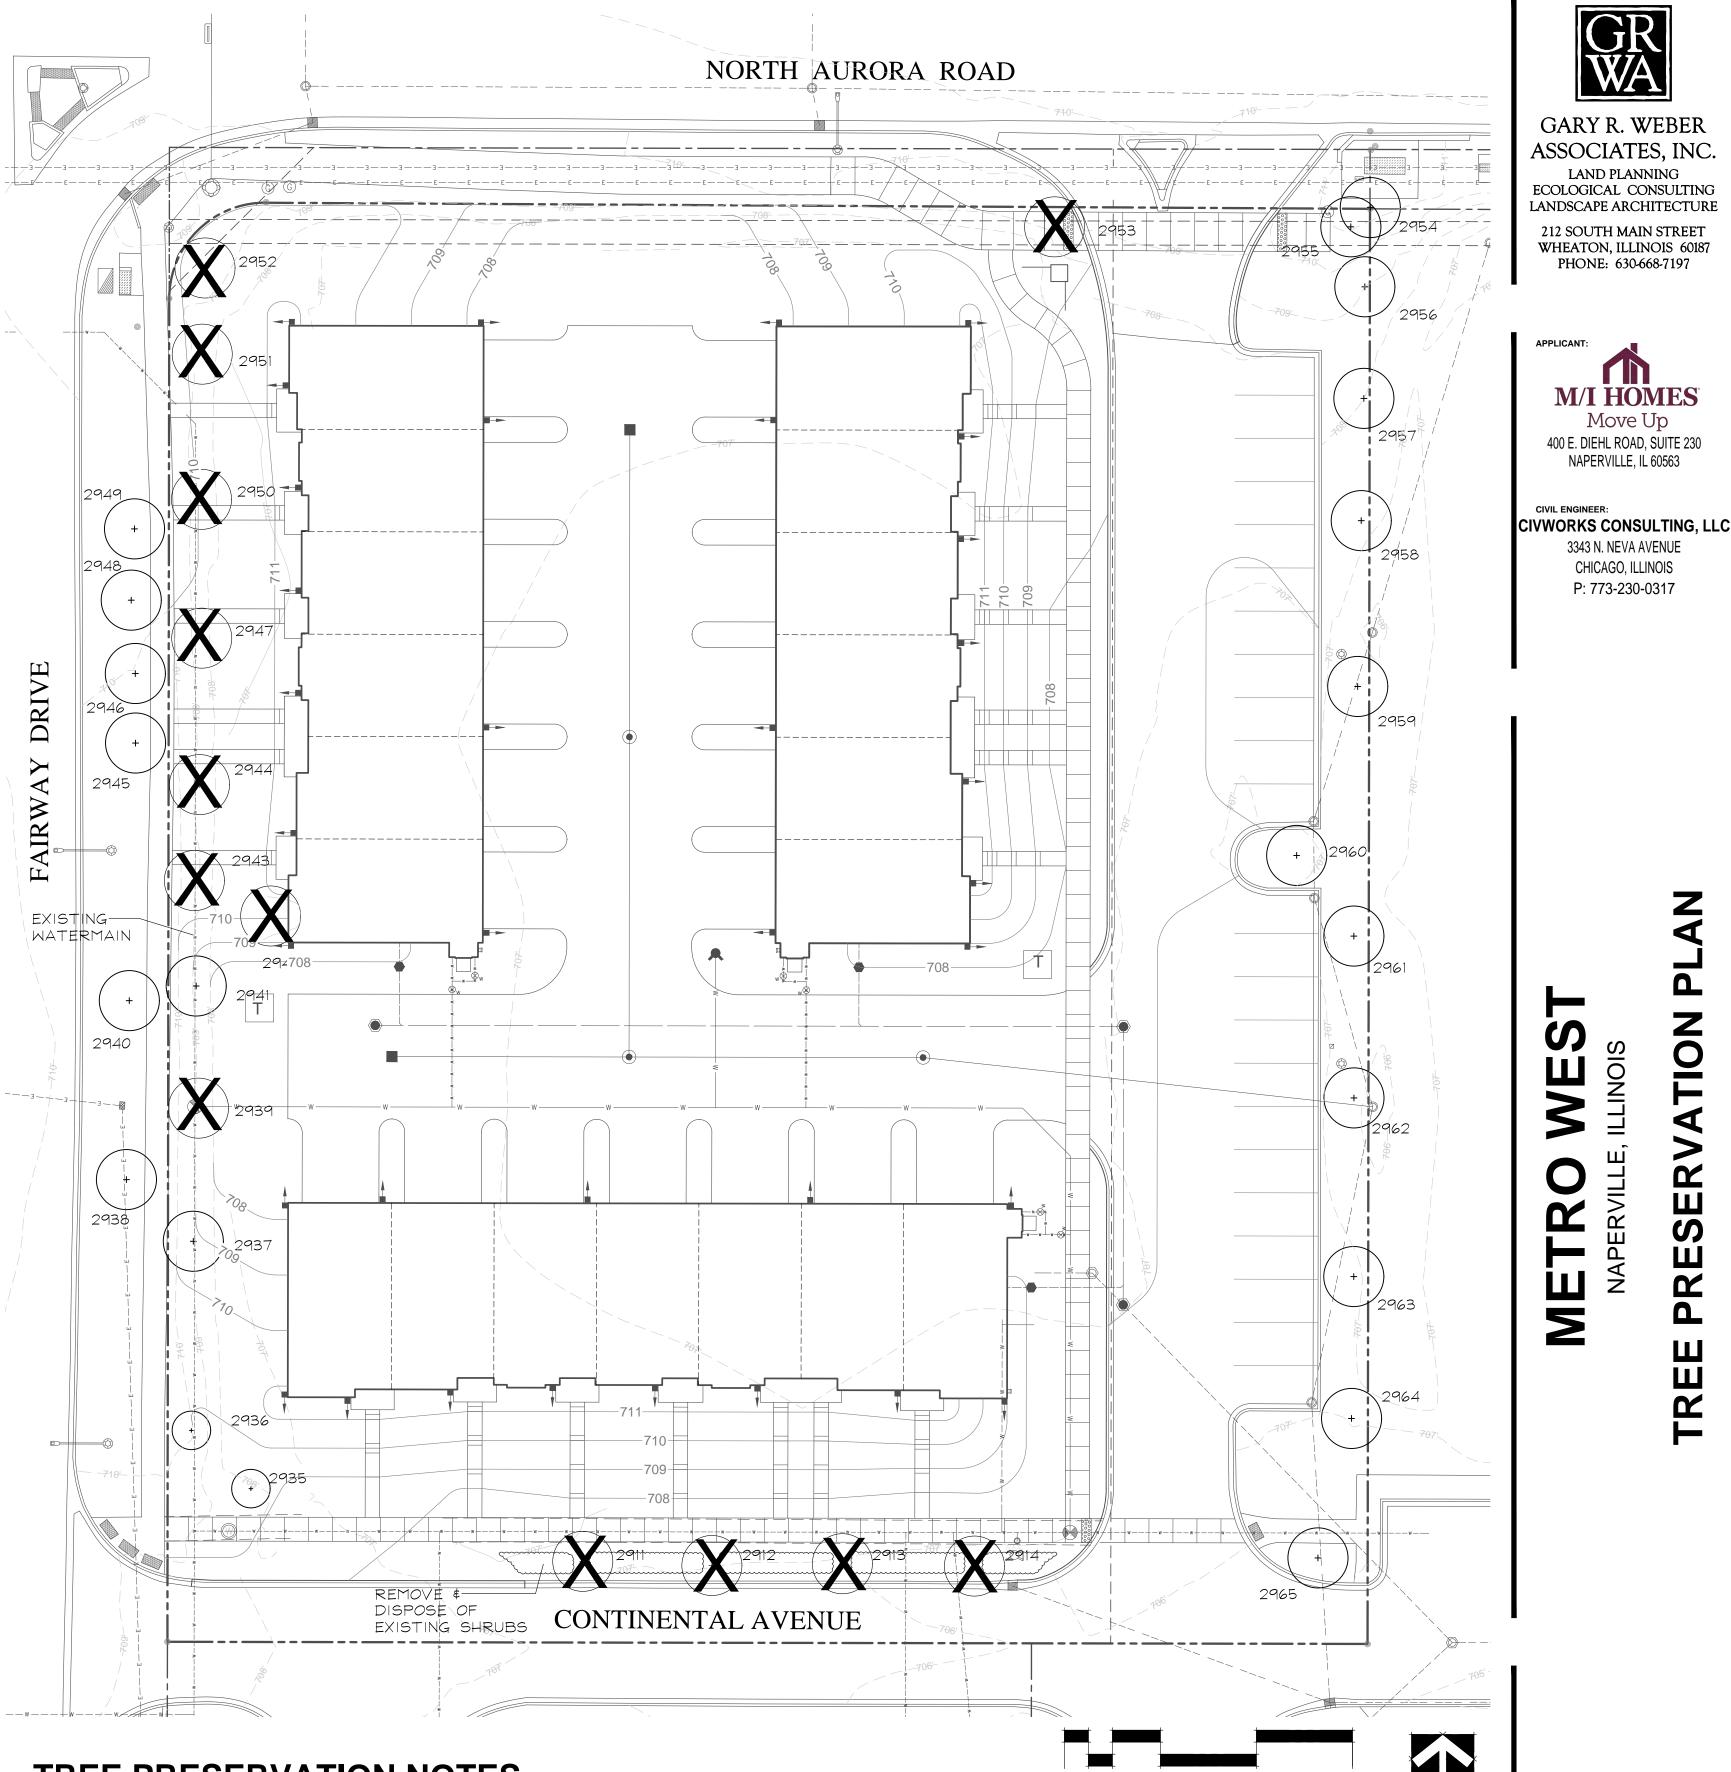

## TREE PRESERVATION NOTES

- 1. 48" high snow fence or wood barriers shall extend to the dripline of the tree or tree mass whenever possible, shall be installed before construction begins, and should not be removed until the completion of construction.
- 2. All accidental damage to existing trees that are to be preserved shall be promptly treated as required in accordance with recognized horticultural practices and the instructions of the professional Arborist, Landscape Architect or Horticulturist.
- 3. Broken or badly bruised branches shall be removed with a clean cut. If recommended by the professional Arborist, Landscape Architect or Horticulturist.
- 4. Care shall be exercised by the contractors to protect all overhead limbs and branches from damage by contact with material, machinery or equipment and by damage from engine exhaust.
- 5. Contractors shall protect trees and vegetation against spills or discharge of fuels, lubricating oils, hydraulic fluids, anti-freeze and coolants, calcium chloride, lime and all other similar hydrocarbons, organic chemicals, and other materials which can be harmful.
- 6. When underground utilities are proposed within 5' of a preserved tree trunk, they must be

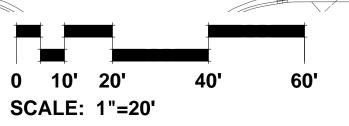



LAND PLANNING

PHONE: 630-668-7197

M/I HOMES Move Up

3343 N. NEVA AVENUE CHICAGO, ILLINOIS P: 773-230-0317

8.21.2017 CHECKED






CITY PROJECT NUMBER: #17-10000092

**SECTION B** 

**SECTION A** 

**MONUMENT DETAILS** 

SCALE: 1/2"=1'-0"

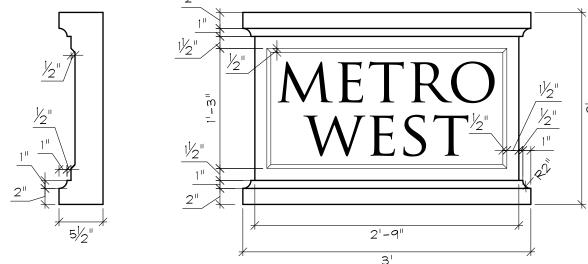

SIGN PANEL DETAIL SCALE: 1"=1'-0"

NOTES:

1. BRICK & MORTAR

TO MATCH BUILDING ARCHITECTURE 2. PRECAST CONCRETE ARCHITECTURAL PRECAST

3 FENCE HOME SERIES: ONYX BY ACTIVEYARDS OR APPROVED EQUAL COLOR: BLACK HEIGHT: 4' PANEL LENGTH: 6'

COLOR: LIMESTONE

APPLICANT: M/I HOMES Move Up 400 E. DIEHL ROAD, SUITE 230 NAPERVILLE, IL 60563

GARY R. WEBER

ASSOCIATES, INC.

LAND PLANNING

ECOLOGICAL CONSULTING

LANDSCAPE ARCHITECTURE

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P: 773-230-0317

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10.24.2017 10.18.2017 9.25.2017

DATE 8.21.2017 MI1796 MGM

CHECKED SHEET NO.

REVISIONS

-ARCHITECTURAL PRECAST CAP, INSURE POSITIVE DRAINAGE PRECAST SIGN PANEL  $\leftarrow$ 10 (ONE PIECE) WITH CAST IN PLACE LÉTTERS 3'-11" 3'-11" FONT: TRAJAN PRO ARCHITECTURAL PRECAST CAP HEIGHT: 6" 3'-7" ENSURE POSITIVE DRAINAGE COLOR: BLACK ARCHITECTURAL ATTACH WITH STAINLESS NORTH SIDE PRECAST CAP, STEEL PINS SEE DETAIL INSURE POSITIVE R 2 1/2" -ENGRAVED CONTINUOUS DRAINAGE ORNAMENTAL FENCE, DRIP, ALL SIDES. SEE NOTES -VINYL FLASHING - CAULK EDGE -BRICK ALL SIDES, METRO -BRICK, ALL SIDES, SEE NOTE SEE NOTE BLOCK MASONRY WITH -BRICK, ALL SIDES, SEE NOTE WEST -BRICK SOLDIER REINFORCED CONCRETE INFILL COURSE ALL SIDES, -PRECAST SIGN PANEL, SEE -BRICK SOLDIER COURSE, ALL SEE NOTE  $D \rightarrow$ SIDES. SEE NOTE ARCHITECTURAL -BRICK SOLDIER COURSE PRECAST SURROUND, -ARCHITECTURAL PRECAST " COLLAR JOINT SEE NOTE SURROUND, SEE NOTE -PRECAST VENEER, ALL SIDES ATTACH WITH STAINLESS STEEL PINS FINISHED GRADE SET FENCE POSTS IN MIN. FINISHED GRADE MIN. 42" DEEP REINFORCED 42" DEPTH CONCRETE CONCRETE FOUNDATION TO FOUNDATION AS BE DESIGNED BY RECOMMENDED BY 31-6<sup>lf</sup> 31-61 -MIN. 42" DEEP REINFORCED MANUFACTURER TYP. STRUCTURAL ENGINEER CONCRETE FOUNDATION TO PROVIDED BY CONTRACTOR MIN. 42" DEEP REINFORCED BE DESIGNED BY CONCRETE FOUNDATION TO STRUCTURAL ENGINEER BE DESIGNED BY PROVIDED BY CONTRACTOR STRUCTURAL ENGINEER PROVIDED BY CONTRACTOR COMPACTED SUBGRADE FRONT ELEVATION **SECTION C ELEVATION D** 

### **ENTRANCE MONUMENT SPECIFICATIONS**

A. The work consists of all labor, materials, work and equipment necessary and required to complete monuments, fence and foundations as shown on drawings or specified herein, including, but not limited to:

- 1. Submission of color and material samples
- 2. Submission of shop drawings
- 3. Submission of construction schedule
- 4. Verification of existing conditions and underground utilities
- 5. Secure and pay for all permits, fees, inspections and schedule all inspections related to work, including J.U.L.I.E. locates.
- 6. Comply with all applicable codes

2.0 QUALITY ASSURANCE

- A. Construction shall conform to @Building Code Requirements for Engineered Brick Masonry," BIA, latest edition.
- B. All brick and stone shall be finest architectural grade free of cracks, chips, defects, etc.
- C. Installation shall be by a company continuously and regularly employed in the installation of brick and stone monuments for a period of at least 5 consecutive years. D. No masonry shall be laid when the temperature is expected to fall below 40 degrees F
- without freezing. No additives shall be used, unless approved in writing by the owner. E. All corners of monuments and piers are to be staked by engineer and verified by the

protect the work. Protect work from cold and frost and insure that mortar will harden

unless suitable means, submitted in writing to the owner, are provided to heat materials and

#### 3.0 JOB CONDITIONS

- A. Examine and evaluate grades, and soils. Provide soil testing and verify soils structural integrity. Observe the conditions under which work is to be performed and notify the owner of unsatisfactory conditions. Do not proceed with the work until unsatisfactory conditions have been corrected in an acceptable manner.
- B. Utilities: Review underground utility location maps and plans; Notify J.U.L.I.E.; demonstrate an awareness of utility locations; and certify acceptance of liability for the protection of utilities during course of work. Contractor shall be responsible for any damage to utilities or
- C. All streets and curbs must be cleaned at the end of each working day.
- D. All OSHA requirements for safety must be adhered to at all times.

#### 4.0 GUARANTEES

- A. Guarantee monuments I year from final acceptance on owner's representative on workmanship
- B. Where failures have occurred resulting from the concrete not meeting the specified design strength, or workmanship, it shall be the responsibility of the subcontractors in connection with the supplier to take whatever corrective actions are necessary to eliminate the problem. In addition, it shall be their responsibility to make restitution for their resulting repair work created by the problem.

#### 5.0 SUBMITTALS

- A. Construction Schedule: After award of the Contract, the Contractor shall prepare and submit to the owner or an owner authorized representative an estimated construction progress schedule for the work, including sub-schedules of related activities which are essential to its progress, as well as lead-time for materials.
- 1. Show complete sequence of construction by activity, with dates for beginning and completion of each element of construction. Schedule to represent a continuous flow of construction activities so that there are no days of non-activity on site.
- B. Product Samples: Submit samples of stone, architectural pre-cast, mortars and sealants, slate, light fixtures, tile, and ornamental fencing for the owner's design conformance review prior to delivery to site.
- C. Product Data: Submit product data for stone, limestone, architectural pre-cast, mortars and joint sealants, slate, tile, light fixtures, and ornamental fencing.
- D. Provide certificate of insurance per the owner's requirements.
- E. Provide names and contact information for any subcontractors and suppliers.

#### F. Shop Drawings:

- 1. Prepare and submit to the Owner's Representative for design conformance review complete cutting and setting drawings for all masonry work:
- 2. Submit one (1) set prints with following items in detail
- a) Sizes
- b) Sections

contract drawings

- c) Dimensions and numbering of stone and brick.
- d) Arrangements of joints and bond.
- 3. Show jointing as indicated on the contract drawings, unless modification is reviewed for design conformance by Owner's Representative prior to preparation of shop drawings. 4. Establish jointing in accordance with industry standards and practices where not indicated on

- 6.0 PRODUCT DELIVERY, STORAGE, AND HANDLING
- A. Loading and Shipment: 1. Pack carefully for transportation, with exercise of all customary and reasonable precautions against damage in transit, all brick, and limestone to be used for the work.
- 2. Load and ship all brick and cut stone in a sequence mutually agreed upon by the General Contractor and the material supplier.
- B. Unloading and Storage:
- 1. Receive and unload at site all brick and stone with necessary care in handling to avoid
- 2. Store brick and stone clear of ground on non-staining skids. Wood containing tannin, chemical treatment, or excessive amounts of resin shall not be used.
- 3. Cover brick and stone with waterproof, clean canvas, or polyethylene for protection from construction or natural elements
- 7.0 INSTALLATION
- 1. Cement: white, non-staining masonry cement, conforming to ASTM-C91.
- 2. Sand: Clean, sharp, and washed, capable of passing a No. 16 sieve, and in conformance with ASTM-CIAA. Carefully select sand for use in pointing mortar for color to match limestone. For pointing mortar, select a white sand.
- 3. Lime: Hydrated, conforming to ASTM-C207, Type S.
- 4. Water: Clear, non-alkaline, potable and free of oils, salts, and other harmful elements. B. Foundation
- Concrete mix air entrainment, compressive strength at twenty-eight (28) days, and slump are to be designed and specified by the contractor's structural engineer.
- 1. Lay brick with full mortar coverage on horizontal and vertical joints in all courses.
- 2. Provide sufficient mortar on ends of brick to completely fill head joints. 3. Rock closure into place with head joints thrown against two adjacent bricks in place.
- D. Mortar Joints; Horizontal and vertical face joints:
- 2. Construct uniform joints.

1. Nominal thickness: 3/8 inch.

3. Shove vertical joints tight.

- - 5. Width, depth, and tooling of all mortar joints shall be consistent and shall not vary more

  - 6. Movement joints: Keep clean of all mortar and debris.
  - E. Flashing: 1. Install complete and continuous under stone copings and other projections.

4. Tool concave joints in exposed surfaces when thumbprint hard.

- 2. Lap joints 6". Seal entire contact surface with mastic. 3. Provide a mortar wash at the base of the cavity, underneath the through-wall flashing, pitching out.
- 4. Cover flashing with mortar.
- 1. Provide 3/8" cotton rope weeps. Rope weeps shall extend thru the veneer face and inside the cavity, lying on top and along the bottom length of the flashing. Cut rope flush with
- 2. Maximum spacing: rope weeps: 16 inches o.c., at wall base; 16 inches o.c. at lintels above
- 3. Keep weepholes and area above flashing free of mortar droppings. 8.0 CLEAN UP AND PROTECTION
- A. All material shall be washed with fiber brushes, soap powder, and clean water or Owner reviewed mechanical cleaning process.
- B. Sand blasting, wire brushes, or acids shall not be used. Exceptions may be considered if reviewed by the Owner or an Owner authorized representative.
- C. During work, store materials and equipment as directed by the owner.
- D. Protect work and materials from damage due to operations by other trades and trespassers. Maintain protection during installation. 9.0 INSPECTION AND ACCEPTANCE
- A. The Owner and or the Owner's representative reserves the right to inspect materials and workmanship at the site prior to, during construction, or at the time of inspection for compliance with these specifications.
- B. Notify the Owner's representative when completed, for final design conformance review.



CITY PROJECT NUMBER: #17-10000092

EXHIBIT D

#### 1.1 DESCRIPTION OF WORK

The work shall consist of furnishing, transporting and installing all seeds, plants and other materials required for:

- 1. The establishment of trees, shrubs, perennial, annual and lawn areas as shown on Landscape Plan;
- 2. The provision of post-planting management as specified herein;
- 3. Any remedial operations necessary in conformance with the plans as specified in this document:
- 4. Permits which may be required.

#### 1.2 QUALITY ASSURANCE

- A. Work shall conform to State of Illinois Horticultural Standards and local municipal requirements.
- B. Quality Control Procedures:
- 1. Ship landscape materials with certificates of inspection as required by governmental authorities. Comply with governing regulations applicable to landscape materials.
- 2. Do not make substitutions. If specified landscape material is not obtainable, submit to Landscape Architect proof of non-availability and proposal for use of equivalent material.
- 3. Analysis and Standards: Package standard products with manufacturer's certified analysis.

#### 1.3 SUBMITTALS

#### A. Planting Schedule

Submit three (3) copies of the proposed planting schedule showing dates for each type of planting

#### B. Maintenance Instruction - Landscape Work

Submit two (2) copies of typewritten instructions recommending procedures to be established by the Owner for the maintenance of landscape work for one full year. Submit prior to expiration of required maintenance periods.

Instructions shall include: watering, fertilizing, spraying, mulching and pruning for plant material and trimming groundcover. Instructions for watering, fertilizing and mowing grass areas shall be provided ten (10) days prior to request for inspection for final acceptance. Landscape Architect shall receive copies of all instructions when issued.

- C. Submit two (2) copies of soil test of existing topsoil with recommendations for soil additive requirement to Landscape Architect for review and written approval.
- D. Submit two (2) samples of shredded hardwood bark mulch, erosion control blankets, and all other products and materials as specified on plans to Landscape Architect for review and written approval.
- E. Nursery packing lists indicating the species and quantities of material installed must be provided to the Owner and/or City upon request.

#### 1.4 JOB CONDITIONS

- A. Examine and evaluate grades, soils and water levels. Observe the conditions under which work is to be performed and notify Landscape Architect of unsatisfactory conditions. Do not proceed with the work until unsatisfactory conditions have been corrected in an acceptable manner.
- B. Utilities: Review underground utility location maps and plans; notify local utility location service; demonstrate an awareness of utility locations; and certify acceptance of liability for the protection of utilities during course of work. Contractor shall be responsible for any damage to utilities or property.
- C. Excavation: When conditions detrimental to plant growth are encountered such as rubble fill, adverse drainage conditions or obstructions, notify Landscape Architect before planting.

#### 1.5 GUARANTEES

- A. Guarantee seeded and sodded areas through the specified maintenance period and until final acceptance.
- B. Guarantee trees, shrubs, groundcover and perennials for a period of one year after date of acceptance against defects including death and unsatisfactory growth, except for defects resulting from neglect by Owner, abuse or damage by others or unusual phenomena or incidents which are beyond Landscape Installer's control.
- C. Guarantee shade trees indicated as replacement trees for a period of three years after date of acceptance against defects including death and unsatisfactory growth, except for defects resulting from neglect by Owner, abuse or damage by others or unusual phenomena or incidents which are beyond Landscape Installer's control.

#### LANDSCAPE WORK PART 2 - PLANT MATERIALS

#### 2.1 LAWN SOD

Provide strongly rooted sod, not less than two (2) years old and free of weeds and undesirable native grasses. Provide only sod capable of growth and development when planted (viable, not dormant) and in strips not more than 18" wide x 4' long. Provide sod composed of a 5-way blend of Kentucky Bluegrass such as: Midnight, Allure, Viva, Washington, Liberty.

#### 2.2 PLANTING SOIL MIXTURE

Provide planting soil mixture consisting of clean uncompacted topsoil (stockpiled at site) for all planting pits, perennial, annual and groundcover areas. Topsoil shall be conditioned based on any recommendations resulting from the soil test in 1.3.C.

#### 2.3 AMENDED SOIL MIXTURE

Provide amended soil mixture consisting of 20% sand, 30% compost \$ 50% topsoil. Compost shall consist of 35% - 65% organic material and less than 1% manufactured inert material. Amended soil mixture shall pass through a 1/2" screen. Mix materials thoroughly.

#### 2.4 EROSION CONTROL

- A. Native Areas Erosion Control Blanket: Futerra EnviroNet, or equivalent approved equal.
- B. Shoreline and Sloped Berm Areas Erosion Control Blanket: Futerra EnviroNet, or approved equal. To be installed per manufacturer's recommendations.

#### 2.5 MULCH

Provide mulch consisting of shredded hardwood. Provide sample to Landscape Architect for approval prior to ordering materials.

LANDSCAPE WORK PART 3 - EXECUTION

#### 3.1 PLANTING SCHEDULE

At least thirty (30) days prior to the beginning of work in each area, submit a planting schedule for approval by the Landscape Architect.

#### 3.2 PLANTINGS

#### A. Sodding New Lawns

- 1. Remove existing grass, vegetation and turf. Dispose of such material legally off-site, do not turn over into soil being prepared for lawns.
- 2. Till to a depth of not less than 6"; apply soil amendments as needed; remove high areas and fill in depressions; till soil to a homogenous mixture of fine texture, remove lumps, clods, stones over 1" diameter, roots and other extraneous matter. Dispose of such material legally off-site.
- 3. Sodded areas shall receive an application of commercial fertilizer at the rate of 10 lbs. per 1,000 sq. ft. and shall have an analysis of 16-8-8.
- 4. Lay sod within 24 hours from time of stripping.
- 5. Lay sod to form a solid mass with tightly fitted joints. Butt ends and sides of sod strips; do not overlap. Stagger strips to offset joints in adjacent courses. Work from boards to avoid damage to subgrade or sod. Tamp or roll lightly to ensure contact with subgrade. Work sifted soil into minor cracks between pieces of sod; remove excess to avoid smothering of adjacent grass.
- 6. Water sod thoroughly with a fine spray immediately after planting.

#### B. Groundcover and Perennial Beds

Groundcover, perennials, and annuals shall be planted in continuous beds of planting soil mixture a minimum of 8" deep. Install per spacina indicated on plan.

#### C. Trees and Shrubs

- 1. Set balled and burlapped (B&B) stock plumb and in center of pit or trench with top of ball at an elevation that will keep the root flare exposed upon backfill and mulching. Remove burlap from top and sides of balls; retain on bottoms. When set, place additional topsoil backfill around base and sides of ball and work each layer to settle backfill and eliminate voids and air pockets. When excavation is approximately 2/3 full, water thoroughly before placing remainder of backfill. Repeat watering until no more is absorbed. Water again after placing final layer of backfill.
- 2. Dish top of backfill to allow for mulching. Provide additional backfill berm around edge of excavations to form shallow saucer to collect water.
- 3. Mulch pits, trenches and planted areas. Provide not less than 2" thickness of mulch and work into top of backfill and finish level with adjacent finish grades. Maintain exposed root
- 4. Prune only injured or dead branches from flowering trees, if any. Protect central leader of tree during shipping and pruning operations. Prune shrubs to retain natural character in accordance with standard horticultural practices.
- 5. Remove and replace excessively pruned or ill-formed stock resulting from improper pruning.
- 6. The Contractor shall be wholly responsible for assuring that all trees are planted in a vertical and plumb position and remain so throughout the life of this contract and guarantee period. Trees may or may not be staked and guyed depending upon the individual preference of the Contractor; however, any bracing procedure(s) must be approved by the Owner prior to its installation.

#### 3.3 INITIAL MAINTENANCE

- A. Begin maintenance immediately after planting, continuing until final acceptance. A minimum of thirty (30) days.
- B. Maintain planted and seeded areas by watering, rolling/regrading, replanting and implementing erosion control as required to establish vegetation free of eroded or bare areas.

#### 3.5 CLEAN UP AND PROTECTION

- A. During landscape work, store materials and equipment where directed. Keep pavements clean and work areas and adjoining areas in an orderly condition.
- B. Protect landscape work and materials from damage due to landscape operations, operations by other trades and trespassers. Maintain protection during installation and maintenance periods. Treat, repair or replace damaged landscape work as directed by Landscape Architect.

#### 3.6 INSPECTION AND ACCEPTANCE

- A. The Landscape Architect reserves the right to inspect seeds, plants, trees and shrubs either at place of growth or at site before planting for compliance with requirements for name, variety, size, quantity, quality and mix proportion.
- B. Supply written affidavit certifying composition of seed mixtures and integrity of plant materials with respect to species, variety and source.
- C. Notify the Landscape Architect within five (5) days after completing initial and/or supplemental plantings in each area.
- D. When the landscape work is completed, including maintenance, the Landscape Architect will, upon request, make a final inspection to determine acceptability. After final acceptance, the Owner will be responsible for maintenance.

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SPECIFICATION

NAPERVILLE LANDSCAPE SP

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3 10.24.2017 2 10.18.2017 1 9.25.2017 **REVISIONS** 

DATE 8.21.2017
PROJECT NO. MI1796
DRAWN MGM
CHECKED JCT
SHEET NO.

