ARCHITECT:

ARCHITECTUAL STUDIOS, LTD 14421 Oakley Avenue Orland Park, IL 60462 (708) 933-4200

ENGINEER & SURVEYOR: ROGINA Engineers & Surveyors, LLC 1225 Channahon Road Joliet, IL 60436 (815) 729-0777 phone (815) 729-0782 fax

PROPOSEI)	EXISTING
	BOUNDARY LINE SECTION LINE LOT LINE	
	EASEMENT LINE SETBACK LINE	
•	MANHOLE USE NOTED	SAN
OR ■	CATCH BASIN	© OR ©
OR	INLET	oR IN
	FLARED END SECTION	
(B B)	WATER VALVE IN BOX	₩V
	WATER VALVE VAULT	\otimes
	FIRE HYDRANT	\Diamond
(c.o.)	SANITARY CLEAN OUT	_
	GAS VALVE	© E
	TELEPHONE PEDISTAL ELECTRIC TRANSFORMER	
	STREET LIGHT	_
Π—ο	PARKING LOT LIGHT	X
	SIGN	
<u> </u>	DOUBLE SIGN	\ominus
—)—)—	STORM SEWER	
	UNDER DRAIN)
	- SANITARY SEWER -	— → >
_ >	SANITARY SERVICE	>
v	WATER MAIN	W
- G – –	GAS MAIN	G
- E	ELECTRIC LINE	E
- T	TELEPHONE LINE	T
	CURB	
	CURB & GUTTER	
	DEPRESSED CURB SIDEWALK	
644	1 FOOT CONTOURS	644
+ 644.05	SPOT ELEVATION	+ 644.25
$\qquad \qquad \Box \gt$	OVERLAND FLOW	
	SWALE OR DITCH	m.
_	TREE W/ TAG #	* ***********************************
-0 0-	SILT FENCE	
	INLET PROTECTION	
	TRENCH BACKFILL	
DIP	DUCTILE IRON PIPE	DIP
RCP	REINFORCED CONCRETE F	PIPE RCP
	FLARED END SECTION	FES
TC	TOP CURB	TC
		. •

SITE DEVELOPMENT PLANS FOR WU'S HOUSE RESTAURANT

LOT 2 OF BRADFORD COMMONS RESUBDIVISION OF LOTS 5 & 6 SUBDIVISION CITY OF NAPERVILLE, DUPAGE COUNTY, ILLINOIS



BENCHMARKS

FF

FINISHED FLOOR

Know what's **below.**

SAT., SUN. & HOL.)

Call before you dig.

CALL TWO (2) BUSINESS DAYS

BEFORE YOU DIG (EXCLUDING

CALL 811 or 1-800-892-0123

NAPERVILLE GPS BENCHMARK 24 - STAINLESS STEEL ROD IN SLEEVE LOCATED AT THE SOUTHWEST CORNER OF FARM ENTRANCE ON ROUTE 59 OPPOSITE COSTCO RIGHT-IN/RIGHT-OUT ELEV.=707.62 NAVD88

NAPERVILLE GPS BENCHMARK 230 - STAINLESS STEEL ROD IN SLEEVE LOCATED ON THE WEST SIDE OF WHITE EAGLE DRIVE ON ROUTE 59 APPROXIMATELY 189' SOUTH OF MONARCH CIRCLE ELEV.=700.82 NAVD88

SITE BENCHMARK #1 - PK NAIL IN PAVEMENT LOCATED APPROXIMATELY 20' SOUTH OF THE PROPOSED NORTHWEST ENTRANCE SOUTH OF FITNESS DRIVE ELEV.=705.50 NAVD88

SITE BENCHMARK #2 - CUT 'X' IN EX. TOP OF CURB LOCATED APPROXIMATELY 46.5' NORTH OF THE SOUTHWEST CORNER OF PROPERTY. ELEV.=705.78 NAVD88

SITE MAP


N.T.S.


NOTE:

IT IS THE RESPONSIBILITY OF THE CONTRACTOR TO CONTACT THE CITY OF NAPERVILLE TED BUSINESS GROUP BY TELEPHONE AT (630)420-6100 AT LEAST TWO (2) WORKING DAYS IN ADVANCE BEFORE CONSTRUCTING ANY IMPROVEMENTS.

SHEET INDEX

- **COVER SHEET**
- **EXISTING CONDITIONS SURVEY**
- **DEMOLITION PLAN**
- PAVING & GEOMETRIC PLAN
- VEHICLE TURNING PLAN
- UTILITY PLAN
- **GRADING PLAN & STORMWATER** POLLUTION PREVENTION PLAN
- STORM WATER POLLUTION PREVENTION PLAN SPECIFICATIONS & DETAILS
- GENERAL NOTES & SPECIFICATIONS
- 10. CONSTRUCTION DETAILS
- 11. CONSTRUCTION DETAILS
- CONSTRUCTION DETAILS
- CONSTRUCTION DETAILS

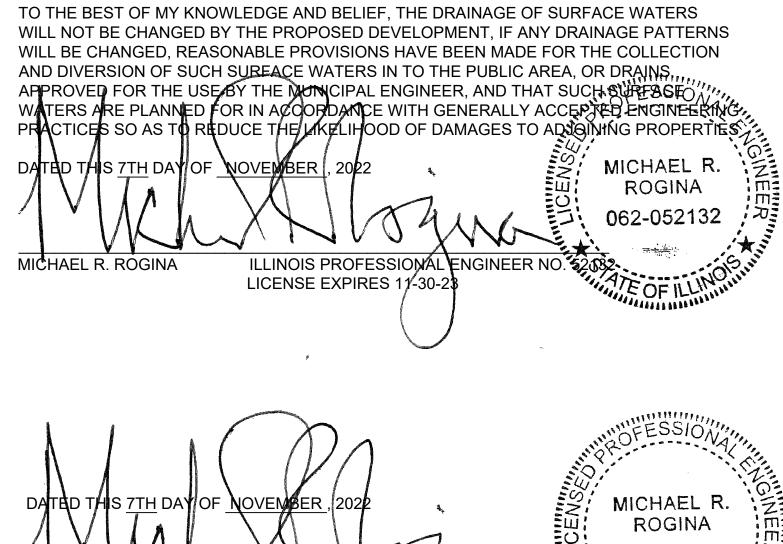

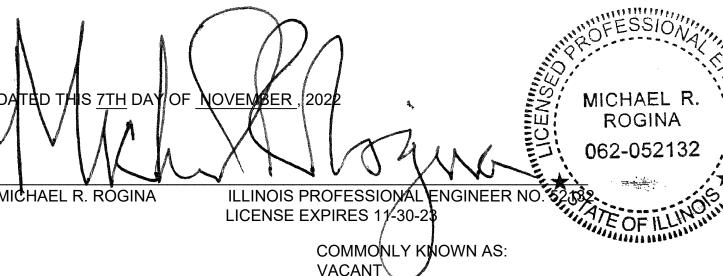


VACANT BEEBE DRIVE NAPERVILLE, ILLINOIS 60564


7/21/2022


REV. NO. 3 PER CITY OF NAPERVILLE REVIEW 11/07/2022 REV. NO. 2 PER CITY OF NAPERVILLE REVIEW 10/07/2022 REV. NO. 1 PER CITY OF NAPERVILLE REVIEW 9/09/2022

LOT 2 OF BRADFORD COMMONS RESUBDIVISION OF LOTS 5 & 6, BEING A SUBDIVISION OF PART OF THE SOUTHWEST QUARTER OF SECTION 27, TOWNSHIP 38 NORTH, RANGE 9 EAST OF THE THIRD PRINCIPAL MERIDIAN, ACCORDING TO THE PLAT THEREOF RECORDED SEPTEMBER 17, 2021 AS DOCUMENT No. R2021-139056, IN DUPAGE COUNTY, ILLINOIS. (IN FEET) 1 inch = 20 ft. N0°49'37"W 342.85'(R&M) 705.50 10' PUDE PER DOC. \$2005-246829 & S R2005-249736 호 10' PUDE PER DOC. R2005-246829 & 증증 第2005-249736 =704.79 =698.04 12" W-697.59 36" N 697.29 36" S PUDE PER DOC. R2005-246829 & 15' PUDE PER DOC, R2002-252767___ 337.72'(R&M) 2N0°49'37"W CONCRETE STDEWALK **BENCHMARKS** BEEBE DRIVE NAPERVILLE GPS BENCHMARK 24 - STAINLESS STEEL ROD IN SLEEVE LOCATED AT THE SOUTHWEST CORNER OF FARM ENTRANCE ON ROUTE 59 OPPOSITE COSTCO RIGHT-IN/RIGHT-OUT ELEV.=707.62 NAVD88 ൽ ൽ ലീ NAPERVILLE GPS BENCHMARK 230 - STAINLESS STEEL ROD IN SLEEVE LOCATED ON THE WEST SIDE OF WHITE EAGLE DRIVE ON ROUTE 59 APPROXIMATELY 189' SOUTH OF MONARCH CIRCLE ELEV.=700.82 NAVD88 SITE BENCHMARK #1 - PK NAIL IN PAVEMENT LOCATED APPROXIMATELY 20' SOUTH OF THE PROPOSED NORTHWEST ENTRANCE SOUTH OF FITNESS DRIVE ELEV.=705.50 NAVD88 SITE BENCHMARK #2 - CUT 'X' IN EX. TOP OF CURB LOCATED APPROXIMATELY 46.5' NORTH OF THE SOUTHWEST CORNER OF PROPERTY. ELEV.=705.78 NAVD88 COMMONLY KNOWN AS: 2703 BEEBE DRIVE NAPERVILLE, ILLINOIS 60564 PIN 07-27-300-031 Copyright © 2022 ROGINA Engineers & Surveyors LLC, All Rights Reserved ARCHITECTUAL STUDIOS, LTD PROJECT: SITE DEVELOPMENT PLANS FOR REVISIONS PROJECT NO: DESIGNED BY: **EXISTING CONDITIONS** MRR WU'S HOUSE RESTAURANT 14421 Oakley Avenue DRAWN BY: ENGINEERS & SURVEYORS, L.L.C. 1225 Channahon Road Joliet, Illinois 815/729-0777 FAX 815/729-0782 Professional Design Firm License No. 184-006843 - Exp. 4/30/2023 LOT 2 OF BRADFORD COMMONS RESUBDIVISION OF 7/21/2022 Orland Park, IL 60462 **SURVEY** LOTS 5 & 6 SUBDIVISION SCALE: CHECKED BY: (708) 933-4200 CITY OF NAPERVILLE, DUPAGE COUNTY, ILLINOIS 1"=20'

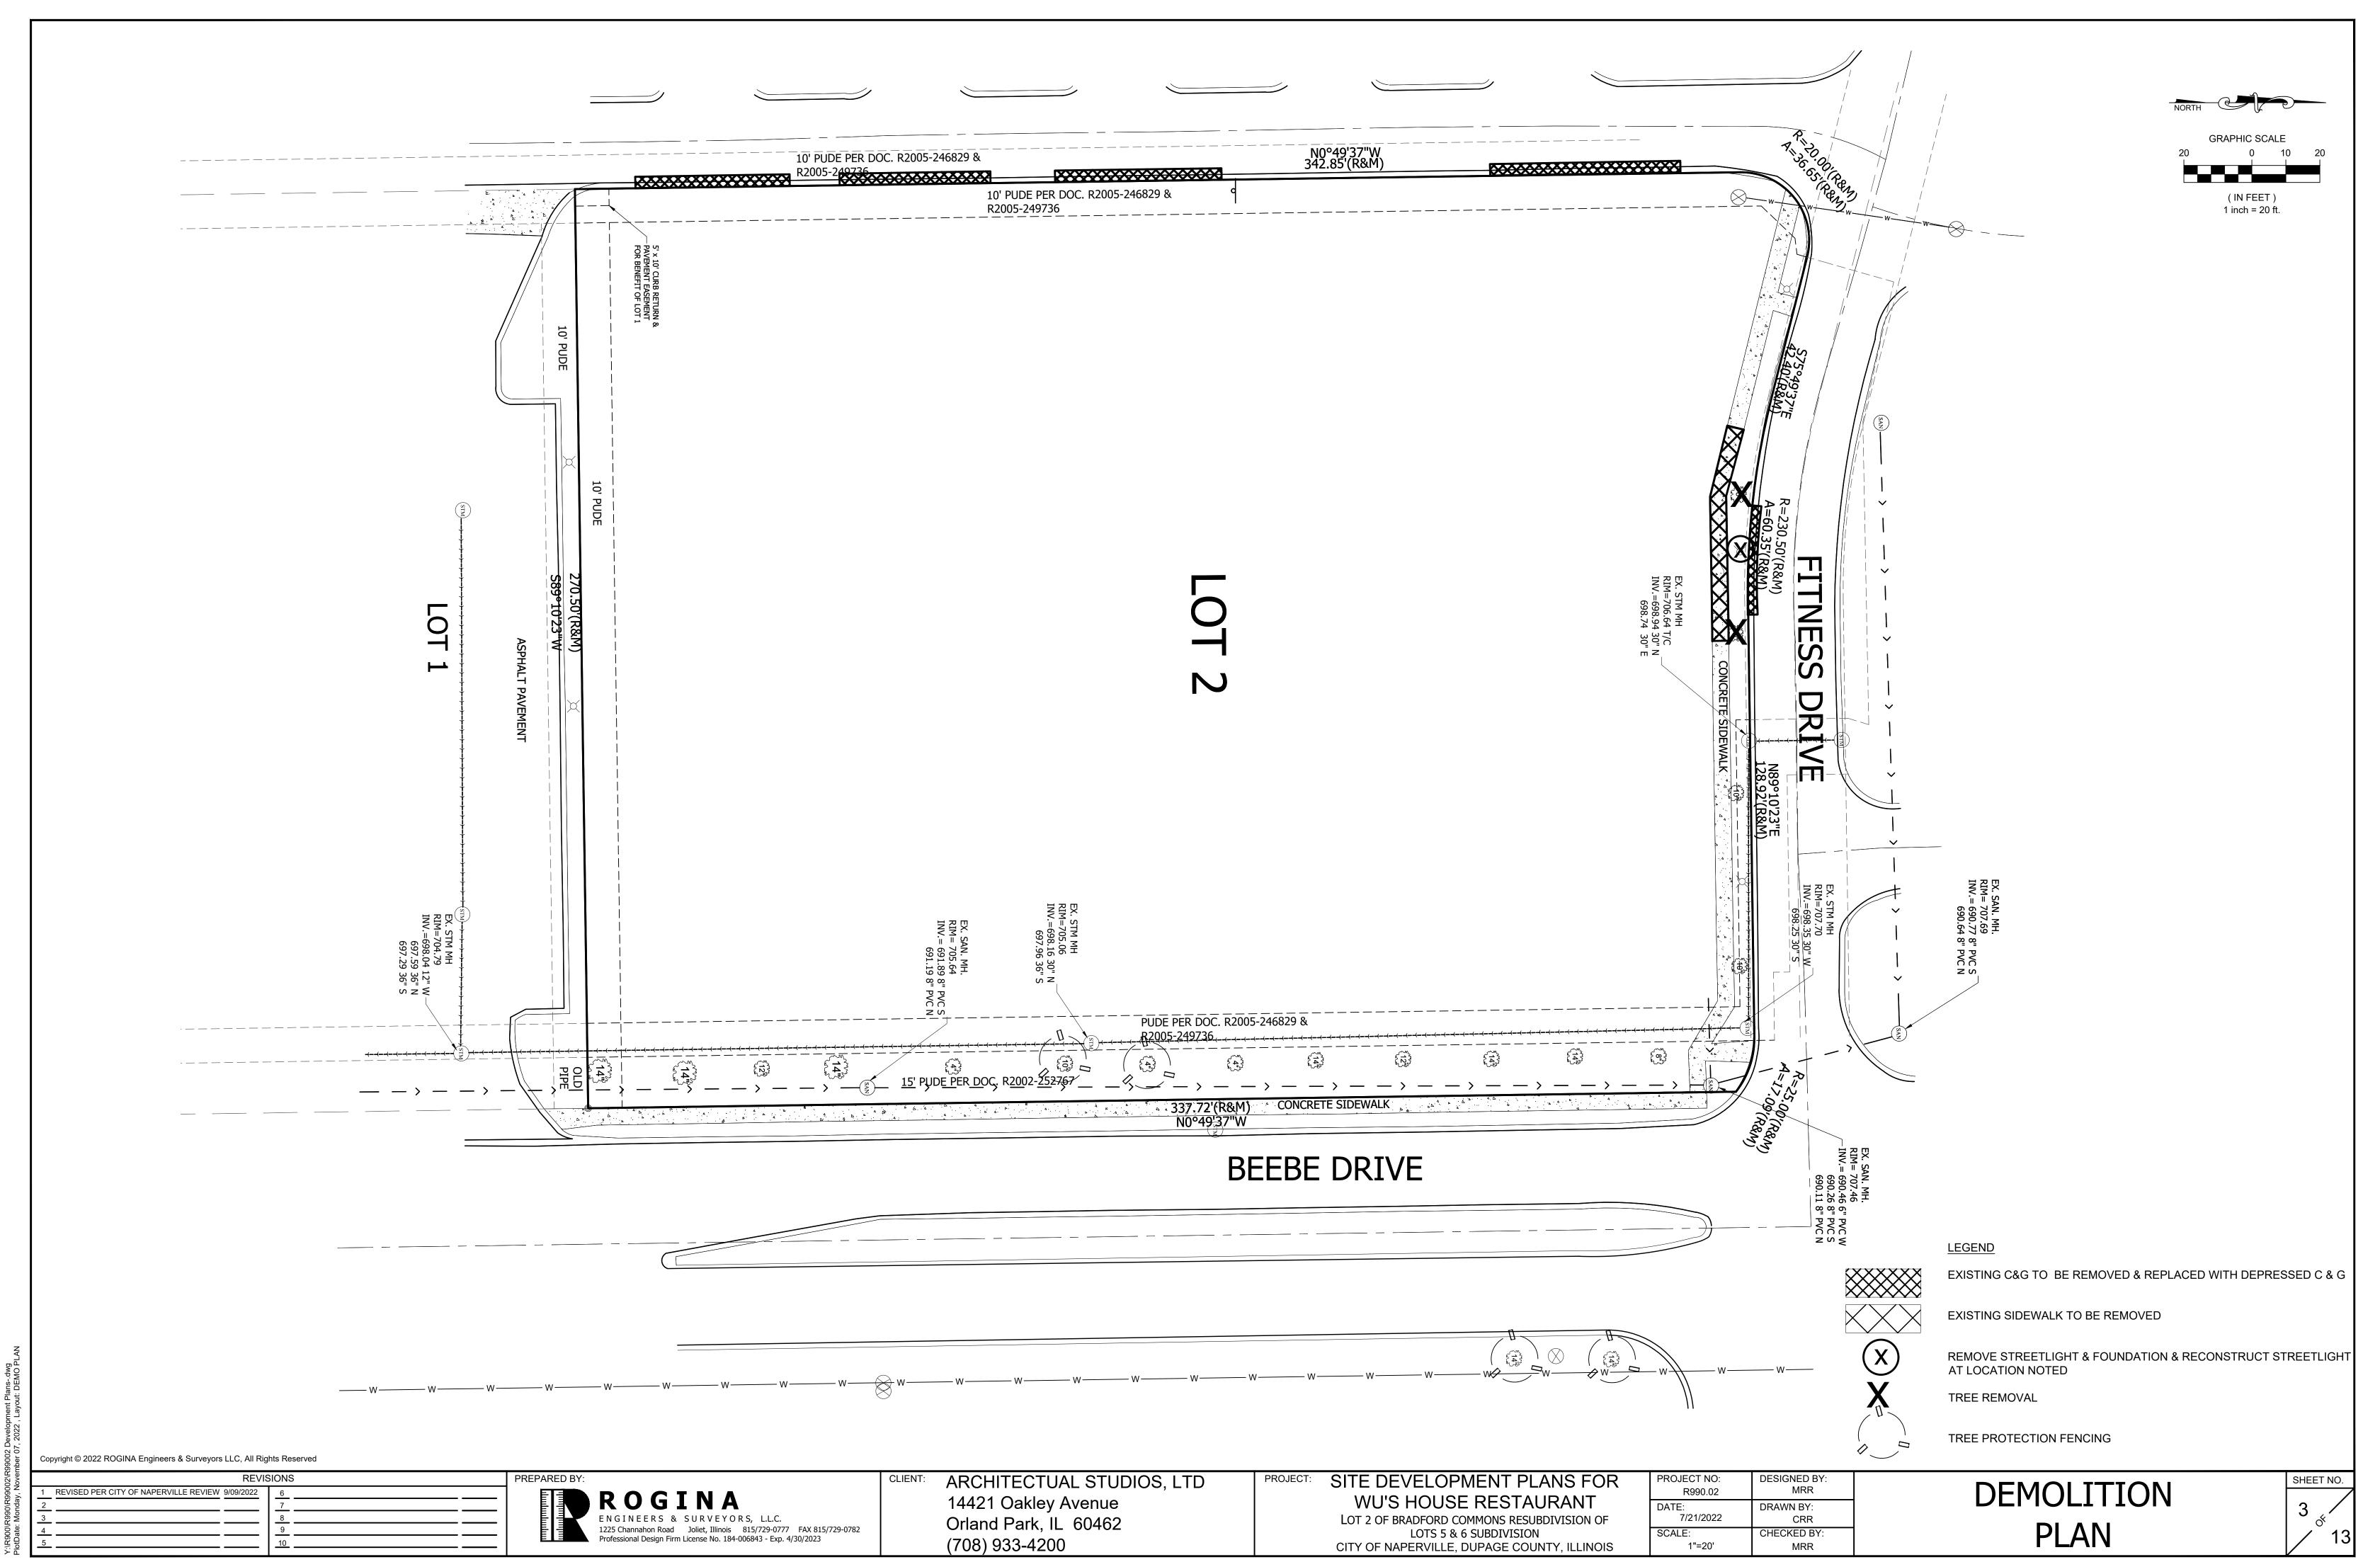


F.E PA

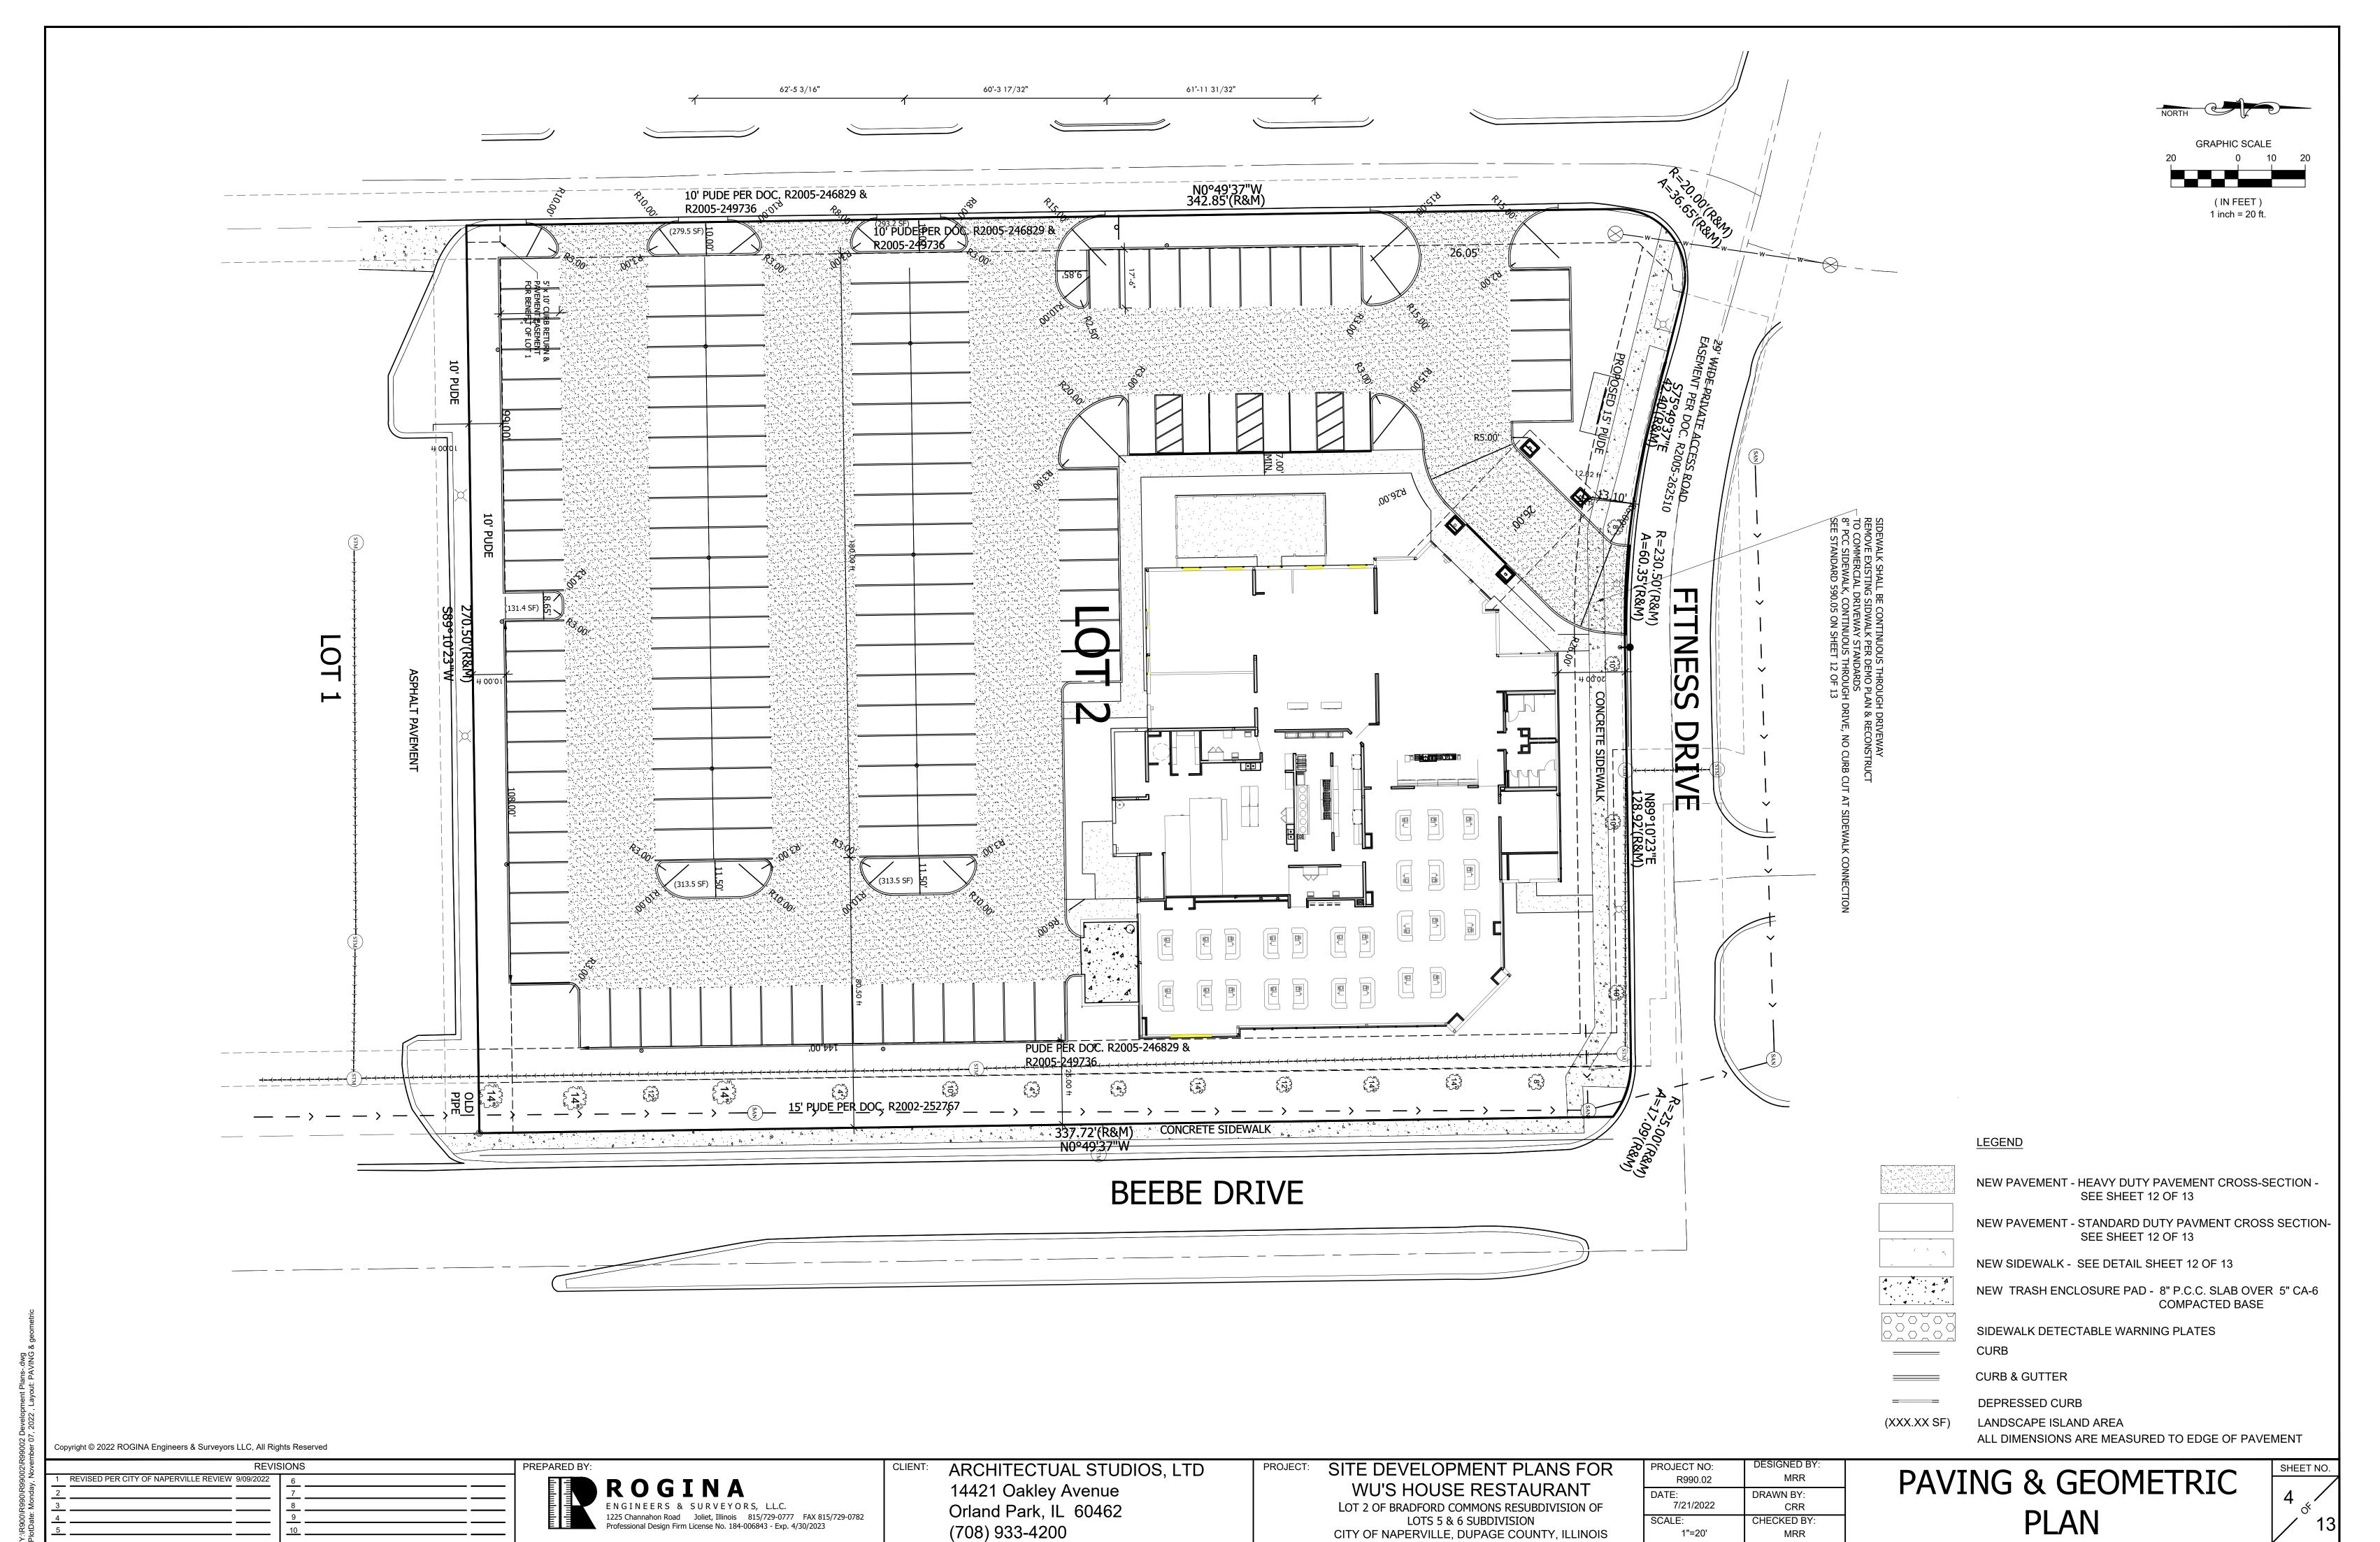


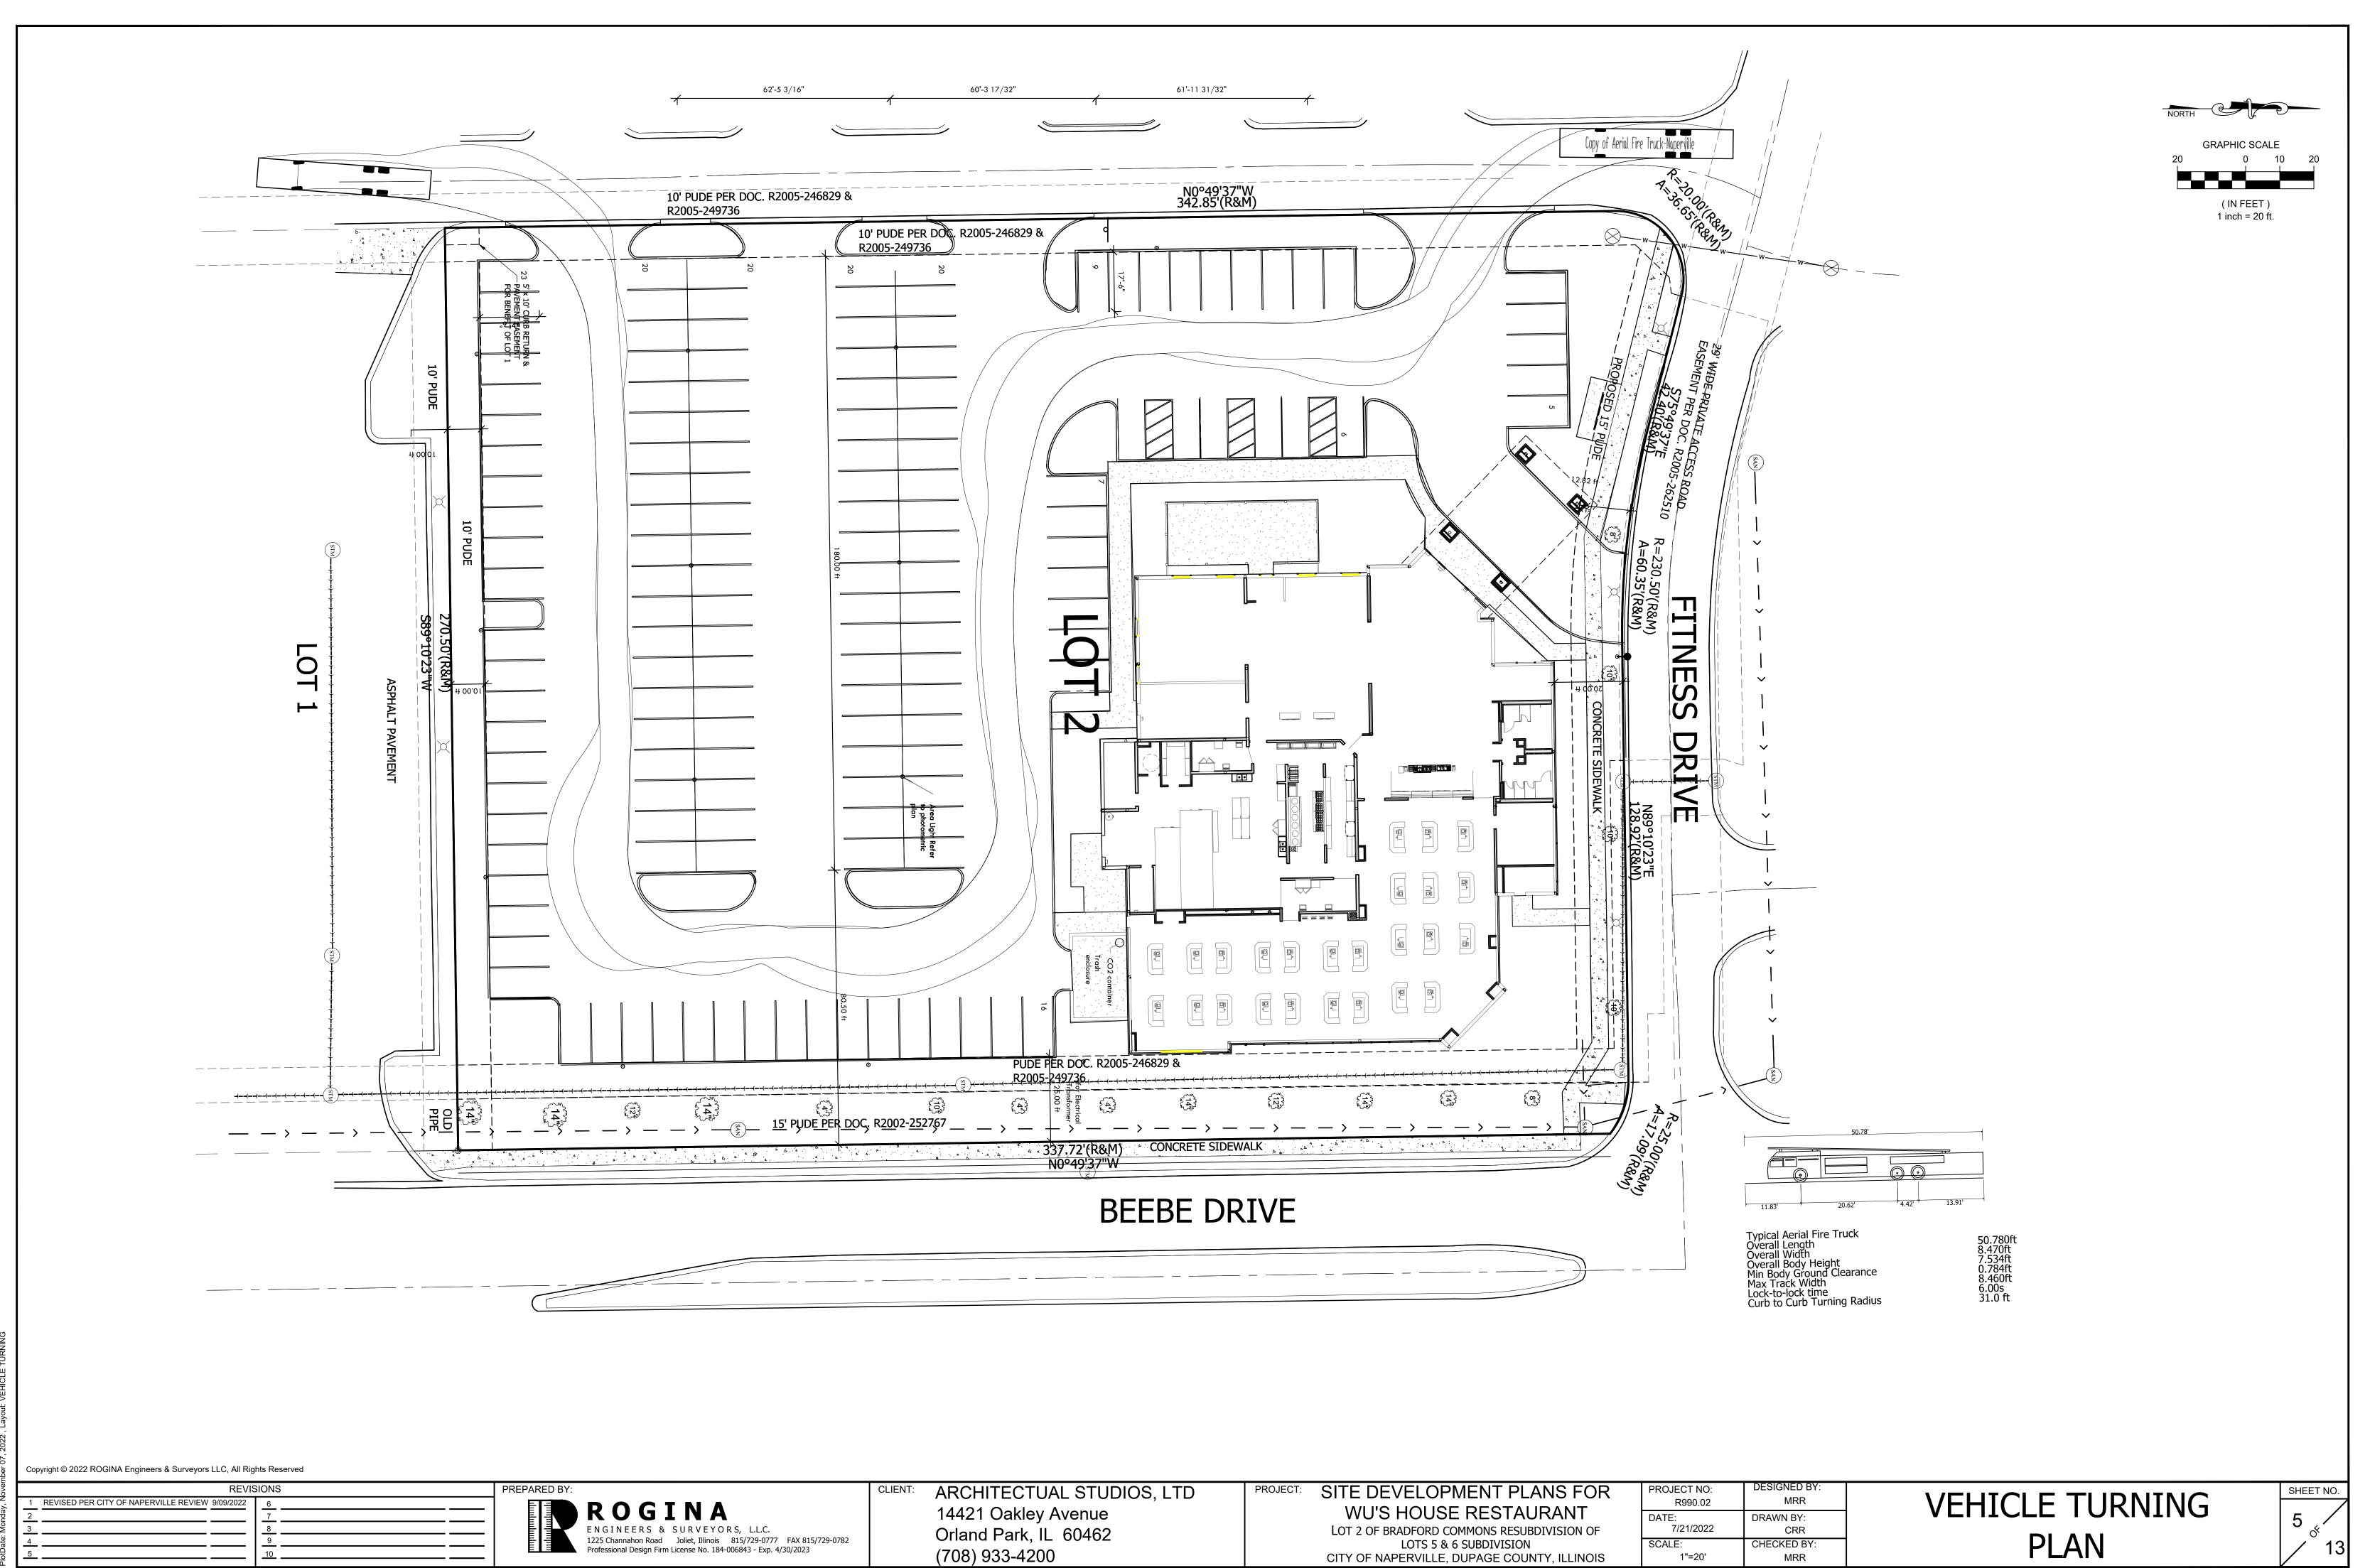

F.E PA

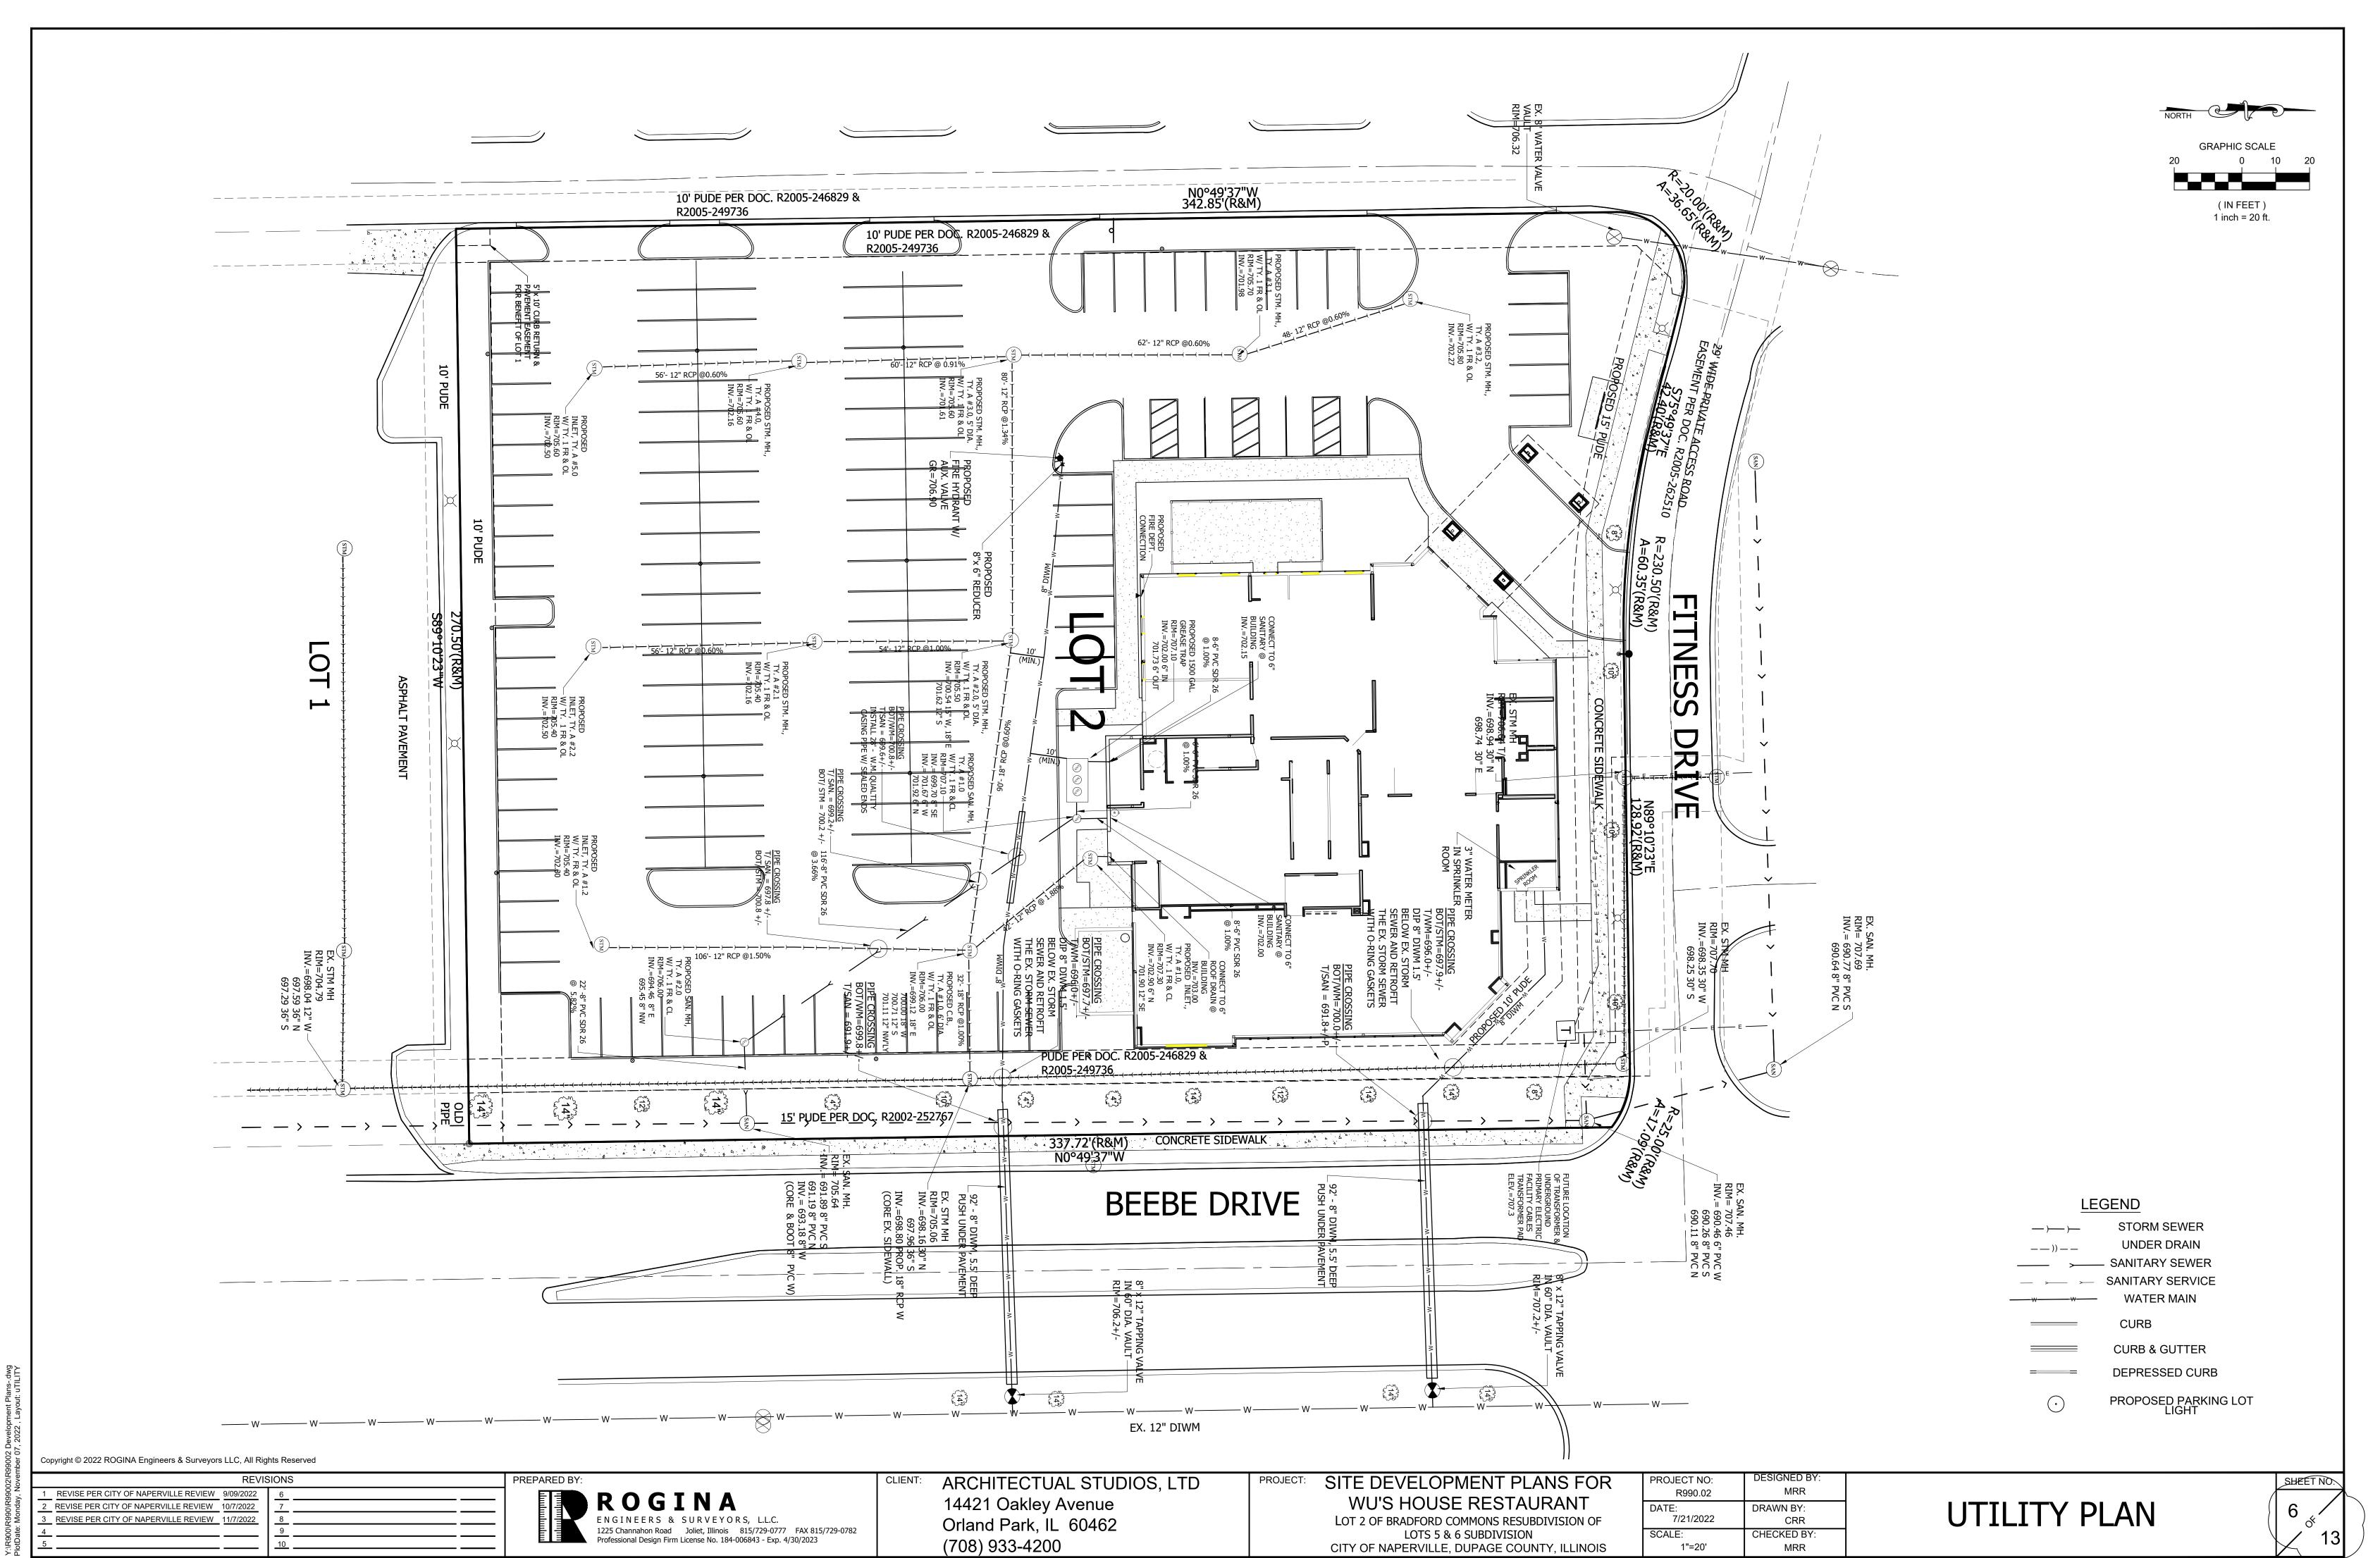

F. P/

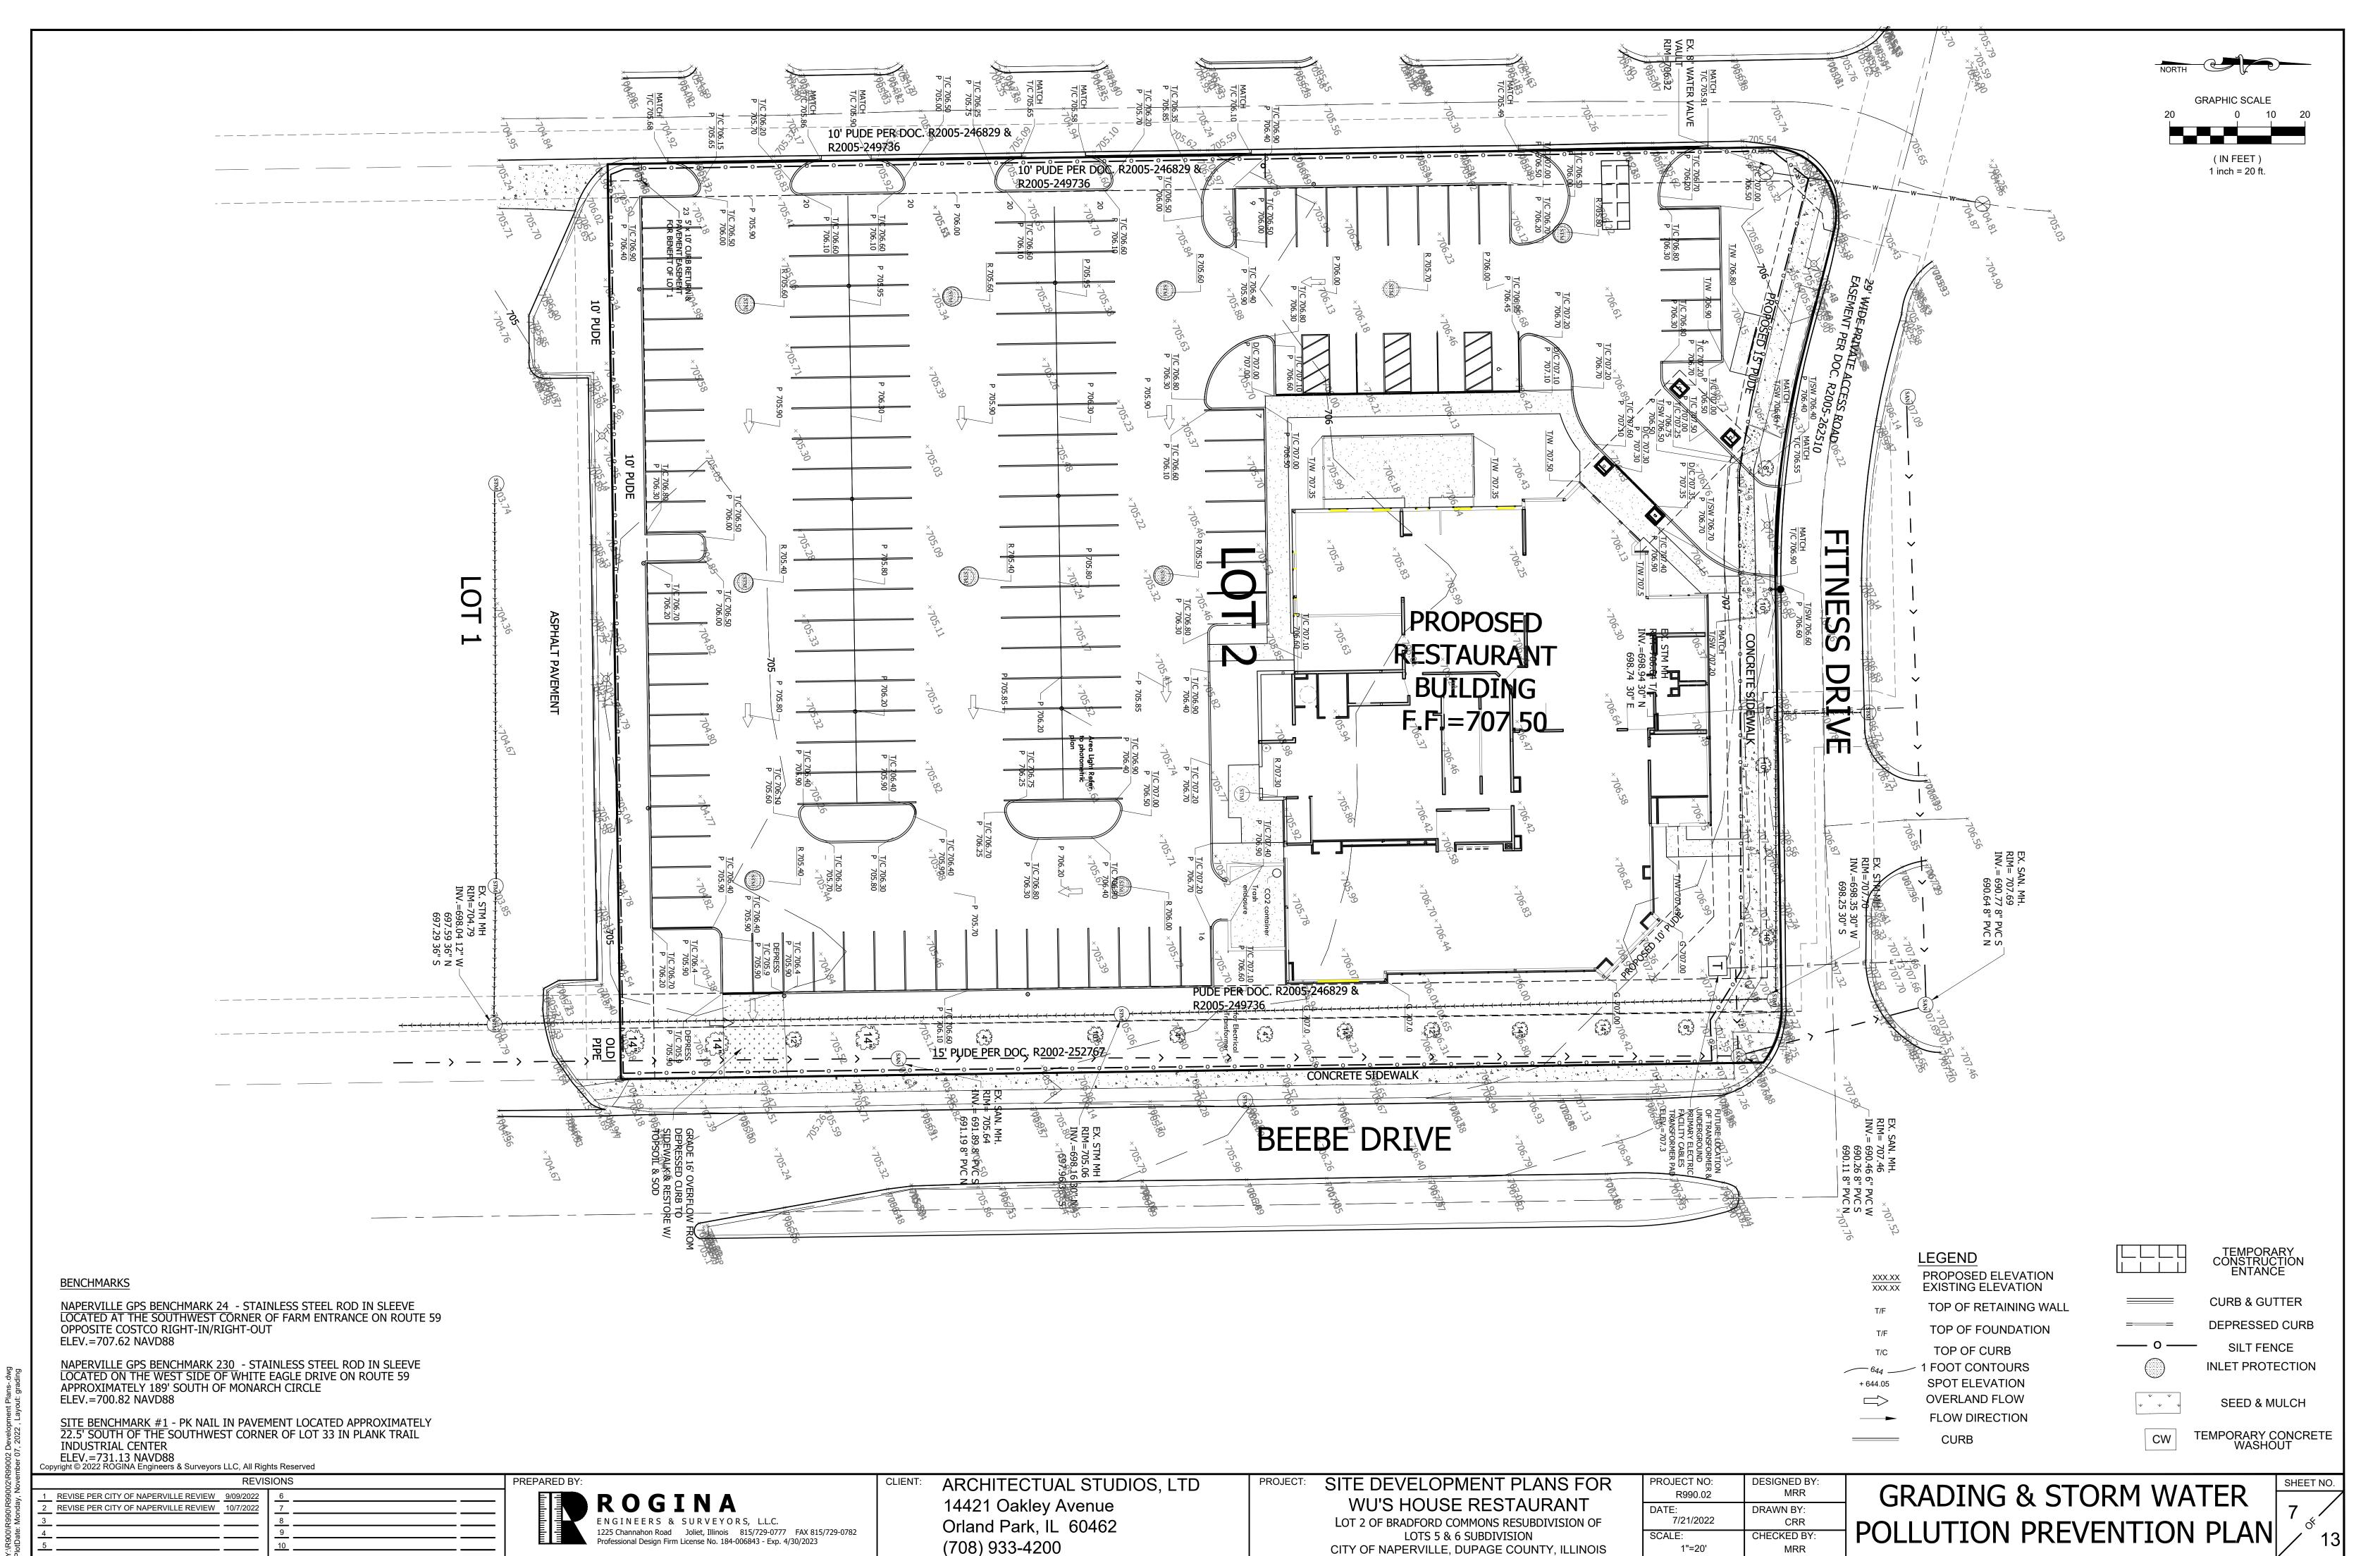

F.I

SOIL EROSION CONTROL SPECIFICATIONS:

1 FROSION CONTROL MEASURES AS INDICATED IN THE FROSION CONTROL PLAN, AND AS DIRECTED BY THE ENGINEER SHALL BE INSTALLED ON THE PROJECT SITE PRIOR TO BEGINNING ANY CONSTRUCTION ACTIVITIES WHICH WILL POTENTIALLY CREATE ERODING CONDITIONS. EROSION CONTROL DEVICES SHALL BE IN PLACE AND APPROVED BY THE ENGINEER AS TO PROPER PLACEMENT AND INSTALLATION PRIOR TO BEGINNING OTHER WORK. EROSION CONTROL PROTECTION SHALL BE INSTALLED BY THE CONTRACTOR AND APPROVED BY THE ENGINEER PRIOR TO BEGINNING CONSTRUCTION ACTIVITIES. THE ILLINOIS URBAN SOIL AND SEDIMENTATION CONTROL MANUAL SHOULD SHOW PRECEDENCE

2. PRIOR TO COMMENCEMENT OF GRADING ACTIVITIES, THE SOIL EROSION CONTROL FENCING AND THE STABILIZED CONSTRUCTION ENTRANCE AS INDICATED HEREON SHALL BE INSTALLED TO PROTECT SURROUNDING PROPERTIES.

3. QUALIFIED PERSONNEL SHALL INSPECT DISTURBED AREAS OF THE CONSTRUCTION SITE WHICH HAVE NOT BEEN FINALLYSTABILIZED, STRUCTURAL CONTROL MEASURES, AND LOCATIONS WHERE VEHICLES AND EQUIPMENT ENTER AND EXIT THE SITE, SUCH INSPECTIONS SHALL BE CONDUCTED AT LEAST ONCE EVERY SEVEN (7) CALENDAR DAYS AND WITHIN 24 HOURS OF THE END OF A STORM EVENT THAT IS 0.5 INCHES OR GREATER OF RAINFALL OR EQUIVALENT SNOWFALL

4. THE PROPOSED STORM WATER DETENTION AREA IS THE MAJOR AREA OF INUNDATION WITHIN THE SITE AND SHALL BE GRADED IN SUCH A MANNER THAT IT WILL FUNCTION AS A SEDIMENTATION BASIN DURING THE SITE GRADING OPERATIONS.

5. STREETS ADJACENT TO THE SITE SHALL BE KEPT FREE OF DIRT, MUD AND DEBRIS. 6. NO SEDIMENT SHALL BE ALLOWED TO ENTER THE STORM SEWER SYSTEM.

7. IN ACCORDANCE WITH THESE CONSTRUCTION PLANS, TEMPORARY STAKED HAY OR STRAW BALES SHALL BE INSTALLED AND MAINTAINED AROUND STORM SEWER STRUCTURES, IN SWALE AREAS UNTIL VEGETATION IS ESTABLISHED AND/OR CONSTRUCTION IS COMPLETE.

8. TOPSOIL STOCKPILES SHALL BE LOCATED TO AVOID EROSION OF SAID STOCKPILE ONTO OFFSITE AREAS, I.E. THE STOCKPILE SHALL BE LOCATED SO THAT AN ONSITE DRAINAGE SWALE IS LOCATED BETWEEN THE STOCKPILE AND THE DOWNSTREAM OFFSITE PROPERTY. IF A STOCKPILE IS TO REMAIN IN PLACE FOR MORE THAN SIX MONTHS, IT IS REQUIRED THAT THE STOCKPILE BE SEEDED AFTER 14 DAYS OF INACTIVITY SO AS TO MINIMIZE SOIL EROSION BY BOTH WIND AND WATER.

9. WHEN STORM WATER IS TO BE ROUTED THROUGH PROPOSED DETENTION BASINS IN ORDER TO ALLOW SETTLEMENT OF SILT AND DEBRIS, THE BASINS ARE TO BE CONSTRUCTED IMMEDIATELY UPON COMMENCEMENT OF THE PROJECT. BASINS WILL BE PROPERLY OVER-EXCAVATED SO AS TO PROVIDE SUFFICIENT VOLUME FOR DEBRIS AND SETTLEMENT.

10. ALL STORM SEWER, CATCH BASINS, SUMPS AND/OR RETENTION BASINS PROVIDED WITHIN THIS PROJECT ARE TO BE CLEANED AT THE END OF CONSTRUCTION OF THE PROJECT AND PRIOR TO FINAL ACCEPTANCE. CLEANING MAY ALSO BE REQUIRED DURING THE COURSE OF THE CONSTRUCTION OF THE PROJECT IF IT IS DETERMINED THAT THE SILT AND DEBRIS TRAPS ARE NOT PROPERLY FUNCTIONING AND THEIR PERFORMANCE

11. A STABILIZED CONSTRUCTION ENTRANCE(S) FOR MUD AND DUST CONTROL SHALL BE ESTABLISHED AT THE ONSET OF CONSTRUCTION ACTIVITY AND SHALL BE MAINTAINED THROUGHOUT THE COURSE OF THE PROJECT. THE CONSTRUCTION ENTRANCE(S) SHALL BE LOCATED GENERALLY WHERE SHOWN ON THE PLAN, AND AT ANY OTHER POINTS WHERE CONSTRUCTION TRAFFIC FREQUENTLY LEAVES THE PUBLIC ROADWAY TO ENTER THE SITE. THE STABILIZED CONSTRUCTION ENTRANCE(S) SHALL BE A MINIMUM OF 30 FEET WIDE, 50 FEET LONG, AND SHALL CONSIST OF A 6" THICK MINIMUM LAYER OF 2" ANGULAR CRUSHED AGGREGATE COMPACTED IN PLACE, UNDERLAIN WITH A GEOTEXTILE FILTER FABRIC.

12. UNLESS SOIL EROSION CONTROL ITEMS ARE SPECIFICALLY REFERRED TO AS BID ITEMS (SUCH AS TOPSOIL RESPREAD, SEEDING, ETC.), THEY ARE TO BE CONSIDERED AS INCIDENTAL TO THE COST OF THE CONTRACT.

13. UPON COMPLETION OF TOPSOIL RESPREAD OPERATIONS, ALL DISTURBED AREAS SHALL BE SEEDED, SODDED OR LANDSCAPED AS NOTED ON THE PLAN.

14. SEEDING AND MULCHING SHALL BE IN ACCORDANCE WITH SECTIONS 642 AND 643 OF THE STANDARD SPECIFICATIONS. SEED MIXTURE SHALL BE CLASS 1.

15. SODDING SHALL BE IN ACCORDANCE WITH SECTION 644 OF THE I.D.O.T. "STANDARD SPECIFICATIONS".

16. SEQUENCE FOR SOIL EROSION CONTROL ITEMS

EACH RESPECTIVE CONTRACTOR IS RESPONSIBLE FOR THE INSTALLATION, MAINTENANCE AND ANY NECESSARY CORRECTIVE ACTION ASSOCIATED WITH THE EROSION CONTROI MEASURES SO DESIGNATED FOR THAT CONTRACTOR. THE FOLLOWING ITEMS ARE TO BE PROVIDED BY THE DESIGNATED CONTRACTOR AT THE TIME AND IN THE GENERAL SEQUENCE BELOW

I. MASS GRADING/EARTHWORK CONTRACTOR

A.PROVIDE CONSTRUCTION ENTRANCE AND EROSION CONTROL FABRIC PRIOR TO THE START OF CONSTRUCTION.

B.PROVIDE DIVERSION SWALES AROUND SITE PERIMETER AS NECESSARY TO PREVENT/INTERCEPT STORM WATER RUNOFF TO OFFSITE AREAS. AS PART OF INITIAL MASS GRADE IMPROVEMENTS.


C.PROVIDE DIVERSION DITCH/TOPSOIL BERM IN ACCORDANCE WITH TEMPORARY TOPSOIL STOCKPILE DETAIL FOR ALL STOCKPILES PRIOR TO PLACEMENT OF MATERIAL IN SAID STOCKPILE.


II. UNDERGROUND CONTRACTOR


A.PROVIDE STRAW BALES, SILTATION/DEBRIS COLLECTION "CHANNEL", SYNTHETIC FILTER FABRIC, ETC. AROUND ALL YARD/DETENTION BASIN INLETS IMMEDIATELY UPON INSTALLATION OF SAID


B.PROVIDE CLEANING OF STORM SEWER SYSTEM, CATCH BASINS AND STORM SEWER STRUCTURES IN ACCORDANCE WITH THESE SOIL EROSION CONTROL SPECIFICATIONS.


C.PROVIDE FILTER FABRIC AT ALL CURB INLETS DURING CONSTRUCTION. FABRIC TO BE PLACED BETWEEN GRATE AND CAST IRON FRAME TO ALLOW MAINTENANCE OR REPLACEMENT OF FABRIC BY REMOVING GRATE WITH FRAME TO REMAIN IN PLACE. SAID FILTER FABRIC TO BE MAINTAINED UNTIL ALL "UPSTREAM" AREAS TO A RESPECTIVE INLET HAVE BEEN COMPLETED THROUGH ESTABLISHMENT OF A GRASS TURF.

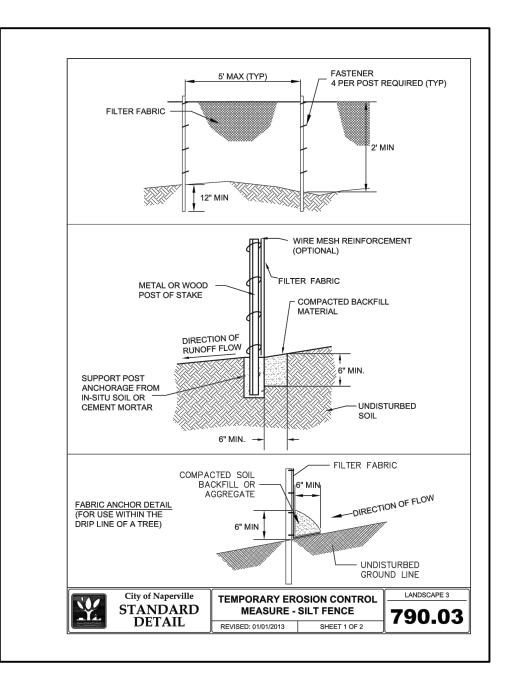


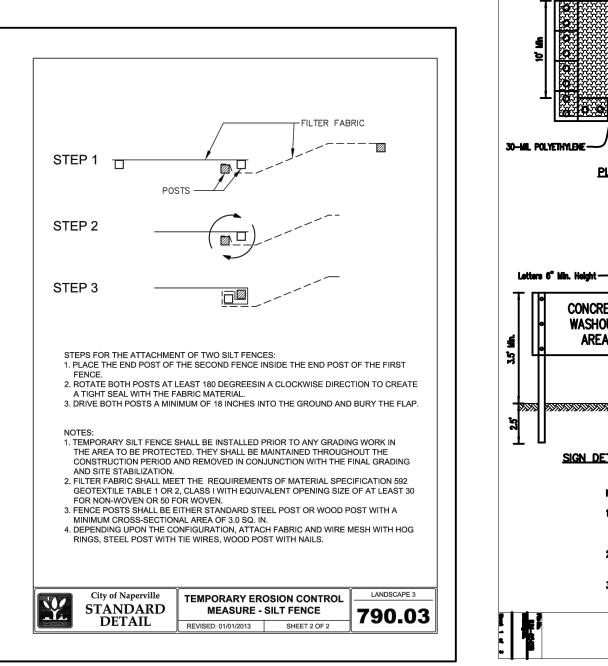

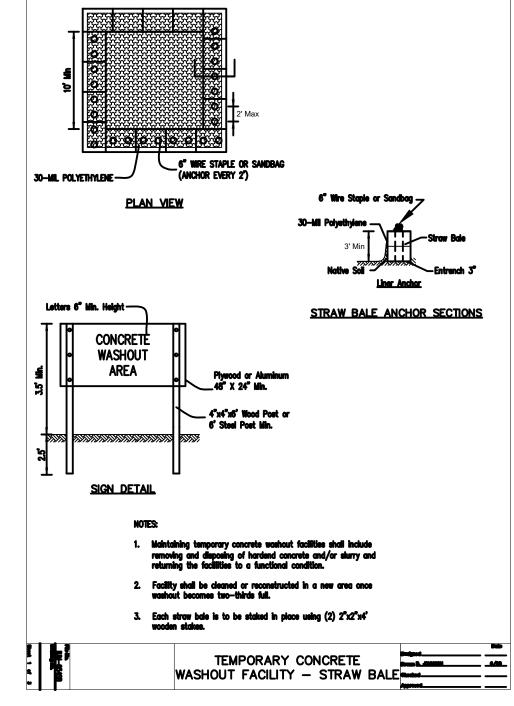

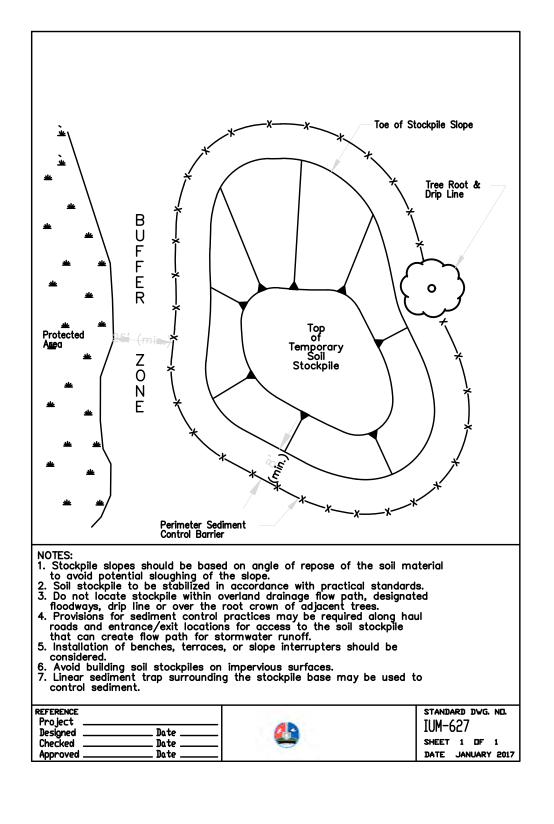

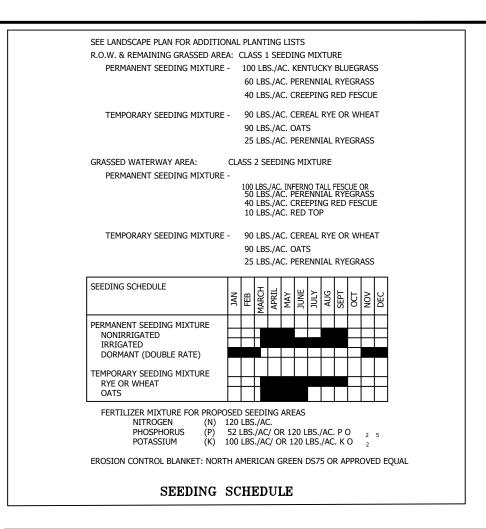

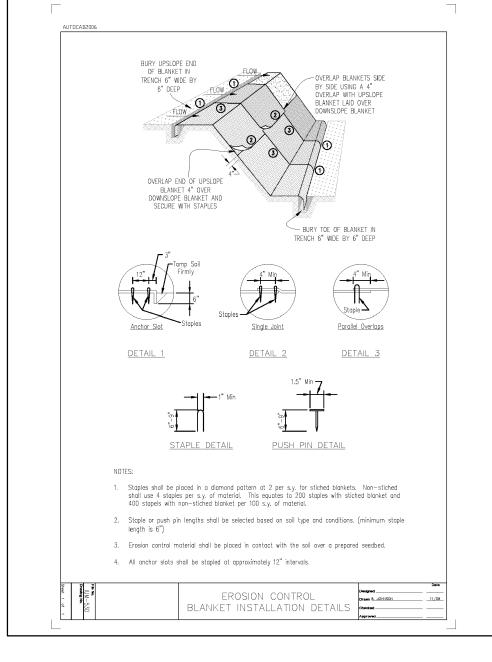



"I CERTIFY UNDER PENALTY OF LAW THAT THIS DOCUMENT AND ALL ATTACHMENTS WERE PREPARED UNDER MY DIRECTION AND SUPERVISION IN ACCORDANCE WITH A SYSTEM DESIGNED TO ASSURE THAT QUALIFIED PERSONNEL PROPERLY GATHER AND EVALUATE THE INFORMATION SUBMITTED. BASED ON MY INQUIRY OF THE PERSON OR PERSONS WHO MANAGE THIS SYSTEM, OR THOSE PERSONS DIRECTLY RESPONSIBLE FOR GATHERING THE INFORMATION, THE INFORMATION SUBMITTED IS, TO THE BEST OF MY KNOWLEDGE AND BELIEF, TRUE, ACCURATE, AND COMPLETE. I AM AWARE THAT THERE ARE SIGNIFICANT PENALTIES FOR SUBMITTING FALSE INFORMATION, INCLUDING THE POSSIBILITY OF FINE AND IMPRISONMENT. IN ADDITION, I CERTIFY THAT THE PROVISIONS OF THE PERMIT, INCLUDING THE DEVELOPMENT AND IMPLEMENTATION OF A STORM WATER POLLUTION PREVENTION PLAN AND A MONITORING PROGRAM PLAN, WILL BE COMPLIED WITH."

OWNER SIGNATURE: DATE:

CONTRACTOR CERTIFICATION


"I CERTIFY UNDER PENALTY OF LAW THAT I UNDERSTAND THE TERMS AND CONDITIONS OF THE GENERAL NATIONAL POLLUTANT DISCHARGE ELIMINATION SYSTEM (NPDES) PERMIT (ILR10) THAT AUTHORIZES THE STORM WATER DISCHARGES ASSOCIATED WITH INDUSTRIAL ACTIVITY FROM THE CONSTRUCTION SITE IDENTIFIED AS PART OF THIS CERTIFICATION."

CONTRACTOR SIGNATURE:

NPDES PERMIT INSPECTOR CERTIFICATION


"I CERTIFY UNDER PENALTY OF LAW THAT I UNDERSTAND THE TERMS AND CONDITIONS OF THE GENERAL NATIONAL POLLUTANT DISCHARGE ELIMINATION SYSTEM (NPDES) PERMIT (ILR10) THAT AUTHORIZES THE STORM WATER DISCHARGES ASSOCIATED WITH INDUSTRIAL ACTIVITY FROM THE CONSTRUCTION SITE IDENTIFIED AS PART OF THIS CERTIFICATION.'


NPDES PERMIT INSPECTOR SIGNATURE:

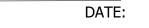

DATE:

INLET PROTECTION - PAVED AREAS DROP-IN PROTECTION SEDIMENT—BAG/FILTER STRUCTURE IUM-561D SHEET 1 OF 1

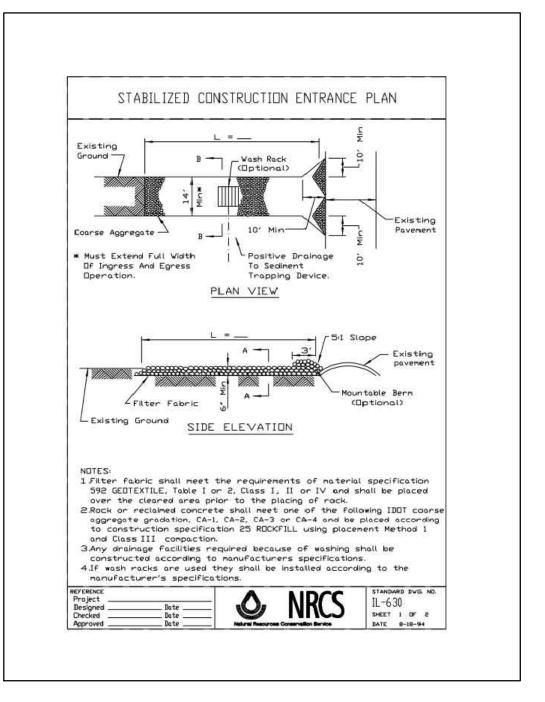

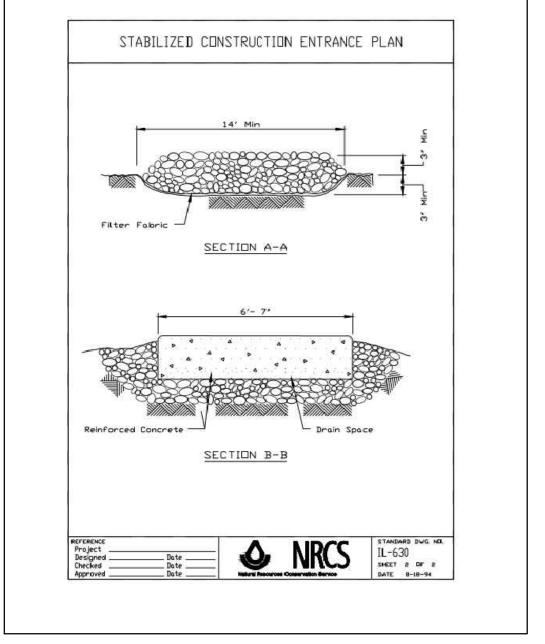

Know what's **below.** Call before you dig. CALL TWO (2) BUSINESS DAYS BEFORE YOU DIG (EXCLUDING SAT., SUN. & HOL.) CALL 811 or 1-800-892-0123 REVISIONS

Copyright © 2022 ROGINA Engineers & Surveyors LLC, All Rights Reserved

PREPARED BY: ROGINA ENGINEERS & SURVEYORS, L.L.C. Professional Design Firm License No. 184-006843 - Exp. 4/30/2023

ARCHITECTUAL STUDIOS, LTD 14421 Oakley Avenue Orland Park, IL 60462 (708) 933-4200


SITE DEVELOPMENT PLANS FOR WU'S HOUSE RESTAURANT LOT 2 OF BRADFORD COMMONS RESUBDIVISION OF LOTS 5 & 6 SUBDIVISION


CITY OF NAPERVILLE, DUPAGE COUNTY, ILLINOIS

PROJECT NO: **DESIGNED BY:** R990.02 DRAWN BY: DATE: 7/21/2022 CRR SCALE: CHECKED BY N.T.S.

STORM WATER POLLUTION PREVENTION PLAN SPECIFICATIONS & DETAILS

SHEET NO.

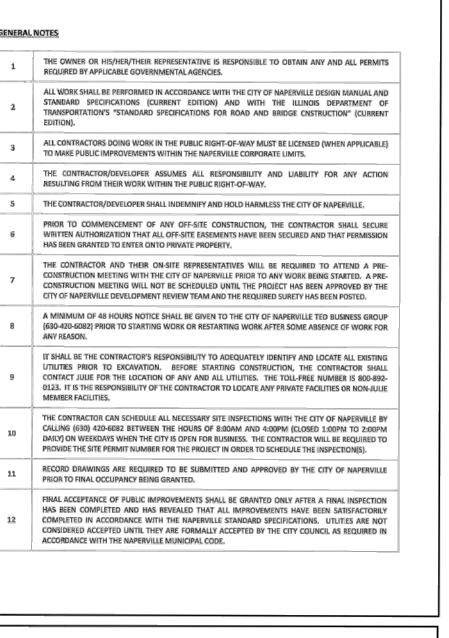

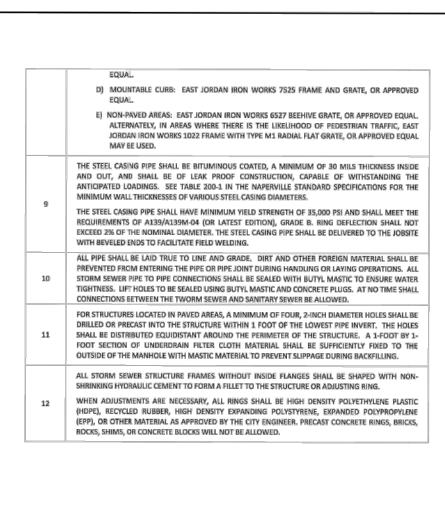

1	ALL DEVELOPERS AND CONTRACTORS SHALL PROVIDE SUITABLE TRAFFIC CONTROL FOR THEIR CONSTRUCTION ACTIVITIES IN ACCORDANCE WITH PART 6 OF THE MANUAL ON UNIFORM TRAFFIC CONTROL DEVICES (MUTCD), LATEST EDITION. TRAFFIC CONTROL MUST BE PROVIDED FOR ANY ACTIVITY THAT IMPACTS TRAFFIC FLOW. THIS INCLUDES, BUT IS NOT LIMITED TO, ROAD CLOSURES REQUIRING DETOURS, DAILY LANE CLOSURES, LONG TERM LANE CLOSURES, NARROW LANES, AND CONSTRUCTION VEHICLES ENTERING AND EXTINIST THE PUBLIC ROADWAY. ALL TRAFFIC CONTROL SETUPS MAY BE INSPECTED BY THE CITY OF NAPERVILLE TO ENSURE THAT THEY ARE PROVIDING POSITIVE GUIDANCE TO MOTORISTS AND ARE NOT IN THEMSELVES PRESENTING A HAZARDOUS SITUATION. A REPRESENTATIVE OF THE DEVELOPER OR CONTRACTOR MUST PROVIDE PHONE NUMBERS AT WHICH THEY CAN BE REACHED 24 HOURS A DAY AND ON WEEKENDS SO THAT THEY CAN MAINTAIN TRAFFIC CONTROL DEVICES.
2	PEDESTRIANS MUST BE PROVIDED WITH A SAFE ALTERNATE ROUTE IF PEDESTRIAN FACILITIES ARE TO BE CLOSED AS A RESULT OF CONSTRUCTION ACTIVITIES. GUIDANCE MUST BE PROVIDED TO PEDESTRIANS SO THAT THEY MAY AVOID THE WORK ZONE. SAID PEDESTRIAN DETOUR PLAN (WITH SIGNAGE) IS TO BE REVIEWED AND ACCEPTED BY THE CITY IN WRITING, PRIOR TO THE COMMENCEMENT OF THE WORK.
3	THE CONTRACTOR SHALL EMPLOY THE APPROPRIATE METHODS OF TRAFFIC CONTROL IN ACCORDANCE WITH THE PLANS, SPECIFICATIONS AND THE MANUAL ON UNIFORM TRAFFIC CONTROL DEVICES, SUCH THAT THE SAFETY OF VEHICLES, AND PEDESTRIANS IS PRESERVED AT ALL TIMES. THE ERECTION AND MAINTENANCE OF THE TRAFFIC CONTROL DEVICES SHALL BE TO THE SATISFACTION OF THE AGENCY OF JURISDICTION AND THE CITY ENGINEER.
4	ANY TEMPORARY OPEN HOLES SHOULD BE BARRICADED AND PROTECTED IN ACCORDANCE WITH APPLICABLE STANDARDS.

1	THE CONTRACTOR SHALL MAINTAIN PROPER DRAINAGE AT ALL TIMES DURING THE COURSE OF CONSTRUCTION AND PREVENT STORM WATER FROM RUNNING INTO OR STANDING IN EXCAVATED AREAS.
2	DURING EXTENDED DRY PERIODS, THE CONSTRUCTION AREA(S) MAY NEED TO BE WATERED DOWN TO PREVENT THE BLOWING OF SOIL FROM THE SITE.
3	DURING CONSTRUCTION, A STABILIZED CONSTRUCTION ENTRANCE SHALL BE UTILIZED TO MINIMIZE THE TRACKING OF DIRT ONTO THE PUBLIC STREETS. IT IS THE CONTRACTOR'S RESPONSIBILITY TO KEEP PUBLIC STREET PAVEMENT CLEAN OF DIRT AND DEBRIS. ANY DIRT THAT IS TRACKED ONTO THE PUBLIC STREET SHALL BE REMOVED THE SAME DAY. IF THE AMOUNT TRACKED ON THE PUBLIC STREET IS
	EXCESSIVE, CLEANING MAY BE REQUIRED MORE FREQUENTLY.
Erosion 1	EXCESSIVE, CLEANING MAY BE REQUIRED MORE FREQUENTLY. Control and Drainage Notes (Project Specific) ALL EROSION CONTROL MEASURES SHALL BE PROPERLY INSTALLED, AS PERMITTED, PRIOR TO ANY LAND
	EXCESSIVE, CLEANING MAY BE REQUIRED MORE FREQUENTLY. Control and Drainage Notes (Project Specific)
1	EXCESSIVE, CLEANING MAY BE REQUIRED MORE FREQUENTLY. Control and Drainage Notes (Project Specific) ALL EROSION CONTROL MEASURES SHALL BE PROPERLY INSTALLED, AS PERMITTED, PRIOR TO ANY LAND DISTURBANCE ACTIVITIES. ALL EROSION CONTROL SHALL BE MAINTAINED UNTIL TURF IS ESTABLISHED. ACCEPTABLE PERIMETER EROSION CONTROL INCLUDES SILT FENCE, SILT WORM AND ANY OTHER
1 2	EXCESSIVE, CLEANING MAY BE REQUIRED MORE FREQUENTLY. Control and Drainage Notes (Project Specific) ALL EROSION CONTROL MEASURES SHALL BE PROPERLY INSTALLED, AS PERMITTED, PRIOR TO ANY LAND DISTURBANCE ACTIVITIES. ALL EROSION CONTROL SHALL BE MAINTAINED UNTIL TURF IS ESTABLISHED. ACCEPTABLE PERIMETER EROSION CONTROL INCLUDES SILT FENCE, SILT WORM AND ANY OTHER APPLICATION APPROVED BY THE CITY ENGINEER. ALL DEN GRATE STRUCTURES SHALL HAVE EROSION CONTROL PROTECTION IN ACCORDANCE WITH THE APPROVED EROSION CONTROL PLANS. INLET BASKETS ARE THE PREFERRED METHOD; STRAW BALES

	BE USED FOR RESIDENTIAL DRIVEWAY CROSSINGS ONLY WHEN A DITCH SECTION IS PRESENT. THE MINIMUM CULVERT SIZE IS 12" DIAMETER.
2	BEDDING, OTHER THAN CONCRETE EMBEDMENT, SHALL CONSIST OF GRAVEL, CRUSHED GRAVEL, OR CRUSHED STONE 1/4 INCH TO 1 INCH IN SIZE. AS A MINIMUM, THE MATERIAL SHALL CONFORM TO THE REQUIREMENTS OF IDOT STANDARD SPECIFICATIONS. THE GRADATION SHALL CONFORM TO GRADATION CA-7 OR CA-11 OF THE STANDARD SPECIFICATIONS.
3.	BACKFILL MATERIAL SHALL CONFORM TO THE REQUIREMENTS OF IDOT STANDARD SPECIFICATIONS. THE GRADATION SHALL CONFORM TO GRADATION CA-6 OF THE STANDARD SPECIFICATIONS. BACKFILL MATERIAL SHALL BE COMPACTED TO 95% STANDARD PROCTOR DENSITY.
4	JOINTS CONNECTING DISSIMILAR PIPE MATERIALS SHALL BE MADE WITH SEWER CLAMP NON-SHEAR TYPE COUPLINGS; CASCADE CSS, ROMAC LSS, FERRICO, INC. SHEAR RING, OR APPROVED EQUAL. WHEN AVAILABLE, A STANDARD JOINT WITH A TRANSITION GASKET MAY BE USED. THE NAME OF THE MANUFACTURER, CLASS, AND DATE OF ISSUE SHALL BE CLEARLY IDENTIFIED ON ALL SECTIONS OF PIPE. THE CONTRACTOR SHALL ALSO SUBMIT BILLS OF LADING, OR OTHER QUALITY ASSURANCE DOCUMENTATION WHEN REQUESTED BY THE CITY ENGINEER. ALL NUTS AND BOLTS FOR COUPLINGS SHALL BE STAINLESS STEEL.
5	MANHOLES FOR STORM SEWERS SHALL HAVE A MINIMUM INSIDE DIAMETER OF 48 INCHES AND SHALL BE CONSTRUCTED OF PRECAST CONCRETE UNITS IN ACCORDANCE WITH ASTM C478-05 (OR LATEST EDITION) AND SHALL CONFORM TO THE CITY OF NAPERVILLE STANDARD DETAIL. ALL MANHOLES SHALL BE WATER-TIGHT. ALL VISIBLE LEAKS SHALL BE SEALED IN A MANNER ACCEPTABLE TO THE CITY ENGINEER.
6	MANHOLES SHALL BE FURNISHED WITH A SELF-SEALING FRAME AND SOLID COVER (EAST JORDAN IRON WORKS 1022 WITH TYPE A SOLID COVER, OR APPROVED EQUAL) WITH THE WORD "STORM" IMPRINTED ON THE COVER IN RAISED LETTERS. ALL FRAMES AND LIDS SHALL MEET OR EXCEED ASSHTO H-20 LOADING SPECIFICATIONS. FRAMES SHALL BE SHOP PAINTED WITH ASPHALTIC BASE PAINT. BOTH THE MANHOLE FRAME AND COVER SHALL HAVE MACHINED HORIZONTAL AND VERTICAL BEARING SURFACES. INVERTED MANHOLE FRAMES ARE NOT ALLOWED. PICK HOLES SHALL NOT CREATE OPENINGS IN THE MANHOLE COVER.
7	MANHOLE STEPS ON MAXIMUM 16 INCH CENTER SHALL BE FURNISHED WITH EACH MANHOLE, SECURELY ANCHORED IN PLACE, TRUE TO VERTICAL ALIGNMENT, IN ACCORDANCE WITH THE NAPERVILLE STANDARD DETAILS. STEPS SHALL BE COPOLYMER POLYPROPYLENE REINFORCED WITH 1/2 INCH A615/A615N-05A (OR LATEST EDITION) GRADE 60 STEEL REINFORCEMENT, MEETING OR EXCEEDING ASTM C 478-05 (OR LATEST EDITION) AND OSHA STANDARDS.
S	CATCH BASINS AND INLETS SHALL HAVE A MINIMUM INSIDE DIAMETER OF 24 INCHES AND SHALL BE CONSTRUCTED OF PRECAST CONCRETE UNITS IN ACCORDANCE WITH ASTM C478-05 (OR LATEST EDITION) AND SHALL CONFORM TO THE CITY OF NAPERVILLE STANDARD DETAIL. ALL CATCH BASINS AND INLETS SHALL BE WATER-TIGHT AT ALL POINTS BELOW GRADE. ALL VISIBLE LEAKS SHALL BE SEALED IN A MANNER ACCEPTABLE TO THE CITY ENGINEER. CATCH BASINS AND INLETS SHALL BE FURNISHED WITH A FRAME AND GRATE BASED UPON THE LOCATION OF THE INSTALLATION AS LISTED BELOW. ALL FRAMES AND GRATES SHALL MEET OR EXCEED AASHTO H-20 LOADING SPECIFICATIONS. FRAMES SHALL BE SHOP PAINTED WITH ASPHALTIC BASE PAINT.

A) PAVEMENT: EAST JORDAN IRON WORKS 1022 FRAME WITH TYPE M1 RADIAL FLAT GRATE, OR

B) BARRIER CURB AND GUTTER: EAST JORDAN IRON WORKS 7220 FRAME WITH TYPE M1 GRATE

C) DEPRESSED CURB: EAST JORDAN IRON WORKS 5120 FRAME AND GRATE, OR APPROVED

AND T1 CURB BOX, OR APPROVED EQUA

Copyright © 2022 ROGINA Engineers & Surveyors LLC, All Rights Reserved

1	THE DEVELOPER AND CONTRACTOR SHALL HAVE THE RESPONSIBILITY TO ADEQUATELY PROTECT THE PAVEMENT AND PROPERTY, CURB AND GUTTER AND OTHER RIGHT-OF-WAY IMPROVEMENTS, WHETHER NEWLY CONSTRUCTED OR EXISTING, FROM ANY AND ALL DAMAGE. SUFFICIENT MEANS SHALL BE EMPLOYED BY THE CONTRACTOR TO PROTECT AGAINST SUCH DAMAGE TO THE SATISFACTION OF THE CITY ENGINEER.
2	ANY NEW OR EXISTING IMPROVEMENTS THAT ARE DAMAGED SHALL BE REPAIRED OR REPLACED IN A MANNER THAT IS SATISFACTORY TO THE CITY ENGINEER.
3	THE CONTRACTOR AND/OR DEVELOPER SHALL SECURE ALL NECESSARY RIGHTS AND PERMISSIONS TO PERFORM ANY WORK ON PRIVATE PROPERTY NOT WITHIN THE OWNERSHIP RIGHTS OF THE DEVELOPER. THE DEVELOPER SHALL BEAR THE SOLE RESPONSIBILITY FOR DAMAGES THAT MAY OCCUR AS A RESULT OF WORK PERFORMED UNDER CONTRACTS THEY INITIATE.
4	THE CONTRACTOR/DEVELOPER WILL BE RESPONSIBLE FOR BRINGING PAVEMENTS (STREET, CURB AND GUTTER, SIDEWALK, DRIVEWAY) ON THE PROPERTY UP TO CITY STANDARDS INCLUDING ANY REPAIRS TO SUBSTANDARD PAVEMENTS THAT EXISTED PRIOR TO OR OCCURRED DURING CONSTRUCTION.
5	WHEREVER NEW WORK WILL MEET EXISTING CONDITIONS OTHER THAN LAWN AREAS, REGARDLESS OF WHETHER THE NEW OR EXISTING WORK IS ASPHALT OR CONCRETE, THE EXISTING ADJACENT SIDEWALK, DRIVEWAYS, PAVEMENT OR CURB SHALL BE NEATLY SAW CUT. THE SAW CUT SHALL BE IN A NEAT STRAIGHT LINE SUFFICIENTLY DEEP SO THAT IT RENDERS A SMOOTH VERTICAL FACE TO MATCH TO. IF THE CONTRACTOR IS NOT CAREFUL OR DOES NOT SAW DEEP ENOUGH AND THE CUT LINE BREAKS OUT OR CHIES TO AN IMPERFECT EDGE, THEN THE EXISTING SIDE MUST BE RE-CUT SQUARE AND DONE OVER UNTIL IT IS CORRECT.

REQUIRING DETOURS, DAILY LANE CLOSURES, LONG TERM LANE CLOSURES, NAND CONSTRUCTION VEHICLES ENTERING AND EXTING THE PUBLIC ROADWAY. ALL TRAFFIC CONTROL SET- UPS MAY BE INSPECTED BY THE CITY OF NAPERVILLE TO ENSURE THAT THEY ARE PROVIDING POSITIVE GUIDANCE TO MOTORISTS AND ARE NOT IN THEMSELVES PRESENTING A HAZARDOUS SITUATION. A REPRESENTATIVE OF THE DEVELOPER OR CONTRACTOR MUST PROVIDE PHONE NUMBERS AT WHICH THEY CAN BE REACHED 24 HOURS A DAY AND ON WEEKENDS SO THAT THEY CAN MAINTAIN TRAFFIC CONTROL DEVICES.	C # T #	COMPLETED BY THE CONTRACTO AND/OR RECONSTRUCTIONS NO TO THE CONTRACT. NO MORE TH ADJUSTING RINGS SHALL BE ALL GRADE.
PEDESTRIANS MUST BE PROVIDED WITH A SAFE ALTERNATE ROUTE IF PEDESTRIAN FACILITIES ARE TO BE CLOSED AS A RESULT OF CONSTRUCTION ACTIVITIES. GUIDANCE MUST BE PROVIDED TO PEDESTRIANS SO THAT THEY MAY AVOID THE WORK ZONE. SAID PEDESTRIAN DETOUR PLAN (WITH SIGNAGE) IS TO BE REVIEWED AND ACCEPTED BY THE CITY IN WRITING, PRIOR TO THE COMMENCEMENT OF THE WORK. THE CONTRACTOR SHALL EMPLOY THE APPROPRIATE METHODS OF TRAFFIC CONTROL IN ACCORDANCE WITH THE PLANS, SPECIFICATIONS AND THE MANUAL ON UNIFORM TRAFFIC CONTROL DEVICES, SUCH	E S S	TREES SHALL BE INSTALLED A MI ELECTRICAL FEEDERS, SANITARY SERVICES. TREES SHALL BE INS STRUCTURES AND APPURTENAN VALVE BOXES AND FIRE HYDRAN FRONT OF, 5' ON THE SIDES, AND
THAT THE SAFETY OF VEHICLES, AND PEDESTRIANS IS PRESERVED AT ALL TIMES. THE ERECTION AND MAINTENANCE OF THE TRAFFIC CONTROL DEVICES SHALL BE TO THE SATISFACTION OF THE AGENCY OF JURISDICTION AND THE CITY ENGINEER. ANY TEMPORARY OPEN HOLES SHOULD BE BARRICADED AND PROTECTED IN ACCORDANCE WITH	Ŋ	ALL RETAINER GLANDS WHEN RE JOINTS SHALL BE MECHANICAL JO MANUFACTURED BY EBBA IRON, I MANUFACTURED BY FORD METER
APPLICABLE STANDARDS.		CONFORMING TO ANSI/AWWA C1
		EXISTING DUCTILE IRON SYSTEMS SERIES 1100HD OR FORD SERIES
		EXISTING DUCTILE IRON SYSTEMS SPLIT MEGALUG) FOR MECHANIC
	P	DUCTILE IRON WATER MAIN TO BE POLYETHYLENE FILM POLYETHYL ANSI/AWWA C105/A21.5-05.
	C C L N A	A SET OF AS-BUILT RECORD DRAY COMPLETION OF IMPROVEMENTS OF ALL NEW AND EXISTING STRUG LINESTOP SLEEVES, WATER SERV MANHOLES, SANITARY SERVICE V ABANDONED WATER OR SANITAR THE SAME BENCHMARK DATUM A REFERENCED TO LOT LINES, BAC
	V N	ALL SANITARY SEWER PIPING SHA WITH JOINTS CONFORMING TO AS MEETING THE FOLLOWING REQUI MEETING ASTM D-2241. GREATER OR C905. MINIMUM PRESSURE RA
	N L	THE VALVES LESS THAN 16" SHAL NAME OR MARK OF THE MANUFAC LETTERS ON THE VALVE BODY. V MANUFACTURERS: AMERICAN, CL
	\ N A	STAINLESS STEEL NUTS, BOLTS/T ON ALL WATER MAIN INSTALLATION VALVES, FITTINGS, RESTRAINT, A MECHANICAL JOINTS AND RESTR ANTI-SEIZE COMPOUND SHALL BE COATING SHALL BE REPAIR WITH MOLYBDENUM-BASE LUBRICANT,
		THE CONTRACTOR SHALL ROTAT SATISFACTION OF THE DEPARTM
	N S N F L	WATER MAINS SHALL BE SUBJECT NAPERVILLE STANDARD SPECIFIC PERIOD OF 4 HOURS AND NOT VASHALL BE APPROVED BY THE CITTUDE THAN 200 PSI AND INCREMINATED THAN 201 THAT THE WATER INSECTION.
	E	THE CITY OF NAPERVILLE DPU-WA EXISTING WATER DISTRIBUTION S CONTRACTOR IS SOLELY RESPON SHALL INCLUDE PROVISIONS ARC
		FIRE HYDRANT SHOULD BE BAGG BEEN COMPLETED AND NEW WAT

		OOLL
INTRACTOR SHALL HAVE THE RESPONSIBILITY TO ADEQUATELY PROTECT THE RESPONSIBILITY TO ADEQUATELY PROTECT THE RESPONSIBILITY TO ADEQUATELY PROTECT THE RESPONSIBILITY AND ALL DAMAGE. SUFFICIENT MEANS SHALL BE LACTOR TO PROTECT AGAINST SUCH DAMAGE TO THE SATISFACTION OF THE	S.	S. ALL S FRAM FROM VACU FOR HG F
IPROVEMENTS THAT ARE DAMAGED SHALL BE REPAIRED OR REPLACED IN A CTORY TO THE CITY ENGINEER.		A) 48-I B) 60-I C) 72-I
R DEVELOPER SHALL SECURE ALL NECESSARY RIGHTS AND PERMISSIONS TO PRIVATE PROPERTY NOT WITHIN THE OWNERSHIP RIGHTS OF THE DEVELOPER. AR THE SOLE RESPONSIBILITY FOR DAMAGES THAT MAY OCCUR AS A RESULT DER CONTRACTS THEY INITIATE.		D) 84-I
OPER WILL BE RESPONSIBLE FOR BRINGING PAVEMENTS (STREET, CURB AND EWAY) ON THE PROPERTY UP TO CITY STANDARDS INCLUDING ANY REPAIRS TO IS THAT EXISTED PRIOR TO OR OCCURRED DURING CONSTRUCTION. WILL MEET EXISTING CONDITIONS OTHER THAN LAWN AREAS, REGARDLESS OF ISSUING WORK IS ASPHALT OR CONCRETE, THE EXISTING ADJACENT SIDEWALK, OR CURB SHALL BE NEATLY SAW CUT. THE SAW CUT SHALL BE IN A NEAT LIY DEEP SO THAT IT RENDERS A SMOOTH VERTICAL FACE TO MATCH TO. IF THE FUL OR DOES NOT SAW DEEP ENOUGH AND THE CUT LINE BREAKS OUT OR CHIPS HEN THE EXISTING SIDE MUST BE RE-CUT SQUARE AND DONE OVER UNTIL IT IS	T.	SEW COM OR F LOCA DEFE RE-T
	U.	J. CON SATU
	v.	/. SANI
	w	V. ALL E

DEPARTMENT OF PUBLIC UTILITES - WATER/WASTEWATER

- A. NEW WATER MAIN VALVES, INCLUDING PRESSURE TAP VALVES, ADJACENT TO AN EXISTING WATER MAIN, AND EXISTING WATER MAIN VALVES SHALL ONLY BE OPERATED BY THE CITY OF NAPERVILLE, DEPARTMENT OF PUBLIC UTILITIES CEE/CM DIVISION PERSONNEL WITH 48-HOUR NOTICE (MONDAY-FRIDAY). CONTACT NAPERVILLE DPU-W/WW 630-420-4122 FOR SCHEDULING.
- B. ANY EXISTING UTILITY STRUCTURES REQUIRING ADJUSTMENT OR RECONSTRUCTION SHALL BE PLETED BY THE CONTRACTOR TO THE SATISFACTION OF THE UTILITY OWNER. ADJUSTMENTS IOT CALLED FOR ON THE PLANS SHALL BE CONSIDERED INCIDENTAL THAN A TOTAL OF 12 INCHES OF ADJUSTING RINGS AND/OR 2 LLOWED. ALL STRUCTURE FRAMES SHALL BE FLUSH WITH FINAL
- MINIMUM OF FIVE (5) FEET HORIZONTALLY FROM UNDERGROUND ARY SEWERS, SANITARY SERVICES, WATER MAINS, AND WATER ISTALLED A MINIMUM OF TEN (10) FEET HORIZONTALLY FROM UTILITY ANCES, INCLUDING, BUT NOT LIMITED TO, MANHOLES, VALVE VAULTS, ANTS. NO TREES, SHRUBS OR OBSTACLES WILL BE ALLOWED 10' IN IND 7' TO THE REAR OF THE ELECTRICAL TRANSFORMER.
- REQUIRED TO RESTRAIN VALVES, FITTINGS, HYDRANTS, AND PIPE JOINT WEDGE ACTION TYPE MEGALUG 1100 SERIES AS N, INC. OR UNI-FLANGE BLOCKBUSTER 1400 SERIES AS TER BOX CO. AND SHALL BE FOR USE ON DUCTILE IRON PIPE C151/A21.51, FOR NOMINAL PIPE SIZES 3" THROUGH 48".
- EMS FOR RESTRAINING PUSH-ON PIPE BELLS SHALL BE MEGALUG
- EMS REQUIRING RESTRAINT SHALL BE MEGALUG SERIES 1100SD NICAL JOINTS.
- BE CLASS 52. ALL DUCTILE IRON PIPE IS TO BE ENCASED IN HYLENE ENCASEMENT TO BE INSTALLED IN ACCORDANCE WITH
- RAWING SHALL BE GIVEN TO THE CITY OF NAPERVILLE UPON ITS SHOWING THE ELEVATION AND LOCATION (TIED TO TWO POINTS) RUCTURES INCLUDING FIRE HYDRANTS, VALVE BOXES AND VAULTS. ERVICE CORPORATION STOPS, WATER MAIN FITTINGS/BENDS, E WYES (MEASURED FROM DOWNSTREAM MANHOLE), AND TARY SERVICE LINES. ALL ELEVATIONS SHOULD BE REFERENCED TO JM AS THE ORIGINAL DESIGN PLANS. HORIZONTAL TIES SHALL BE BACK OF CURB, OR PROPERTY CORNERS.
- SHALL BE PVC PIPE MEETING THE REQUIREMENTS OF ASTM D-2241 ASTM D-3139. ALL SANITARY SEWER FITTINGS SHALL BE PVC QUIREMENTS: 4" TO 12" SHALL BE INJECTION MOLDED FITTINGS FER THAN 12" SHALL BE FABRICATED FITTINGS MEETING ASTM D-2241 RATING SHALL BE 150 PSI.
- HALL BE STANDARD PATTERN, GATE VALVES AND SHALL HAVE THE FACTURER, SIZE AND WORKING PRESSURE PLAINLY CAST IN RAISED VALVES MAY BE APPROVED FROM ONE OF THE FOLLOWING CLOW, WATEROUS OR KENNEDY.
- TS/T-BOLTS. AND WASHERS, TYPE 304 OR BETTER, WILL BE REQUIRED TIONS. THIS WOULD APPLY TO HYDRANTS, TAPPING SLEEVES, , AND OTHER APPURTENANCES BURIED OR IN VALVE VAULTS. FRAINT GLANDS REQUIRE 304 STAINLESS STEEL T-BOLTS. AN BE FACTORY APPLIED TO NUTS OR BOLTS - ANY DAMAGE TO THIS TH FIELD APPLIED APPROVED ANTI-SEIZE COMPOUND THAT IS A NT, BOSTIK NEVER-SEEZ OR APPROVED EQUAL.
- ATE AND/OR ADJUST ANY EXISTING AND/OR NEW HYDRANT TO THE TMENT OF PUBLIC UTILITIES.
- ECTED TO A HYDROSTATIC/LEAKAGE TEST IN ACCORDANCE WITH FICATIONS. TEST PRESSURE SHALL BE NO LESS THAN 150 PSI FOR A VARY BY MORE THAN ± 5 PSI. DURING THE TEST. THE TEST GAUGE CITY AND SHALL BE GLYCERIN OR OIL FILLED, WITH A RANGE OF NOT EMENTS NOT GREATER THAN 5 PSI, 4 " MINIMUM DIAL SIZE, WATER IMPLETED AT THE END OF THE TESTING PERIOD TO SHOW ACTUAL R MAIN DID NOT HAVE TOO MUCH TRAPPED AIR IN THE TESTED
- -W/WW DOES NOT GUARANTEE THAT ANY VALVE OR FITTING IN THE IN SYSTEM WILL HOLD AGAINST A HYDROSTATIC/LEAKAGE TEST. THE ONSIBLE FOR PROVIDING AN ACCEPTABLE PRESSURE TEST WHICH ROUND EXISTING VALVES AND FITTINGS.
- GGED "NOT IN SERVICE" UNTIL ALL TESTING AND DISINFECTION HAS WATER MAIN SECTION IS SERVICE.
- P. SANITARY SEWER AND WATER SHALL BE CONSTRUCTED, TESTED, AND PLACED INTO SERVICE IN ACCORDANCE WITH CITY OF NAPERVILLE STANDARD SPECIFICATION AND SPECIFICATIONS FOR WATER AND SEWER MAIN CONSTRUCTION IN ILLINOIS, LATEST EDITION.
- Q. ALL VALVE BOXES, VAULTS, HYDRANTS, AND MANHOLES SHALL NOT BE COVERED WITH CONSTRUCTION DEBRIS AND SHALL REMAIN ACCESSIBLE TO THE RESPECTIVE UTILITY COMPANY.
- R. WATER SERVICE LINE SMALLER THAN 3" SHALL BE TYPE K COPPER. IF JOINTS ARE REQUIRED DUE TO LENGTH OF SERVICE, THEN ONLY COMPRESSION TYPE COUPLING SHALL BE PERMITTED. NO
- SANITARY MANHOLES SHALL BE TESTED FOR LEAKAGE BY VACUUM TESTING. THE MANHOLE ME AND ADJUSTING RINGS SHALL BE IN PLACE WHEN TESTING. ANY LEAKS SHALL BE REPAIRED M EXTERIOR OF MANHOLE - PATCHING INSIDE OF MANHOLE SHALL NOT BE ACCEPTABLE. A EUUM OF 10" (254 MM) HG SHALL BE PLACE ON THE MANHOLE AND THE TIME SHALL BE MEASURED THE VACUUM TO DROP TO 9" (229 MM) HG. THE VACUUM SHALL NOT DROP BELOW 9" (229 MM) FOR THE FOLLOWING TIME PERIODS FOR EACH SIZE OF MANHOLE:

INCH DIAMETER - 60 SECONDS INCH DIAMETER - 75 SECONDS INCH DIAMETER - 90 SECONDS INCH DIAMETER - 105 SECONDS

SOLDERED OR FLARED TYPE JOINTS ARE ALLOWED.

MANHOLES THAT FAIL THE TEST SHALL BE SEALED AND RE-TESTED UNTIL ACCEPTABLE.

- CONTRACTOR SHALL PROVIDE INTERNAL TELEVISED INSPECTION OF ALL INSTALLED SANITARY /ER, LATERALS, MANHOLES AND CONNECTIONS TO THE PUBLIC SYSTEM. FOLLOWING PLETION OF TELEVISING WORK, THE CONTRACTOR SHALL SUBMIT VIDEO RECORDINGS ON DVD FLASH DRIVE ALONG WITH A COMPREHENSIVE TELEVISING REPORT WHICH WILL INDICATE THE ATION, FOOTAGES AND NATURE OF ANY DEFECTS. PRIOR TO FINAL ACCEPTANCE, THESE ECTS SHALL BE REPAIRED TO THE SATISFACTION OF THE WATER/WASTEWATER UTILITY AND
- ITRACTOR WORK HOURS ARE ONLY ALLOWED FROM 7:00 A.M. TO 5:00 P.M., MONDAY THROUGH URDAY. NO WORK SHALL BE PERMITTED ON SUNDAYS.
- ITARY PIPES WITH LESS THAN 4 FEET OR MORE THAN 25 FEET OF COVER SHALL BE ISTRUCTED OF DUCTILE IRON PIPING (CLASS 50, MINIMUM) AND ENCASED IN POLYWRAP.
- EXCAVATIONS MORE THAN 20 FEET DEEP MUST BE PROTECTED BY A SYSTEM DESIGNED BY A REGISTERED PROFESSIONAL ENGINEER.
- X. CONTRACTOR SHALL MAINTAIN 2' MINIMUM CLEARANCE BETWEEN EXISTING UTILITIES AND NEW FOUNDATIONS AND UNDERGROUND FACILITIES. IN AREAS WHERE FOUNDATIONS AND UNDERGROUND FACILITIES ARE PROPOSED ADJACENT TO EXISTING UTILITIES, THE CONTRACTOR SHALL POT HOLE BY VACUUM EXCAVATION OR HAND EXCAVATION TO LOCATE THE EXISTING UTILITY TO VERIFY MINIMUM CLEARANCE REQUIREMENT.
- Y. FENCES SHALL BE INSTALLED A MINIMUM OF 5 FEET FROM ANY WATER OR SANITARY MAINS WHEN RUNNING PARALLEL WITH THEM. WHERE FENCES ARE INSTALLED CROSSING WATER OR SANITARY MAINS, THE POSTS SHALL BE LOCATED TO HAVE THE MAIN BETWEEN THEM.
- Z. ALL BRASS COMPONENTS SHALL BE CERTIFIED TO BE LEAD FREE IN COMPLIANCE WITH NSF 61 AND NSF 372 AND IDENTIFIED WITH APPLICABLE MARKINGS.


PREPARED BY: REVISIONS REVISED PER CITY OF NAPERVILLE REVIEW 9/09/2022 ROGINA ENGINEERS & SURVEYORS, L.L.C. 1225 Channahon Road Joliet, Illinois 815/729-0777 FAX 815/729-0782 Professional Design Firm License No. 184-006843 - Exp. 4/30/2023


ARCHITECTUAL STUDIOS, LTD 14421 Oakley Avenue Orland Park, IL 60462 (708) 933-4200


SITE DEVELOPMENT PLANS FOR WU'S HOUSE RESTAURANT LOT 2 OF BRADFORD COMMONS RESUBDIVISION OF LOTS 5 & 6 SUBDIVISION CITY OF NAPERVILLE, DUPAGE COUNTY, ILLINOIS


PROJECT NO: **DESIGNED BY:** MRR R990.02 DATE: DRAWN BY: 7/21/2022 CRR SCALE: CHECKED BY N.T.S.


GENERAL NOTES & SPECIFICATIONS

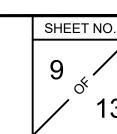


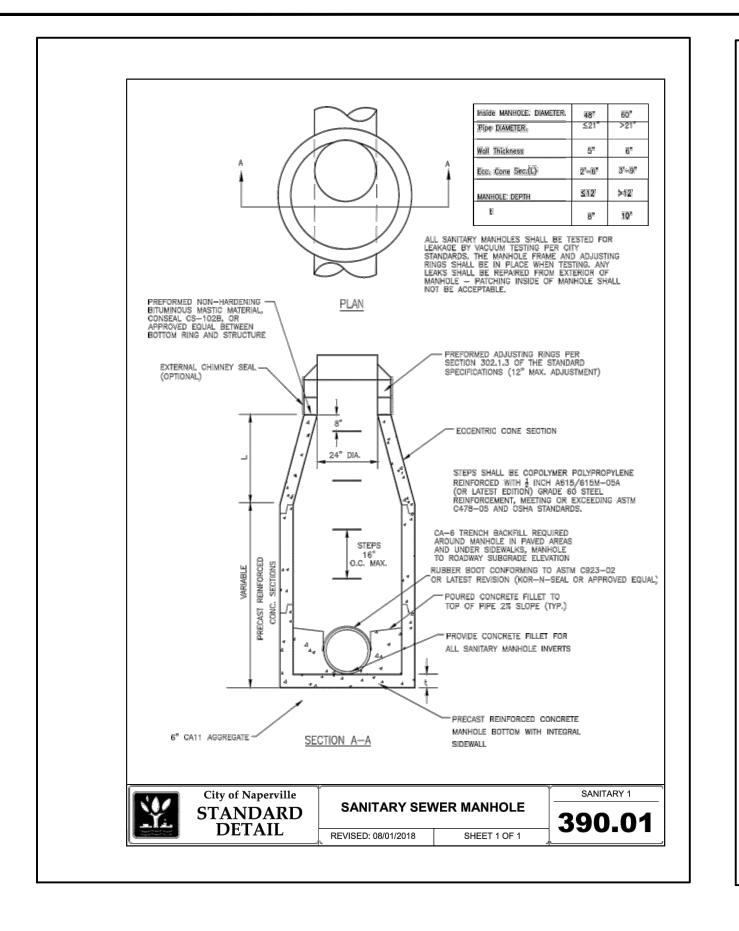


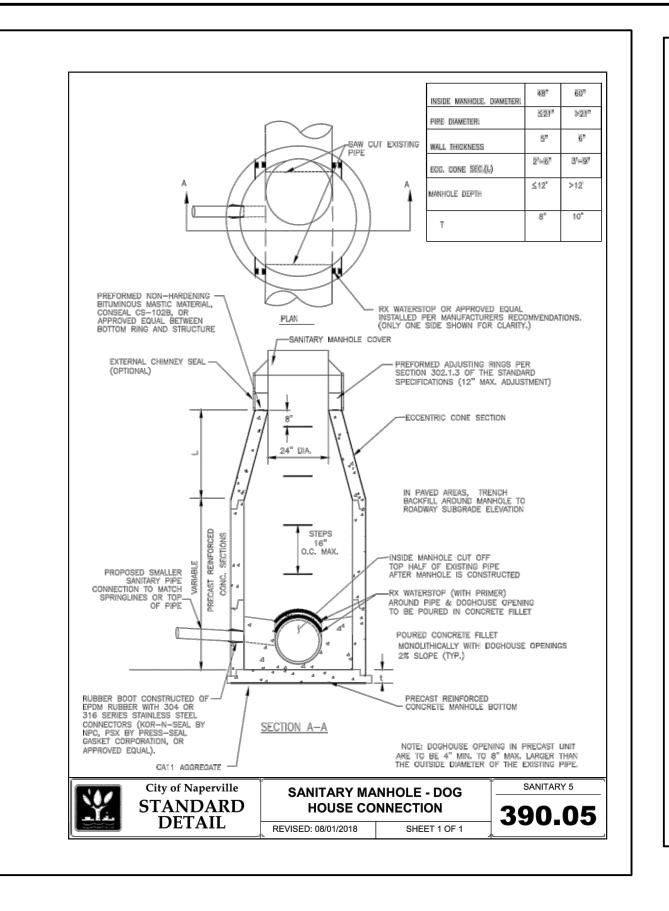

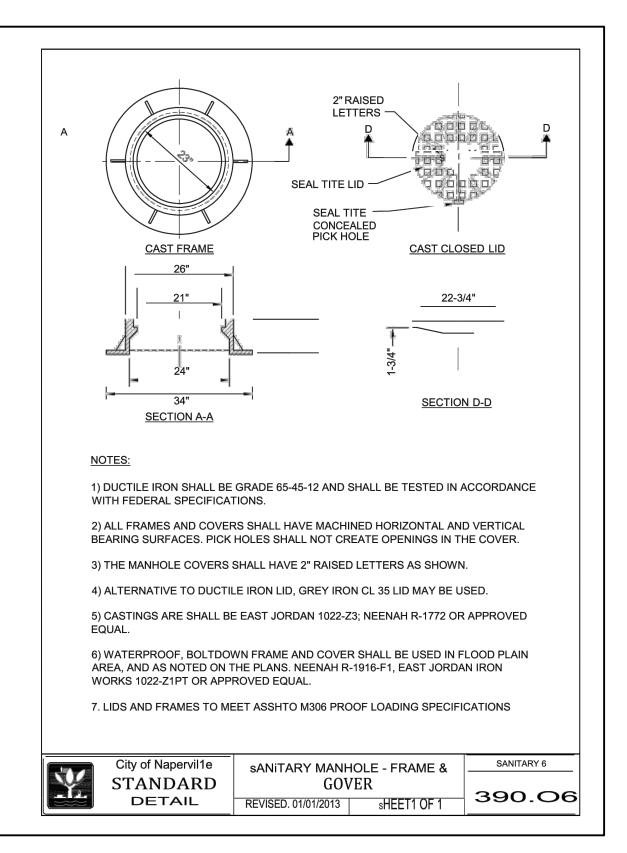

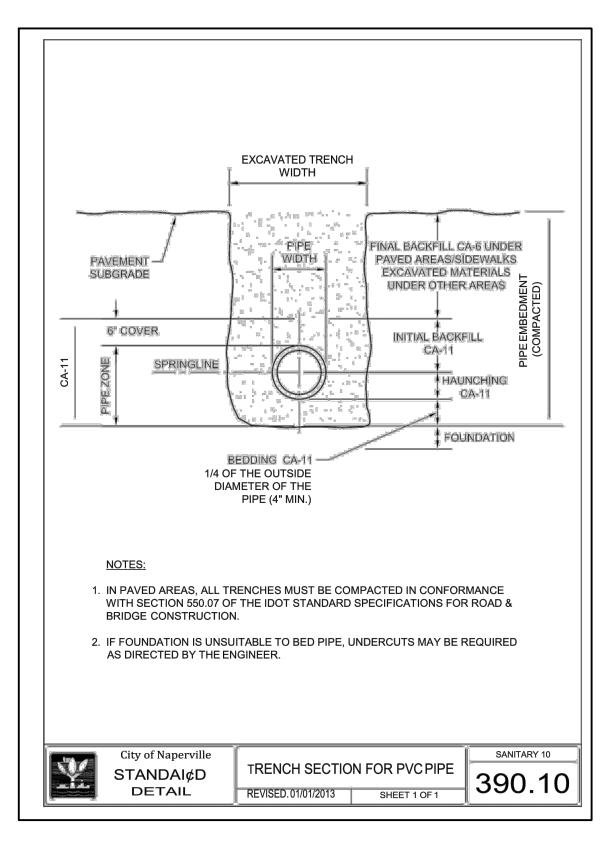

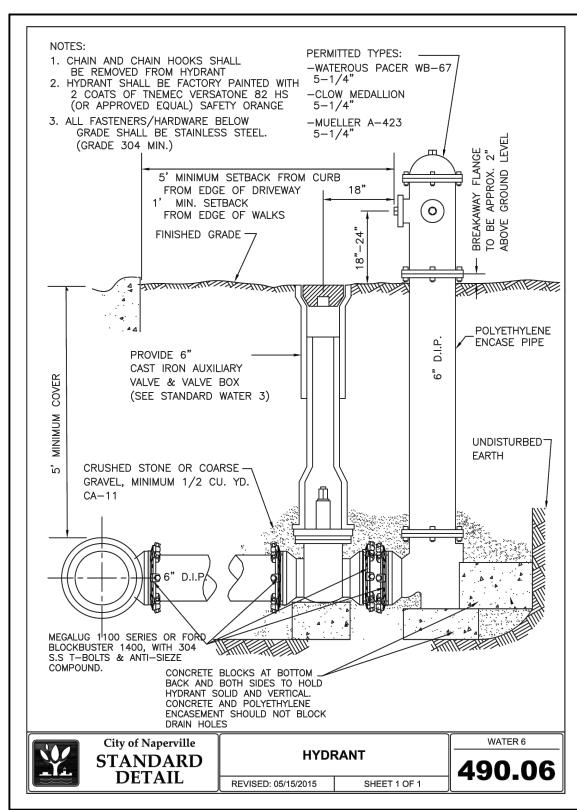

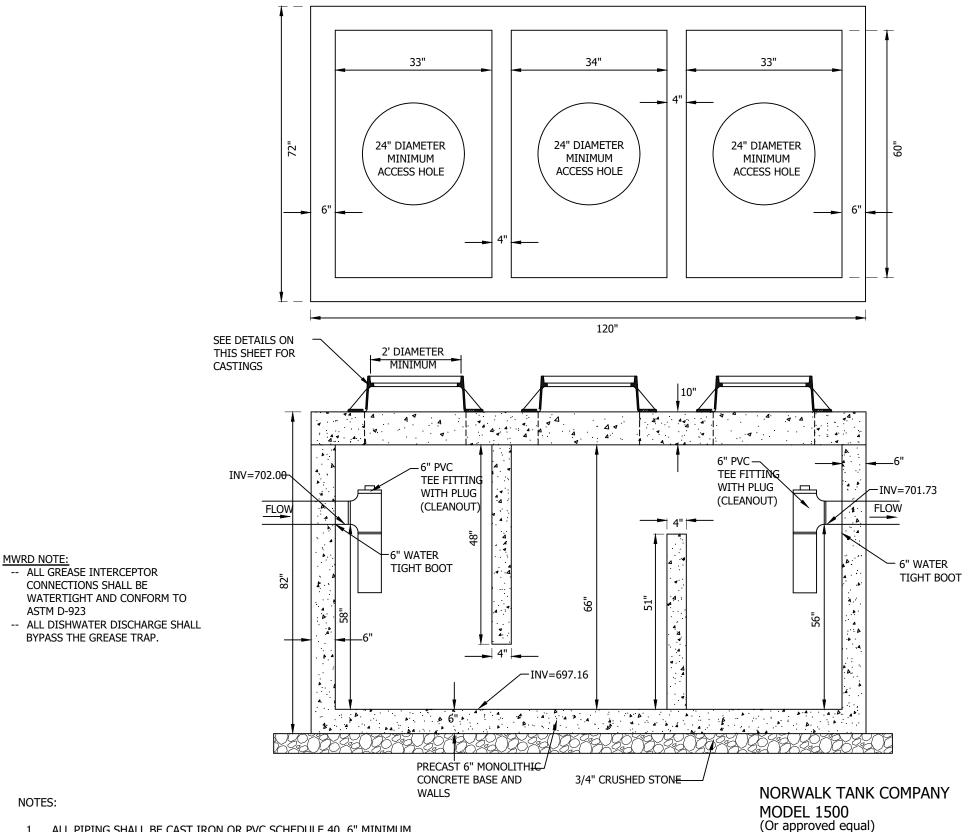



1. ALL PIPING SHALL BE CAST IRON OR PVC SCHEDULE 40, 6" MINIMUM DIAMETER. 2. 4000 P.S.I. CONCRETE AT 28 DAYS SHALL BE USED THROUGHOUT MINIMUM LIQUID CAPACITY SHALL BE 1,500 GALLONS


4. FRAMES AND LIDS SHALL BE AS PER THE VILLAGE OF PALOS PARK STANDARDS AND DETAILS 5. INSTALLATION OF THE GREASE INTERCEPTOR STRUCTURE SHALL BE IN ACCORDANCE WITH ALL OTHER APPLICABLE STANDARDS FOLLOWED BY THE VILLAGE OF PALOS PARK SHOP DRAWINGS SHALL BE SUBMITTED TO THE VILLAGE OF PALOS PARK FOR APPROVAL WHEN PRE-MANUFACTURED STRUCTURES ARE TO BE USED

ALL WASTE CONTAINING GREASE SHALL BE DISCHARGED TO A GREASE INTERCEPTOR OR GREASE TRAP BEFORE DISCHARGE INTO THE SANITARY SEWER WITH THE EXCEPTION OF RESTAURANT DISHWASHERS, WHICH SHALL HAVE THEIR DISCHARGE BYPASS THE GREASE SEPERATOR OR GREASE TRAP AND DISCHARGE DIRECTLY TO OR INDIRECTLY TO THE

SANITARY SEWER GREASE INTERCEPTOR DETAIL

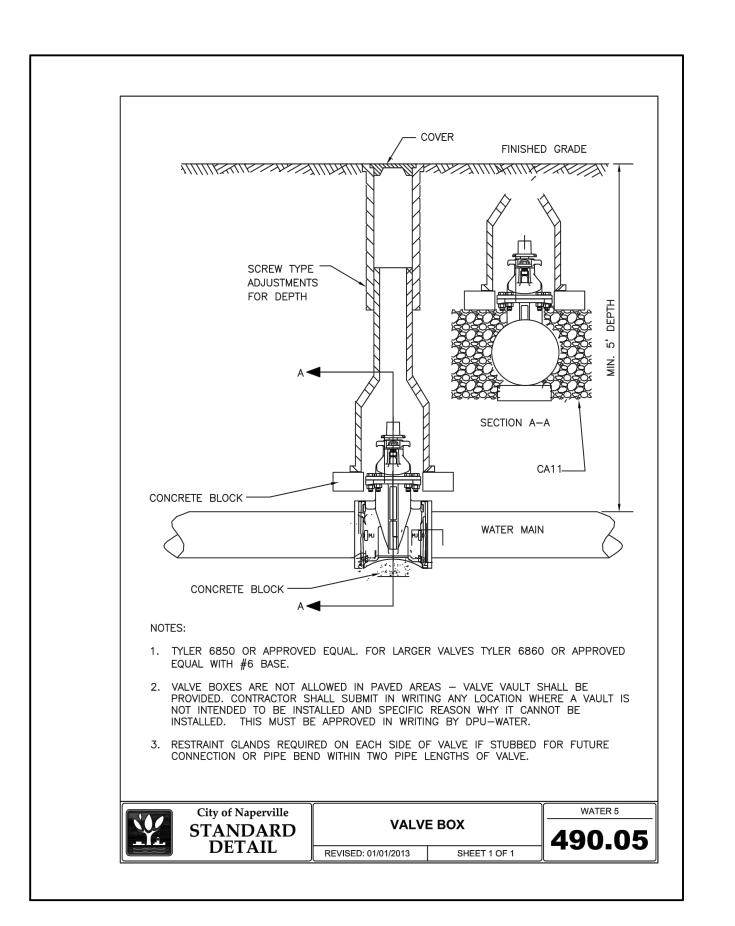

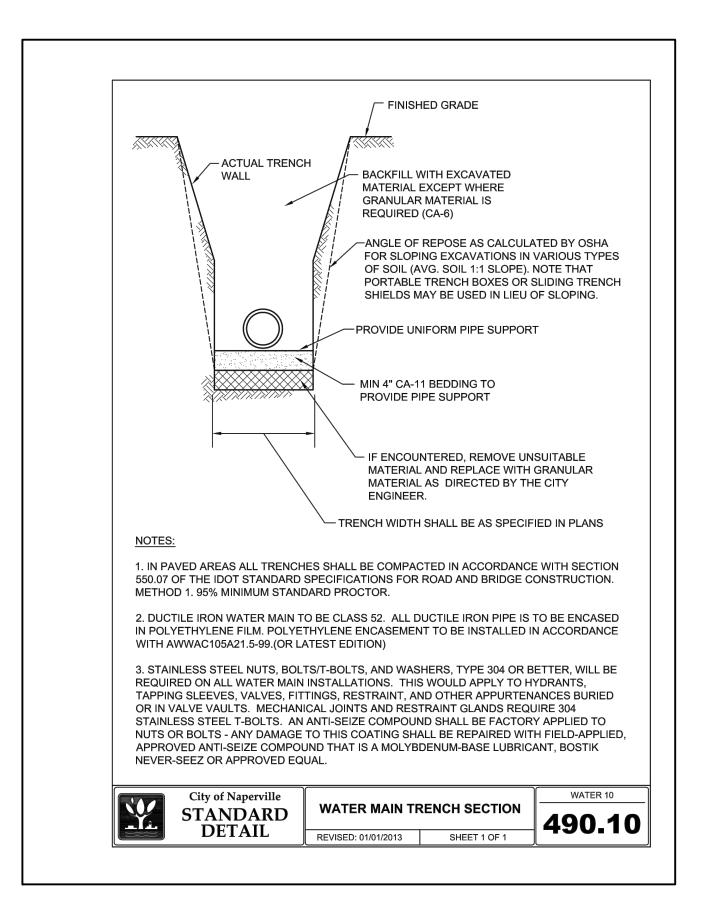

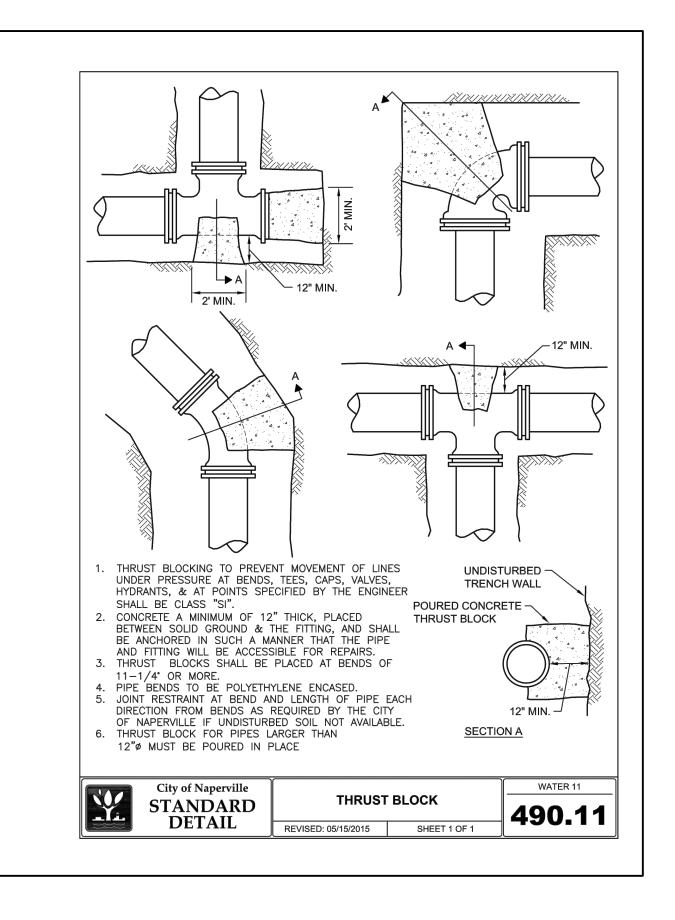

Copyright © 2022 ROGINA Engineers & Surveyors LLC, All Rights Reserved

REVISIONS

ROGINA ENGINEERS & SURVEYORS, L.L.C. Professional Design Firm License No. 184-006843 - Exp. 4/30/2023

ARCHITECTUAL STUDIOS, LTD 14421 Oakley Avenue Orland Park, IL 60462 (708) 933-4200


SITE DEVELOPMENT PLANS FOR WU'S HOUSE RESTAURANT LOT 2 OF BRADFORD COMMONS RESUBDIVISION OF LOTS 5 & 6 SUBDIVISION


CITY OF NAPERVILLE, DUPAGE COUNTY, ILLINOIS


PROJECT NO: **DESIGNED BY:** MRR R990.02 DATE: DRAWN BY: 7/21/2022 CRR SCALE: CHECKED BY N.T.S.


CONSTRUCTION **DETAILS**




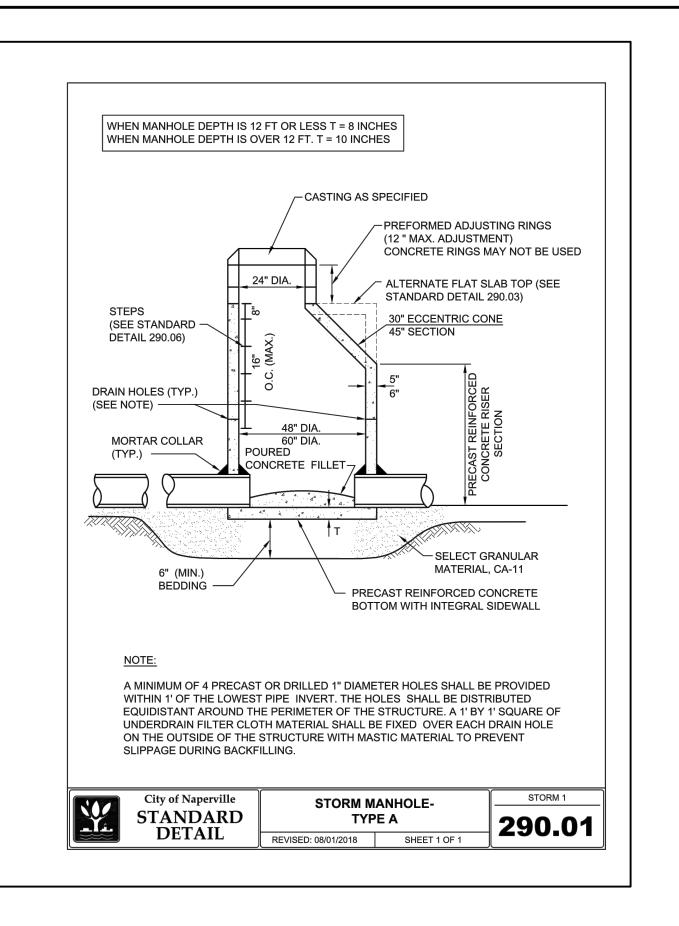


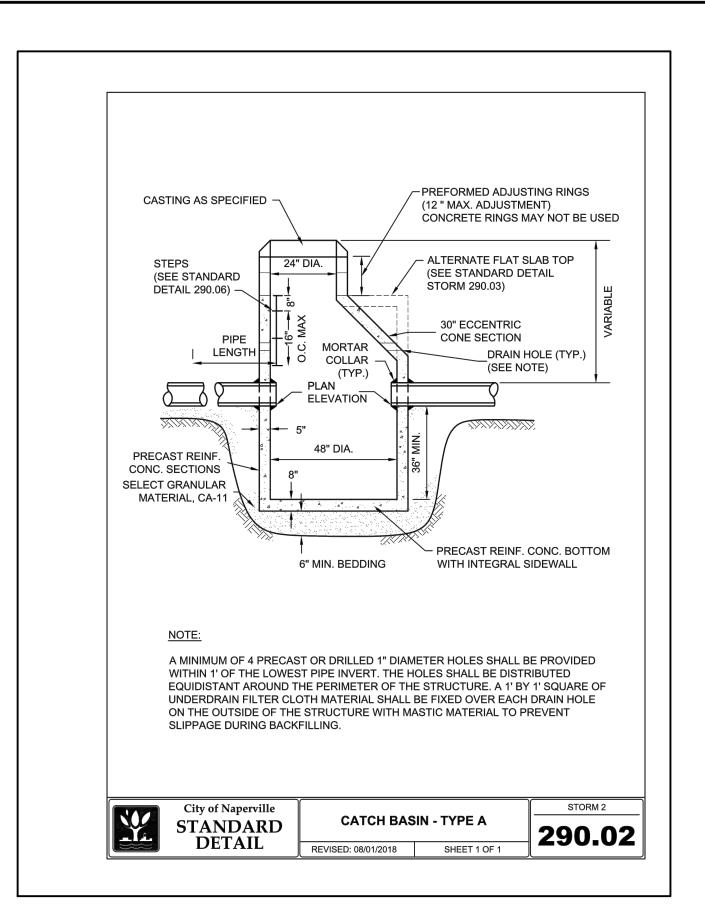


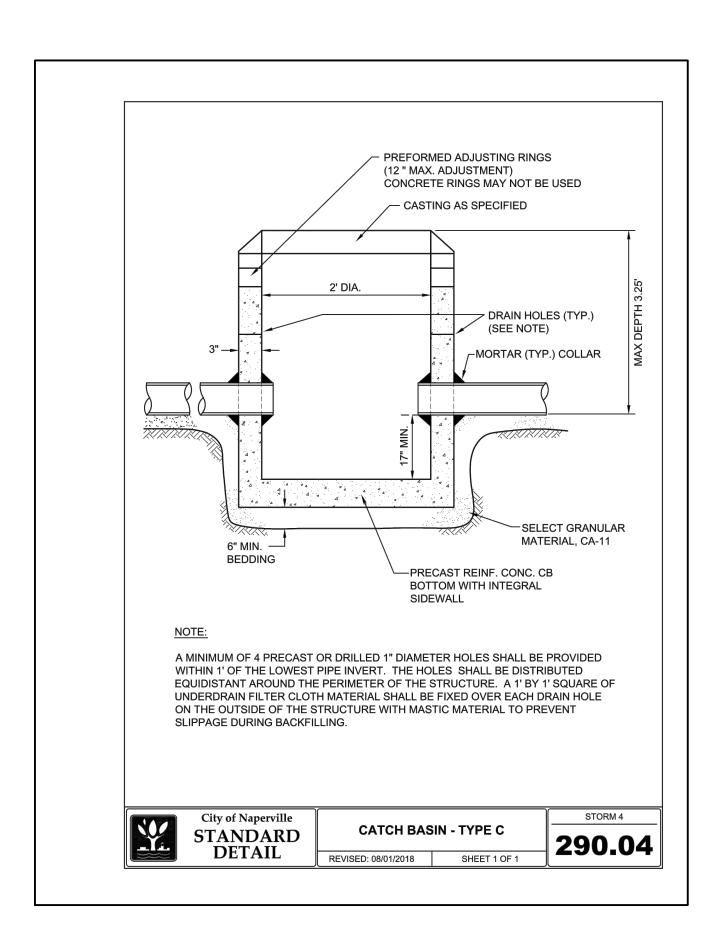


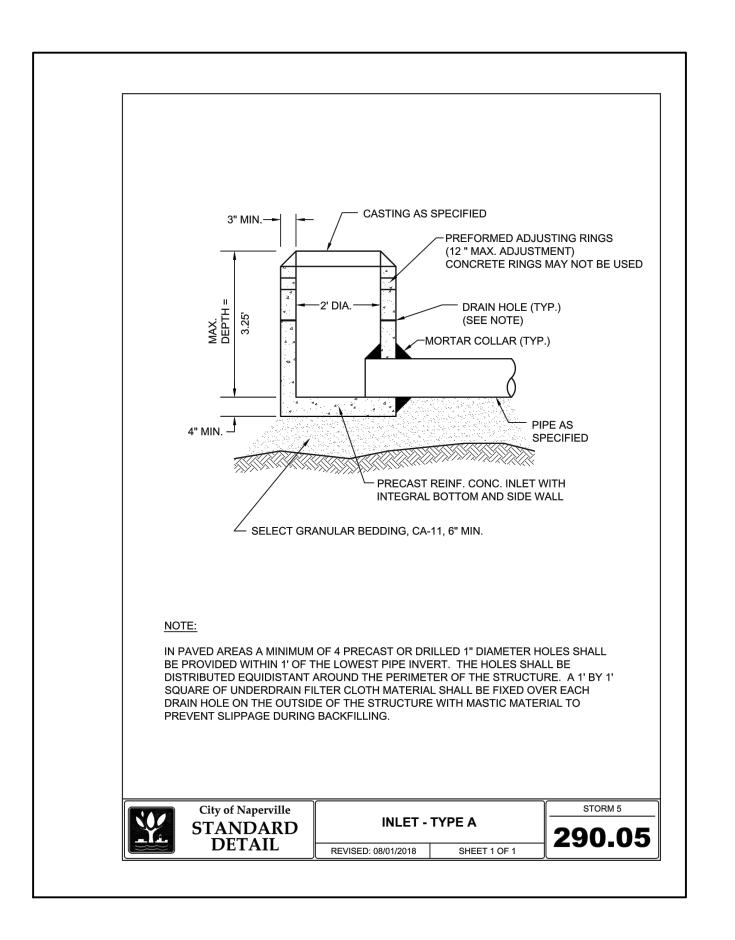

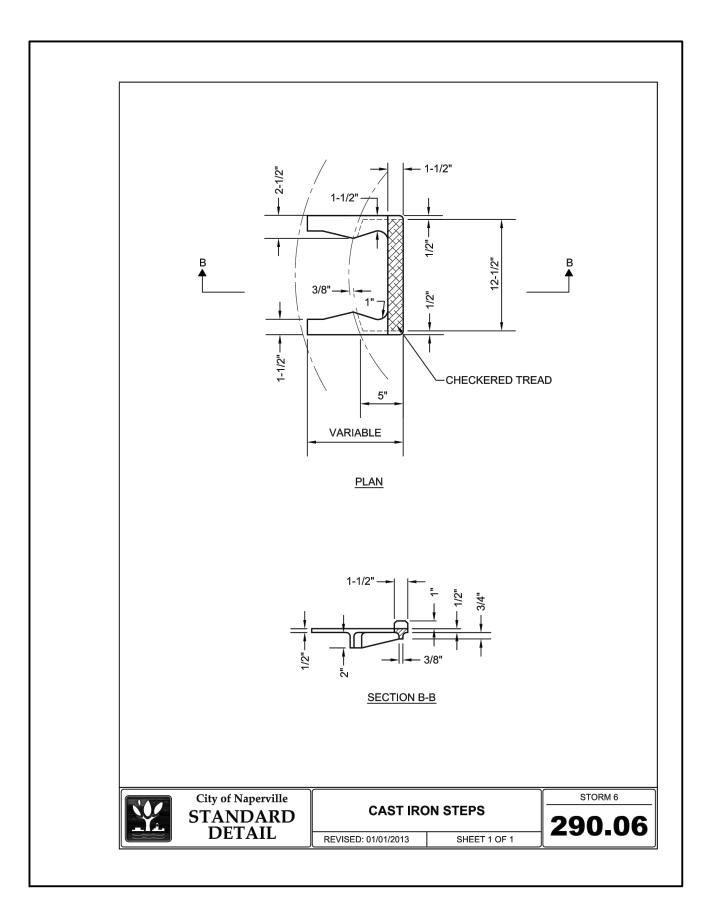

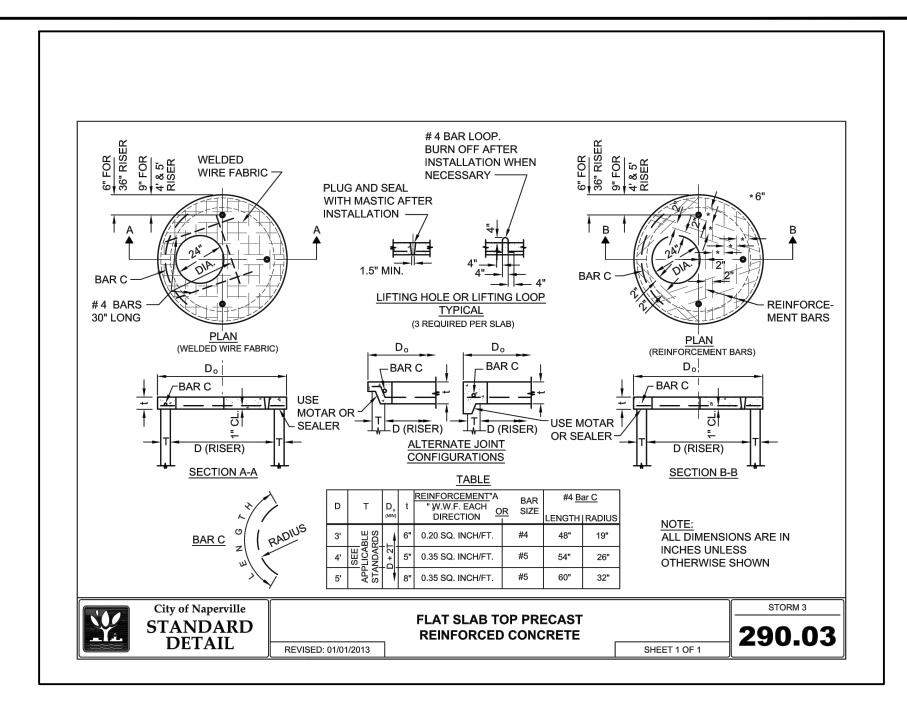

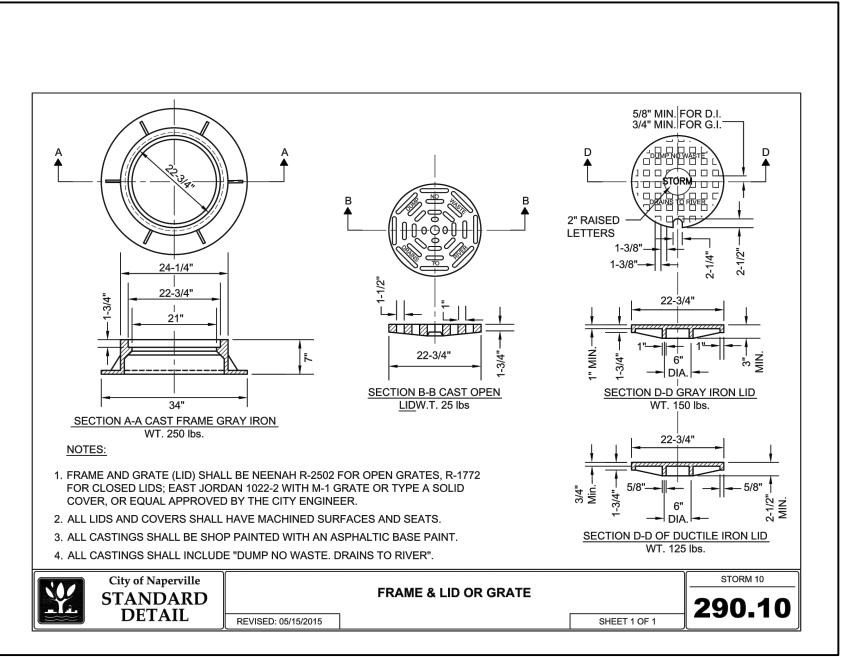

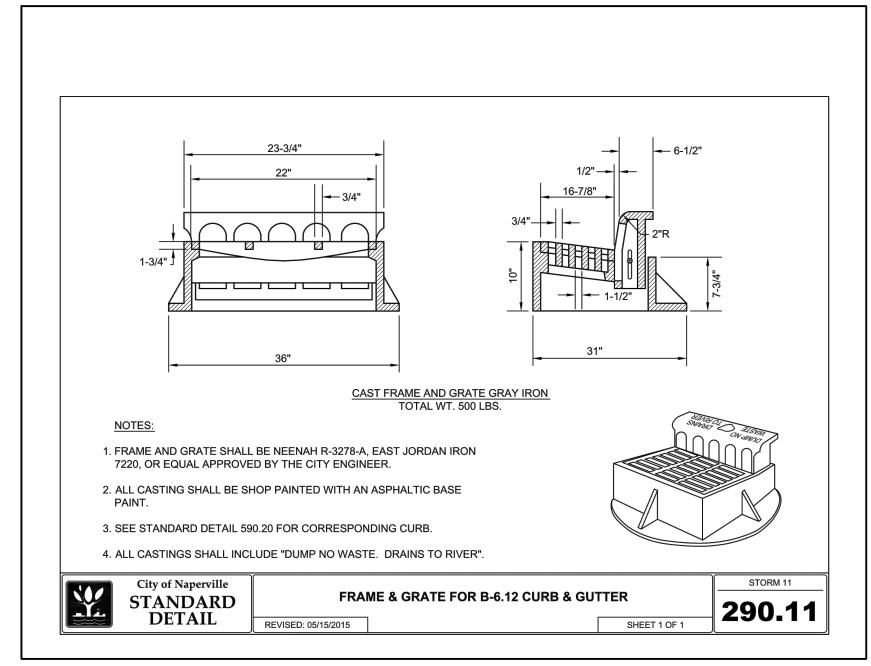



ARCHITECTUAL STUDIOS, LTD 14421 Oakley Avenue Orland Park, IL 60462 (708) 933-4200 PROJECT: SITE DEVELOPMENT PLANS FOR

WU'S HOUSE RESTAURANT

LOT 2 OF BRADFORD COMMONS RESUBDIVISION OF

LOTS 5 & 6 SUBDIVISION

CITY OF NAPERVILLE, DUPAGE COUNTY, ILLINOIS

PROJECT NO:
R990.02

DATE:
7/01/2022


SCALE:
N.T.S.


DESIGNED BY:
MRR


DRAWN BY:
CRR


CHECKED BY:
MRR


CONSTRUCTION DETAILS

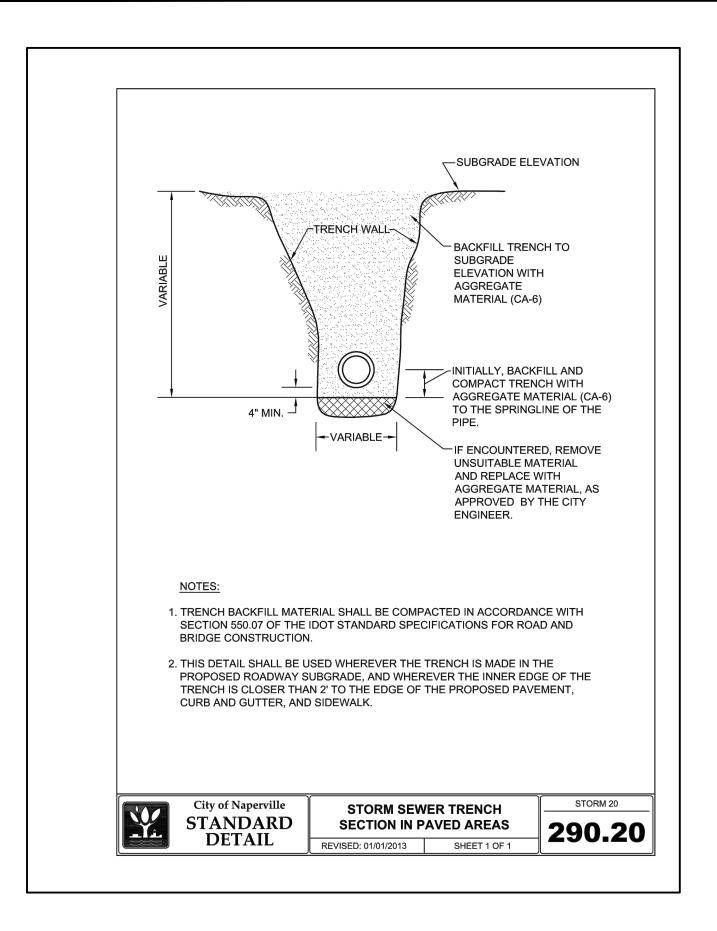


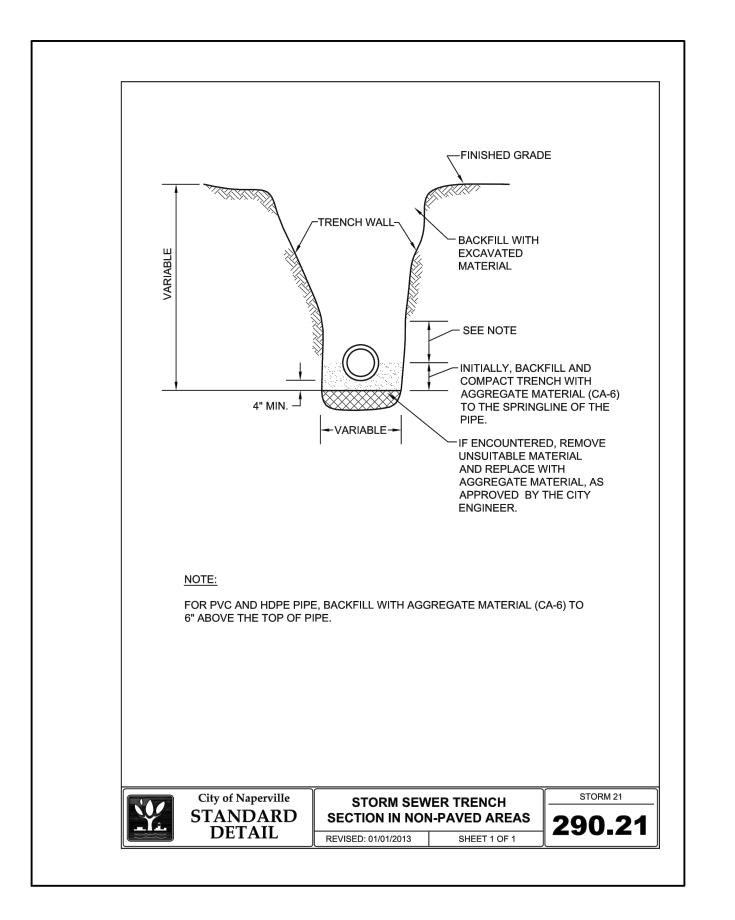


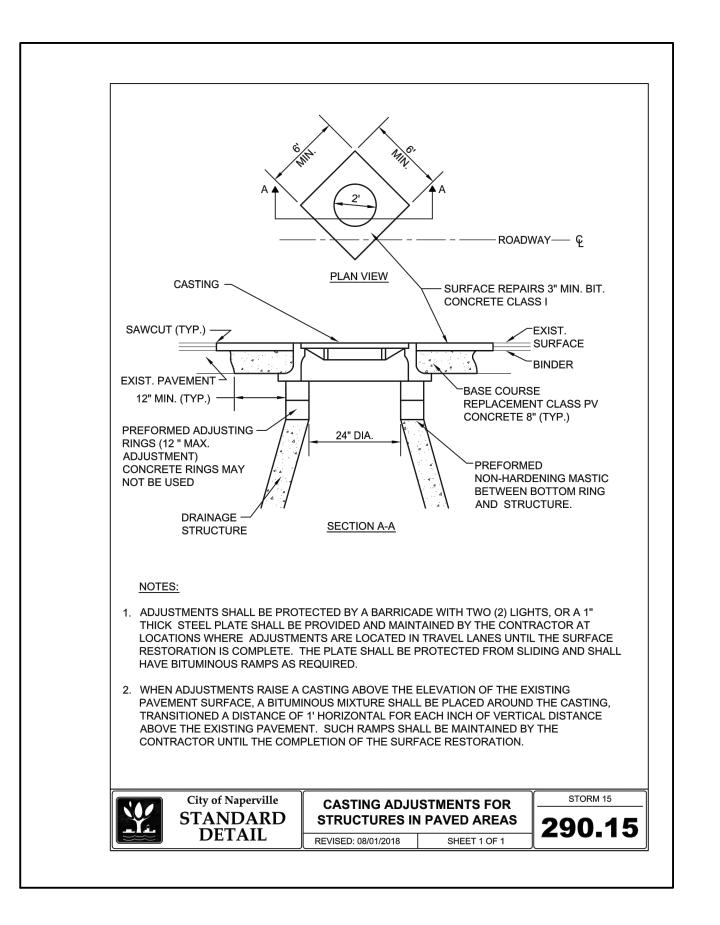


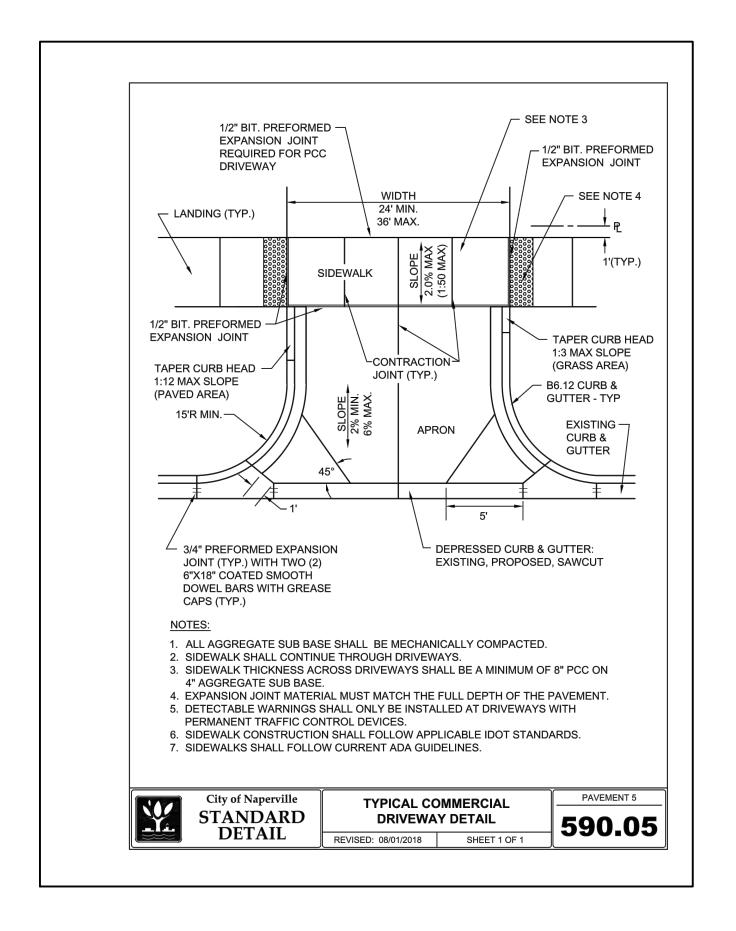

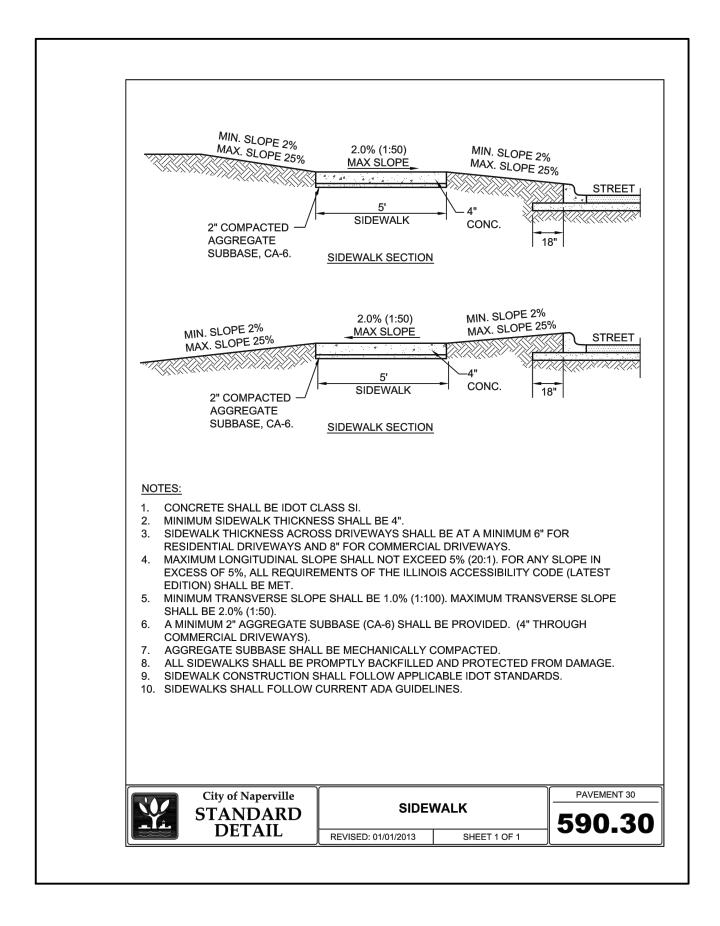

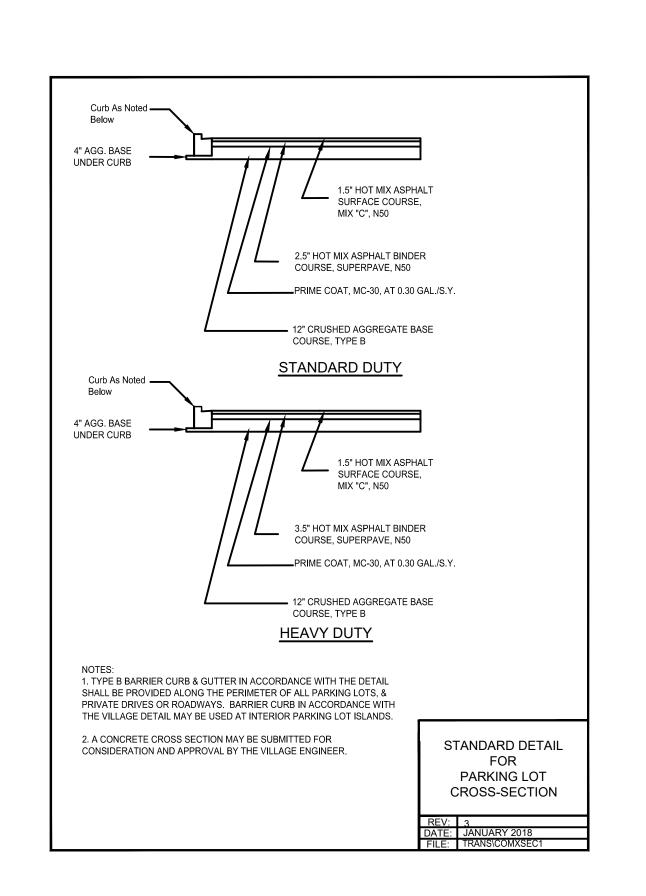

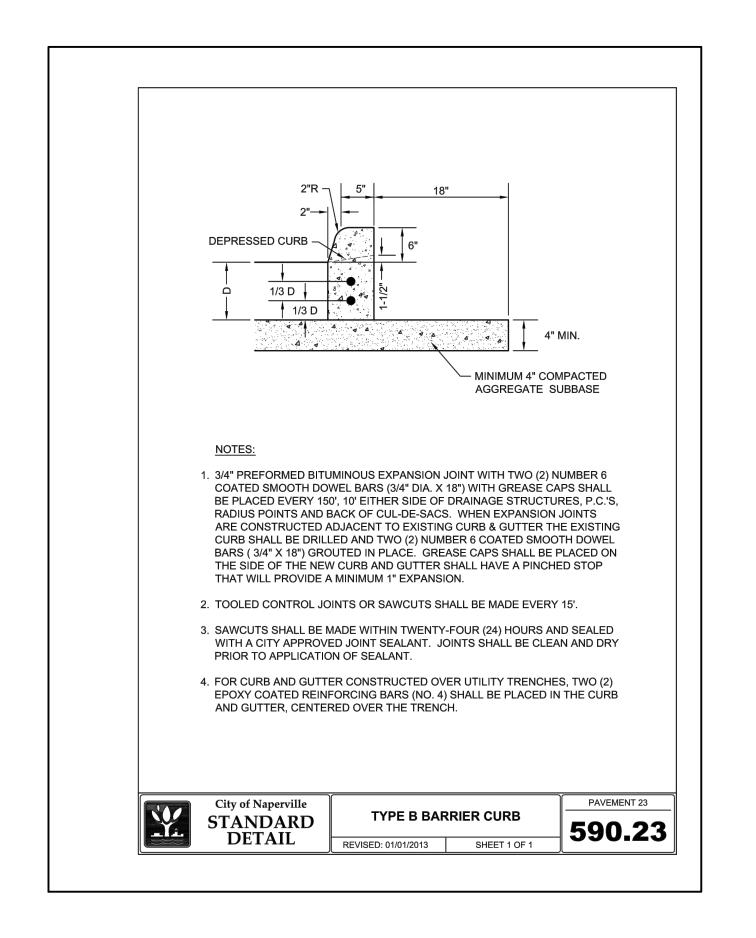

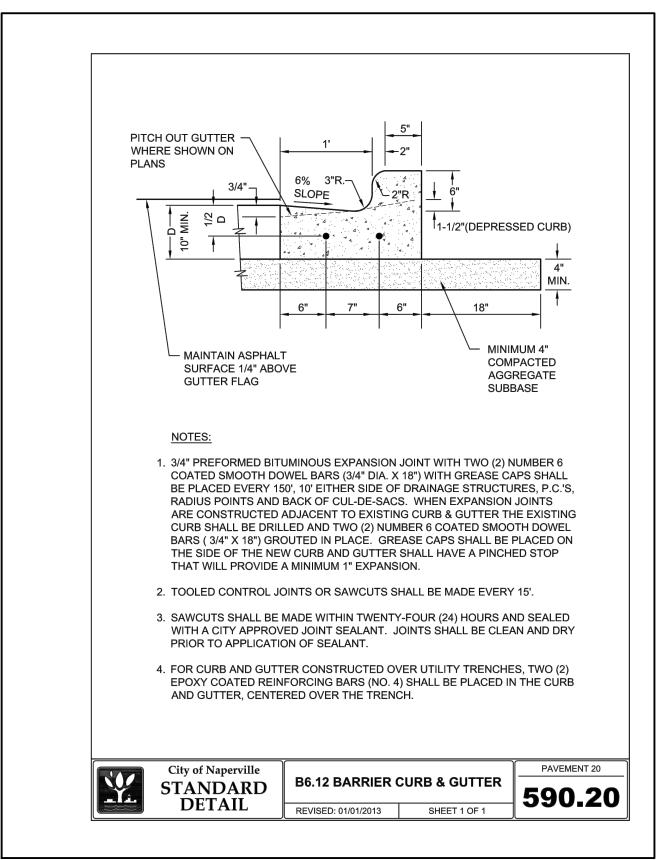

Copyright © 2022 ROGINA Engineers & Surveyors LLC, All Rights Reserved

ARCHITECTUAL STUDIOS, LTD 14421 Oakley Avenue Orland Park, IL 60462 (708) 933-4200

PROJECT: SITE DEVELOPMENT PLANS FOR
WU'S HOUSE RESTAURANT
LOT 2 OF BRADFORD COMMONS RESUBDIVISION OF
LOTS 5 & 6 SUBDIVISION

CITY OF NAPERVILLE, DUPAGE COUNTY, ILLINOIS

PROJECT NO:
R990.02

DATE:
7/\(\text{Q1}\)/2022


SCALE:
N.T.S.


DESIGNED BY:
MRR


DRAWN BY:
CRR


CHECKED BY:
MRR


CONSTRUCTION DETAILS

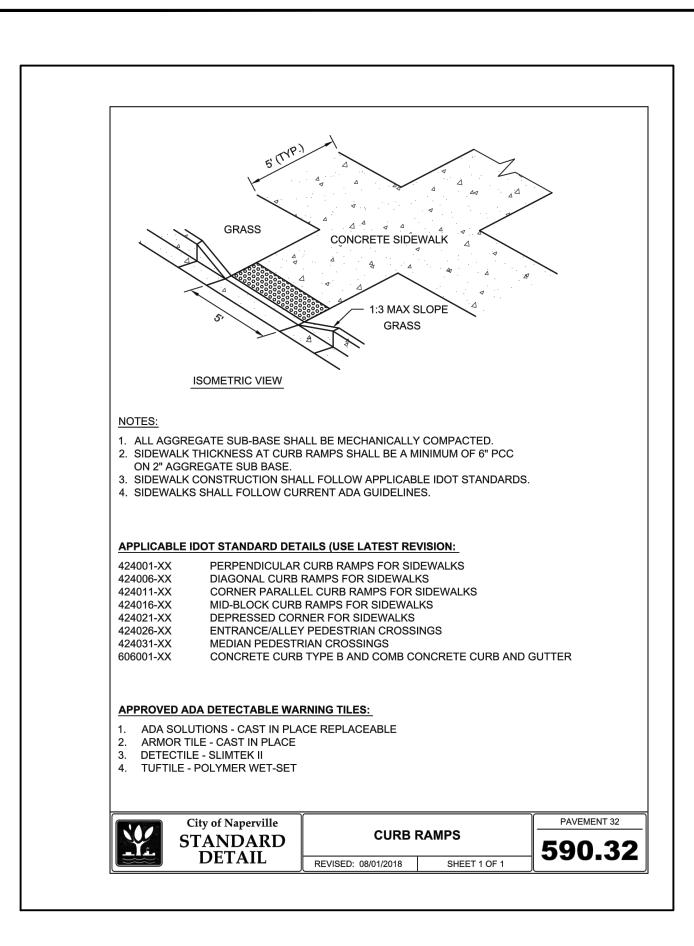

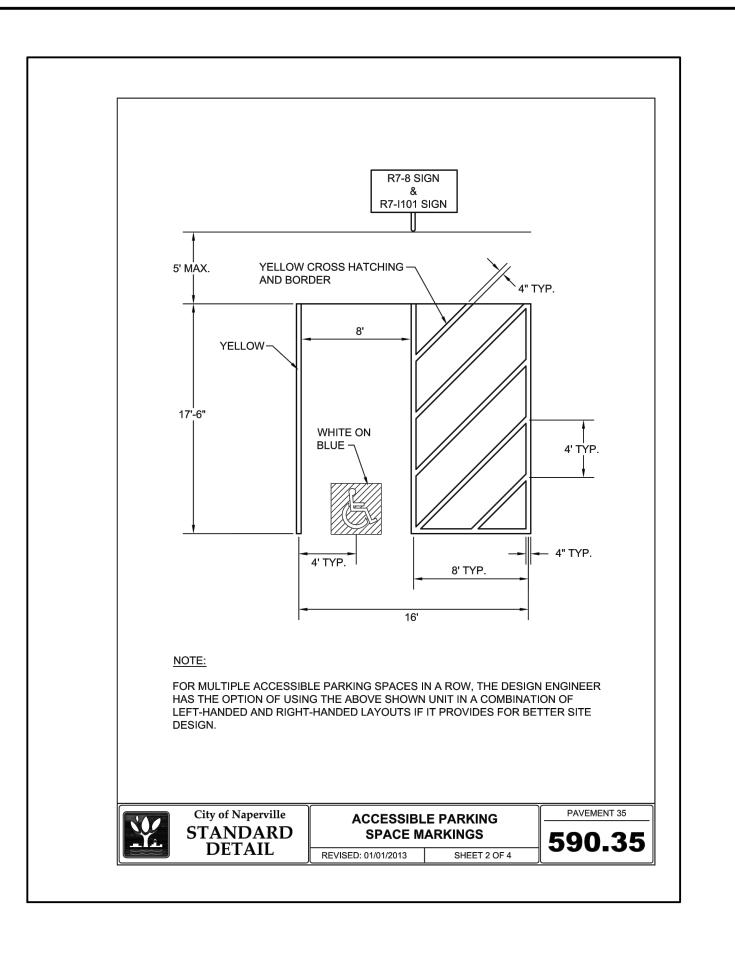

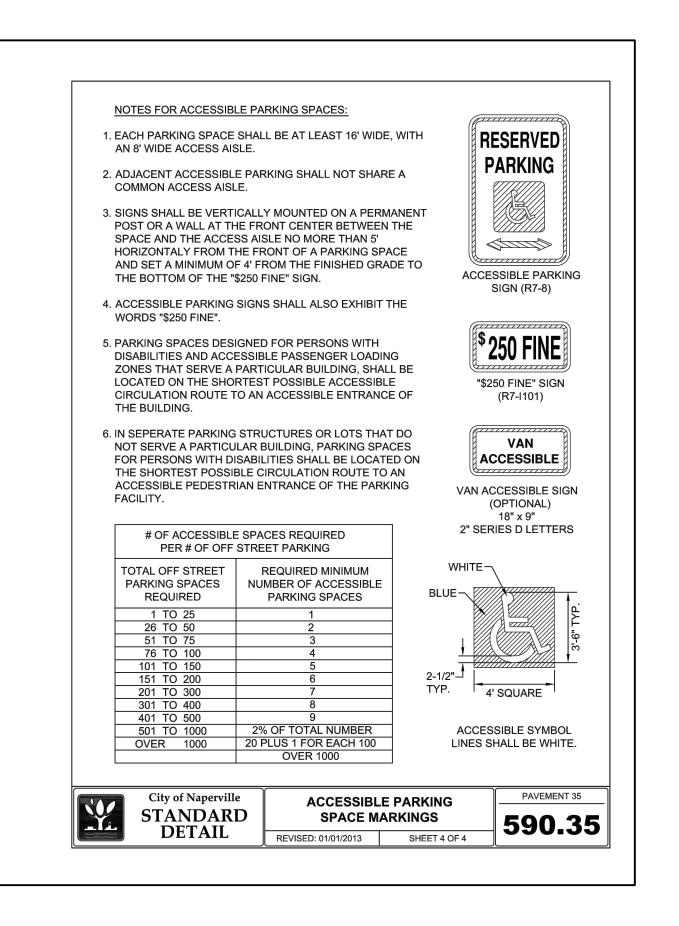

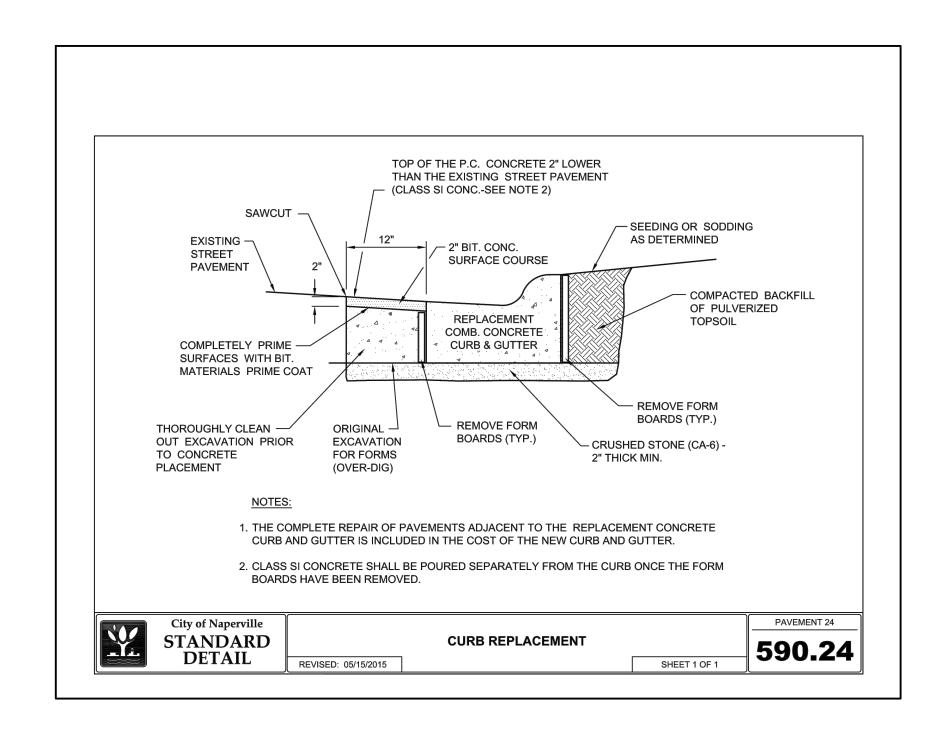

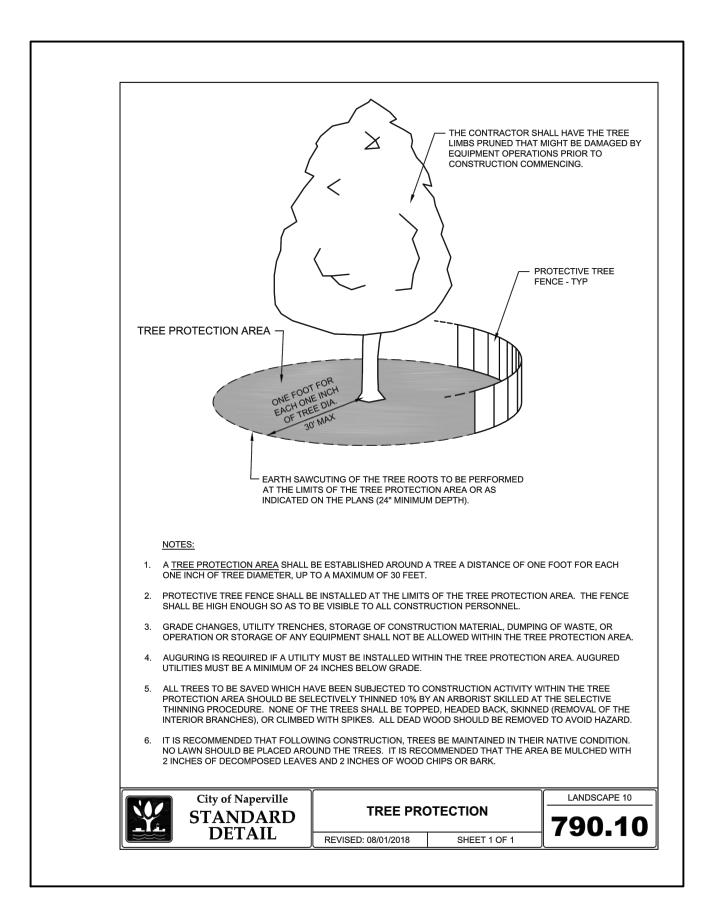

Copyright © 2022 ROGINA Engineers & Surveyors LLC, All Rights Reserved

 REVISIONS
 PREPAR

 1
 6
 —
 —
REPARED BY:

ROGINA

ENGINEERS & SURVEYORS, L.L.C.

1225 Channahon Road Joliet, Illinois 815/729-0777 FAX 815/729-0782

Professional Design Firm License No. 184-006843 - Exp. 4/30/2023

ARCHITECTUAL STUDIOS, LTD 14421 Oakley Avenue Orland Park, IL 60462 (708) 933-4200 SITE DEVELOPMENT PLANS FOR
WU'S HOUSE RESTAURANT
LOT 2 OF BRADFORD COMMONS RESUBDIVISION OF
LOTS 5 & 6 SUBDIVISION
CITY OF NAPERVILLE, DUPAGE COUNTY, ILLINOIS

PROJECT NO:
R990.02

DATE:
7/01/2022

SCALE:
N.T.S.

DESIGNED BY:
MRR

DRAWN BY:
CRR

CHECKED BY:
MRR

CONSTRUCTION DETAILS